CONSTRUCTION PLANS FOR

EAST CULPEPPER WATER CONNECTION FOR NORTH STAR MUTUAL DOMESTIC WATER CONSUMERS ASSOCIATION, INC. SAN JUAN COUNTY, NEW MEXICO SEPTEMBER 2021

ERIC GARTNER, PE

NMED CPB

INDEX

SHEET	DWG.	DESCRIPTION
NO.	NO.	
01	G-01	COVER SHEET
02	G-02	GENERAL NOTES AND LEGEND
03	G-03	GEOTECHNICAL NOTES
04	G-04	HORIZONTAL LAYOUT [1 OF 5]
05	G-05	HORIZONTAL LAYOUT [2 OF 5]
06	G-06	HORIZONTAL LAYOUT [3 OF 5]
07	G-07	HORIZONTAL LAYOUT [4 OF 5]
80	G-07	HORIZONTAL LAYOUT [5 OF 5]
09	G-08	SURVEY CONTROL
10	\sim 00	HADDVIII IC DDUEII E

CIVIL SHEETS

C-25

D-01

D-02

D-03

DETAILS

11	C-01	TRANSMISSION LINE	STA. 10+00 TO STA. 21+00 PLAN AND PROFILE
12	C-02	TRANSMISSION LINE	STA. 21+00 TO STA. 32+00 PLAN AND PROFILE
13	C-03	TRANSMISSION LINE	STA. 32+00 TO STA. 43+00 PLAN AND PROFILE
14	C-04	TRANSMISSION LINE	STA. 43+00 TO STA. 54+00 PLAN AND PROFILE
15	C-05	TRANSMISSION LINE	STA. 54+00 TO STA. 65+00 PLAN AND PROFILE
16	C-06	TRANSMISSION LINE	STA. 65+00 TO STA. 76+00 PLAN AND PROFILE
17	C-07	TRANSMISSION LINE	STA. 76+00 TO STA. 87+00 PLAN AND PROFILE
18	C-08	TRANSMISSION LINE	STA. 87+00 TO STA. 98+00 PLAN AND PROFILE
19	C-09	TRANSMISSION LINE	STA. 98+00 TO STA. 109+00 PLAN AND PROFILE
20	C-10	TRANSMISSION LINE	STA. 109+00 TO STA. 120+00 PLAN AND PROFILE
21	C-11	TRANSMISSION LINE	STA. 120+00 TO STA. 131+00 PLAN AND PROFILE
22	C-12	TRANSMISSION LINE	STA. 131+00 TO STA. 142+00 PLAN AND PROFILE
23	C-13	TRANSMISSION LINE	STA. 142+00 TO STA. 153+00 PLAN AND PROFILE
24	C-14	TRANSMISSION LINE	STA. 153+00 TO STA. 164+00 PLAN AND PROFILE
25	C-15	TRANSMISSION LINE	STA. 164+00 TO STA. 175+00 PLAN AND PROFILE
26	C-16	TRANSMISSION LINE	STA. 175+00 TO STA. 186+00 PLAN AND PROFILE
27	C-17	TRANSMISSION LINE	STA. 186+00 TO STA. 197+00 PLAN AND PROFILE
28	C-18	TRANSMISSION LINE	STA. 197+00 TO STA. 208+00 PLAN AND PROFILE
29	C-19	TRANSMISSION LINE	STA. 208+00 TO STA. 219+00 PLAN AND PROFILE
30	C-20	TRANSMISSION LINE	STA. 219+00 TO STA. 230+00 PLAN AND PROFILE
31	C-21	TRANSMISSION LINE	STA. 230+00 TO STA. 241+00 PLAN AND PROFILE
32	C-22	TRANSMISSION LINE	STA. 241+00 TO STA. 248+04.08 PLAN AND PROFILE
33	C-23	BOOSTER STATION SITE PLA	AN
34	C-24	BOOSTER STATION AND TAN	IK GRADING PLAN

SUCTION, AND DISCHARGE PROFILES

BOOSTER STATION DETAILS

EXISTING TANK SITE PLAN

CIVIL DETAILS

CIVIL DETAILS

CIVIL DETAILS

STRUCTURAL SHEETS

SHEET DWG.	DESCRIPTION
NO. NO.	
/1 S 01	BUOSTED STATION FOLINDATION

41 S-01 BOOSTER STATION FOUNDATION

ELECTRICAL SHEETS


42	E-01	ELECTRICAL GENERAL NOTES
43	E-02	ELECTRICAL AND SYMBOLS AND LEGEND
44	E-03	ELECTRICAL POWER ONE LINE DIAGRAM AND SCHEDULE
45	E-04	BOOSTER STATION ELECTRICAL SITE PLAN
46	E-05	EXISTING TANK ELECTRICAL SITE PLAN
47	E-06	SCADA SYSTEM NETWORK DIAGRAM
48	E-07	ELECTRICAL DETAILS


TRAFFIC SHEETS

49 T-01 TRAFFIC CONTROL PLAN

SAP 20-E4067-STBR SAP 20-E2179-STB

DATE

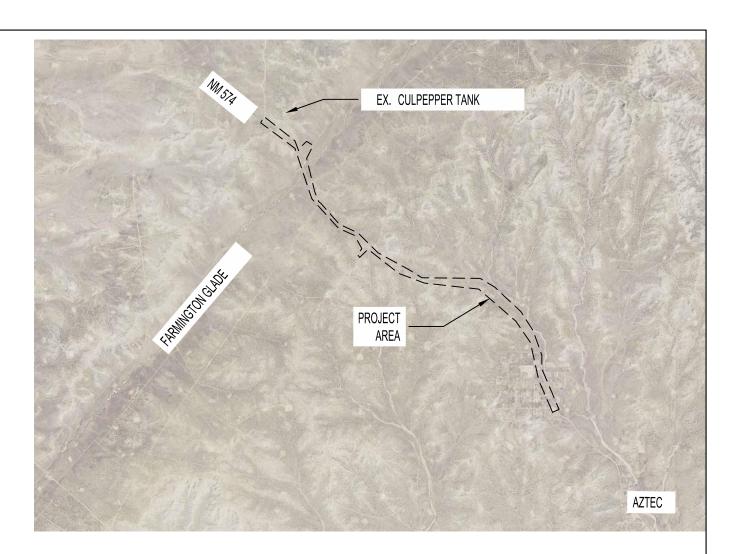

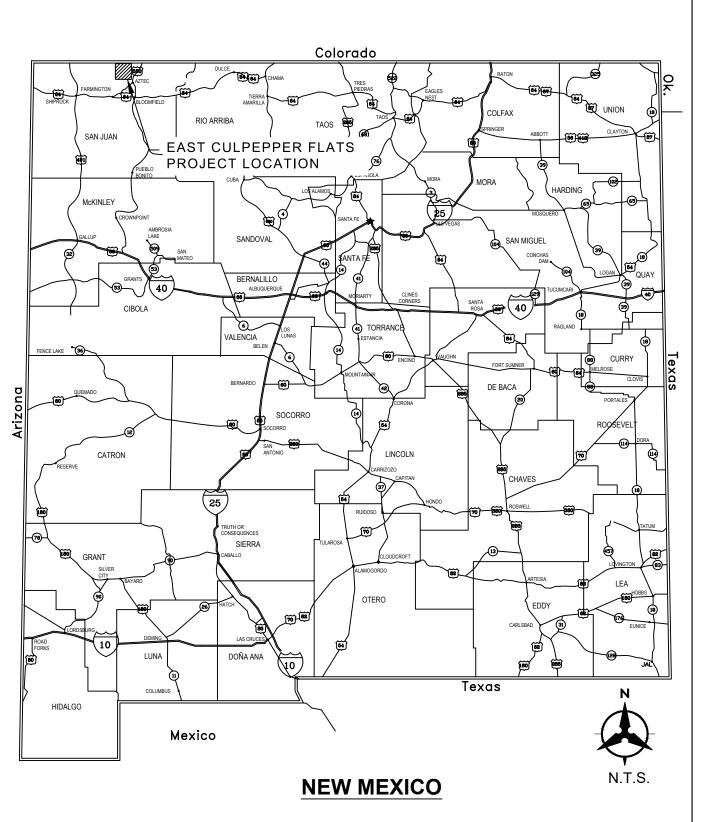






DATE

NOTICE OF EXTENDED PAYMENT PROVISION: THIS CONTRACT ALLOWS THE OWNERS TO MAKE PAYMENT WITHIN 45 DAYS AFTER SUBMISSION OF AN UNDISPUTED REQUEST FOR PAYMENT.

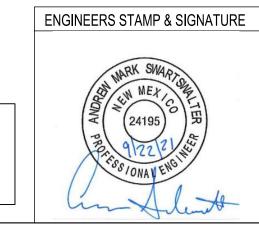

LLOYD AYLIFFE NORTH STAR WATER	DATE	Bohannan www.bhinc.com	Huston 800.877.5332

NICK PORELL, PE

SAN JUAN COUNTY

SAN JUAN COUNTY
EAST CULPEPPER WATER CONNECTION
PHSE 1: TRANSMISSION LINE AND BOOSTER STATION
COVER SHEET

BHI PROJECT NO. 20190029 DWG NO. G-01 SHEET 01 OF 49

Wed, 22-Sep-2021 - 1:19:pm, Plotted by: ASWARTSWALTER P:\20190029\WR\Design\plans\20190029_01_G-01_Cover_Sheet.dwg

GENERAL NOTES

- 1. ABIDE BY ALL LOCAL, STATE, AND FEDERAL LAWS, RULES AND REGULATIONS WHICH APPLY TO THE CONSTRUCTION OF THESE IMPROVEMENTS.
- 2. PRIOR TO CONSTRUCTION ACTIVITIES, VERIFY THE HORIZONTAL AND VERTICAL LOCATIONS OF ALL EXISTING UTILITIES AND OBSTRUCTIONS WITH POTENTIAL TO CHANGE PIPE ALIGNMENT. ALL EXISTING UTILITY ELEVATION DATA REPRESENTED ON THE PROFILE ARE APPROXIMATE. FIELD MEASUREMENTS FROM SURVEYING OF MANHOLES OR AVAILABLE AS-BUILTS. PROFILE ELEVATIONS FOR GRAVITY LINES SUCH AS STORM AND SANITARY SEWER WERE CALCULATED AND NOT POTHOLED. DATA POINTS NOT VERIFIED FROM POTHOLING, LABELED AS "DEPTH UNK". NEITHER THE ENGINEER NOR THE OWNER ASSUMES RESPONSIBILITY FOR COMPLETENESS OR INTERPRETATION OF SUCH SUPPLEMENTARY INFORMATION. IF NEW CONFLICTS ARE IDENTIFIED THE CONTRACTOR SHALL INFORM THE ENGINEER IN WRITING WITHIN 24 HOURS OF DISCOVERY.
- 3. ALL ELECTRICAL, TELEPHONE, CABLE TV, GAS AND OTHER UTILITY LINES, CABLES AND APPURTENANCES ENCOUNTERED DURING CONSTRUCTION THAT REQUIRE RELOCATION, SHALL BE COORDINATED WITH THAT UTILITY. COORDINATE ALL NECESSARY UTILITY ADJUSTMENTS. COSTS SHALL BE INCIDENTAL TO THE PROJECT.
- 4. DISPOSAL SITE FOR ALL EXCESS EXCAVATION MATERIAL AND UNSUITABLE MATERIAL SHALL BE OBTAINED BY THE CONTRACTOR IN COMPLIANCE WITH APPLICABLE ENVIRONMENTAL REGULATIONS AND APPROVED BY THE OWNER.
- 5. PROTECT THE EXISTING UTILITY LINES WITHIN THE CONSTRUCTION AREA. ANY DAMAGE TO EXISTING FACILITIES CAUSED BY CONSTRUCTION ACTIVITY SHALL IMMEDIATELY BE REPAIRED OR REPLACED BY CONTRACTOR AT CONTRACTOR'S EXPENSE
- CONSTRUCTION ACTIVITY SHALL BE LIMITED TO THE RIGHT-OF-WAY, PROPERTY LIMITS AND/OR CONSTRUCTION WORK ZONE AS SHOWN ON DRAWINGS. ANY DAMAGE TO ADJACENT PROPERTIES RESULTING FROM THE CONSTRUCTION PROCESS SHALL BE REPAIRED OR REPLACED BY CONTRACTOR AT CONTRACTOR'S EXPENSE.
- 7. EXCEPT AS SET FORTH IN THE SPECIFICATIONS, OBTAIN ALL THE NECESSARY PERMITS FOR THE PROJECT PRIOR TO COMMENCING CONSTRUCTION (I.E. BARRICADING, SURFACE DISTURBANCE)
- 8. CONTRACTOR SHALL REPLACE ANY AND ALL SURVEY MONUMENTS DESTROYED DURING CONSTRUCTION. ALL MONUMENTS MUST BE RESET BY A NEW MEXICO REGISTERED PROFESSIONAL SURVEYOR.
- 9. USE CAUTION AT ALL EXISTING STRUCTURES INCLUDING THE EXISTING TANK, FENCE, ETC. THE CONTRACTOR WILL BE RESPONSIBLE FOR REPAIR OR REPLACEMENT OF ANY DAMAGE TO ANY STRUCTURES CAUSED BY THE CONTRACTOR'S OPERATIONS.
- 10. TEMPORARY DRAINAGE MEASURES SHALL BE PROVIDED AS NECESSARY TO SAFELY CONVEY STORM WATER RUNOFF TO EXISTING OUTFALLS INCLUDING SILT FENCES AND SEDIMENT CONTROL MEASURES. REPAIR ANY DAMAGE RESULTING FROM STORM WATER FLOWS TO PRIVATE PROPERTY OR IMPROVEMENTS CONSTRUCTED BY THE CONTRACTOR. PREPARATION AND EXECUTION OF THE SWPPP IS THE RESPONSIBILITY OF THE CONTRACTOR.
- 11. BEARINGS ARE GRID AND DISTANCES ARE GROUND.
- 12. CONTRACTOR TO MAINTAIN RED-LINED RECORD DRAWINGS PER THE REQUIREMENTS OF THE CONTRACT DOCUMENTS. HORIZONTAL AND VERTICAL LOCATIONS OF FACILITIES INSTALLED SHALL BE PROVIDED BY A LICENSED SURVEYOR.
- 13. CONTRACTOR SHALL CONTRACT WITH CERTIFIED TESTING LABORATORY TO PERFORM FIELD DENSITY TESTS OR SOIL SAMPLING DURING CONSTRUCTION.
- 14. EXISTING VALVES SHALL ONLY BE OPERATED BY THE OWNER. CONTRACTOR SHALL PROVIDE A MINIMUM 7 DAY NOTICE TO THE OWNER WHEN A SHUT-OFF IS REQUIRED.
- 15. CONTRACTOR SHALL COMPLY WITH REQUIREMENTS OF THE BUREAU OF LAND MANAGEMENT REGARDING TREATMENT OF ARCHAEOLOGICAL SITES. IF DURING THE CONSTRUCTION PHASE, THE CONTRACTOR, ITS SUBCONTRACTORS, CONSULTANTS, AGENTS, OR EMPLOYEES FIND OR OTHERWISE DISCOVER OR BECOME AWARE OF ANY ARTIFACT OR OBJECT OF ANTIQUITY THAT MAY HAVE ANY RELIGIOUS OR CULTURAL SIGNIFICANCE, IMMEDIATELY ALL WORK SHALL BE HALTED AND OWNER NOTIFIED OF SUCH DISCOVERY. WORK SHALL NOT RECOMMENCE UNTIL OWNER HAS CONTACTED APPROPRIATE OFFICIALS, ALL STEPS HAVE BEEN TAKEN TO PROTECT THE ARTIFACT OR OBJECT, AND RECOMMENCEMENT OF SITE DEVELOPMENT HAS BEEN APPROVED BY THE OWNER.
- 16. STANDARD SPECIFICATIONS AND STANDARD DETAILS REFERENCED IN THIS PROJECT ARE PER NEW MEXICO PUBLIC WORKS STANDARD SPECIFICATIONS NMPWSS LATEST EDITION. ALL WORK WITHIN NMDOT ROW SHALL CONFORM TO THE NEW MEXICO STATE DEPARTMENT OF TRANSPORTATION STANDARD SPECIFICATIONS FOR HIGHWAY AND BRIDGE CONSTRUCTION(2019 EDITION)
- 17. ALL PIPE AND FITTINGS IN CONTACT WITH DRINKING WATER SHALL MEET AWWA REGULATIONS FOR DRINKING WATER AND BE NSF-61 COMPLIANT.
- 18. ALL WORK SHALL COMPLY WITH THE PROJECT SPECIFICATIONS OR NEW MEXICO STANDARD SPECIFICATIONS FOR PUBLIC WORKS, WITH PROJECT SPECIFICATIONS TAKING PRECEDENCE.
- 19. FOR PIPELINE TRENCH EXCAVATION, UTILIZE METHODS AND PROCEDURES OUTLINED IN THE OSHA REGULATIONS STANDARD NO. 1926. TRENCH SUPPORT AND TEMPORARY SHORING MAY BE REQUIRED FOR PIPELINE CONSTRUCTION IN CERTAIN AREAS ALONG THE ALIGNMENT TO SATISFY CONSTRAINTS IDENTIFIED IN THE DRAWINGS FOR LIMITS OF DISTURBANCE, PROTECTION OF EXISTING UTILITIES, TRAFFIC CONTROL, ETC. AND SHALL BE DESIGNED BY CONTRACTOR TO ADHERE TO OSHA STANDARDS. 25.
- 20. BURY DEPTH OF WATERLINE SHALL BE PER STATION AND ELEVATION SHOWN IN PROFILE.

STAGING AREA

1. CONTRACTOR MAY USE AREA IN PUMP STATION EASEMENT FOR STAGING OF MATERIALS AND EQUIPMENT STORAGE. REFER TO DWG C-23

ADDITIONAL NOTES

- INSTALL BARRICADE FENCING ON THE CONSTRUCTION SIDE OF **ENVIRONMENTALLY SENSITIVE AREAS.**
- NMDOT VEGETATION MANAGEMENT SHALL APPROVE SEED MIXTURE.
- ALL SEED SHALL BE CERTIFIED NOXIOUS WEED FREE PRIOR TO USE. THERE WILL BE NO PRIMARY OR SECONDARY NOXIOUS WEEDS IN THE SEED MIXTURE. SEED LABELS FROM EACH BAG SHALL BE RETAINED AND TURNED INTO THE OWNER AFTER THE SEEDING IS ACCOMPLISHED.
- CERTIFIED WEED-FREE MULCH SHALL BE APPLIED AT A RATE OF 1.5 TONS PER ACRE AND SHALL BE CRIMPED TO PREVENT DRIFTING. STRAW OR HAY USED FOR MULCHING SHALL BE FROM OATS, WHEAT, RYE, OR OTHER APPROVED GRAIN CROPS, OR APPROVED HERBACEOUS MOWINGS, RESPECTIVELY, AND FREE FROM NOXIOUS OR OTHER OBJECTIONABLE MATERIAL.

TRAFFIC NOTES

- DO NOT OBSTRUCT DRIVEWAYS OR DESIGNATED TRAFFIC LANES WITH OVERNIGHT PARKING OF CONSTRUCTION FOUIPMENT DO NOT STORE ANY EQUIPMENT OR MATERIAL WITHIN THE PUBLIC RIGHT-OF-WAY.
- 2. COORDINATE WITH NMDOT PRIOR TO BEGINNING ANY CONSTRUCTION WORK ON OR ADJACENT TO EXISTING STREETS.
- ENSURE THAT ALL BARRICADES AND CONSTRUCTION SIGNING SHALL CONFORM TO APPLICABLE SECTIONS OF THE "MANUAL ON UNIFORM TRAFFIC CONTROL DEVICES" (MUTCD), U.S. DEPARTMENT OF TRANSPORTATION, LATEST EDITION AND NMDOT STANDARD SPECIFICATIONS, LATEST ADDITION.
- CONTRACTOR SHALL PREPARE AND SUBMIT A TRAFFIC CONTROL PLAN FOR REVIEW AND APPROVAL
- 5. TWO (2) LANES OF TRAFFIC SHALL BE MAINTAINED AT ALL TIMES UNLESS NOTED ON THE PLAN AND PROFILE SHEETS.

NMDOT TRAFFIC CONTROL NOTES

- CONTRACTOR SHALL COORDINATE WITH NMDOT AND ENGINEER PRIOR TO COMMENCING ANY CONSTRUCTION ACTIVITIES ON THE ROADWAY. ENGINEER WILL OBTAIN UTILITY PERMIT ON BEHALF OF SAN JUAN COUNTY. CONTRACTOR WILL BE REQUIRED TO SUBMIT A TRAFFIC CONTROL PLAN PRIOR TO CONSTRUCTION.
- CONTRACTOR SHALL BE REQUIRED TO SUBMIT CERTIFICATE OF INSURANCE AND TRAFFIC CONTROL SUPERVISOR **CERTIFICATION CARD**
- CONTRACTOR SHALL BE REQUIRED TO FILL OUT AND SUBMIT UTILITY PERMIT CONSTRUCTION NOTIFICATION FORM A MINIMUM OF TWO WEEKS PRIOR TO COMMENCING ANY CONSTRUCTION ACTIVITIES. FORM SHALL BE SUBMITTED TO NMDOT DISTRICT 5.

SWPPP NOTES

- CONTRACTOR IS RESPONSIBLE TO PREPARE SWPPP FOR THE ENTIRE PROJECT. A COPY OF SWPPP SHALL BE SUBMITTED FOR REVIEW AND REVIEW APPROVAL TO NMDOT AND SAN JUAN COUNTY AS REQUIRED.
- CULVERT PROTECTIONS SHALL BE INSTALLED UPON INITIATION OF EARTH WORK ACTIVITIES AND MAINTAINED AS MUCH AS PRACTICAL UNTIL STABILIZATION IS COMPLETED AND ACCEPTED. CULVERT PROTECTIONS MAY BE REMOVED FOR PERIODS OF TIME AS REQUIRED DURING CONSTRUCTION TO COMPLETE ADJACENT IMPROVEMENTS.
- COMPOST MULCH SOCKS SHALL BE INSTALLED IN ACCORDANCE WITH MANUFACTURER'S RECOMMENDATIONS.
- 4. ANY EXCAVATED MATERIAL OR STOCKPILED MATERIAL SHALL HAVE DOWNSTREAM SEDIMENT CONTROL MEASURES IN PLATE AT END OF EACH WORK DAY.

CONTACT INFORMATION PHONE: (505) 334-4266 JIM COX SAN JUAN COUNTY EMAIL: JCOX@SJCOUNTY.NET ANDREW SWARTSWALTER PHONE: (505) 823-1000 BOHANNAN HUSTON INC EMAIL: ASWARTSWALTER@BHINC.COM **TANDY FREEL** PROJECT ENGINEER **TODD BURT** 7500 JEFFERSON ST NE ALBUQUERQUE, NM 87109 PHONE: (505) 690-1524 NMDOT DISTRICT 5 MARCOS HERRERA EMAIL: MARCOS.HERRERA@STATE.NM.US 7315 CERRILLOS ROAD SANTA FE. NM 87502 PHONE: (505) 334-9375 NORTH STAR LLOYD AYLIFFE EMAIL: LLOYD@NORTHSTARWATER.ORG MDWCA PO BOX 1120 AZTEC, NM 87410 PHONE: (505)564-7744 BUREAU OF LAND MANAGEMENT **MONICA TILDEN** FARMINGTON FIELD OFFICE 6251 COLLEGE BLVD, FARMINGTON, NM 87402 PHONE: (505)215-1447 EAST CULPEPPER FLATS JIM LESHER DOMESTIC WATER CONSUMERS ASSOCIATION PO BOX 583 108 LLANO ROAD **AZTEC, NM 87410** PHONE: (505)486-2637 WILLIAMS FIELD SERVICES LLOYD BELL 1755 ARROYO DR. BLOOMFIELD, NM 87413

EXISTING

_ _ _ _ _ _ _ _ _

– OHE ———

 \bowtie

B

NEW

LEGEND

FENCE

EASEMENT

PROPERTY LINE

UNDERGROUND ELECTRIC LINE

SANITARY SEWER LINE

STORM DRAIN LINE

TELEPHONE

WATER LINE

POWER POLE

GATE VALVE

HYDRANT

REDUCER

MANHOLE

VALVE PIT

WELL HEAD

CAP

CAV

POTHOLE

INDEX CONTOUR

FLOW PATH/SWALE


BUTTERFLY VALVE

POTHOLE LOCATION


MOTORIZED BUTTERFLY VALVE

AN UNDISPUTED REQUEST FOR PAYMENT.

OVERHEAD ELECTRIC

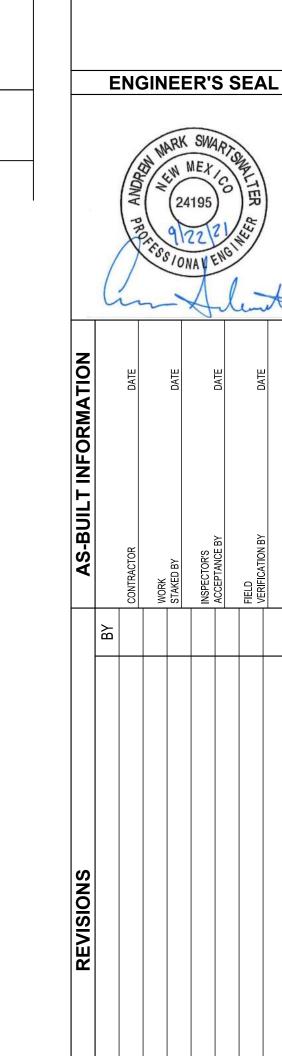


REFERENCE LABELS

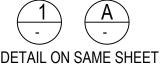






DETAIL MARKERS

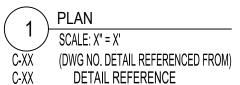

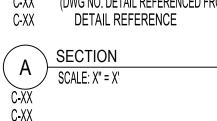

SAME SHEET REFERENCE

REFERENCE LABELS

APPROX	APPROXIMATE	MIN	MINIMUM
ASTM	AMERICAN SOCIETY FOR TESTING AND MATERIALS	MNFR	MANUFACTURER
BP	BOTTOM OF PIPE	N	NORTHING OR NORTH
CCP	CONCRETE CYLINDER PIPE	NAD	NORTH AMERICAN DATUM
CLR	CLEAR	NAVD	NORTH AMERICAN VERTICAL DATUM
CONC	CONCRETE	NM	NEW MEXICO
CY	CUBIC YARD	NMSSPW	
DI	DUCTILE IRON		SPECIFICATIONS FOR PUBLIC WORKS
DIA	DIAMETER		CONSTRUCTION
DIP	DUCTILE IRON PIPE	NO.	NUMBER
DWG	DRAWING	OC	ON CENTER
E	EAST	PCF	POUNDS PER CUBIC FOOT
EA	EACH	PE	POLYETHYLENE
EL	ELEVATION	PSF	POUNDS PER SQUARE FOOT
ELEV	ELEVATION	PSI	POUNDS PER SQUARE INCH
EW	EACH WAY	PVC	POLYVINYL CHLORIDE
EWOC	EACH WAY ON CENTER	R	RADIUS
EX	EXISTING	RCP	REINFORCED CONCRETE PIPE
FF	FINISH FLOOR	S	SLOPE OR SOUTH
FG	FINISH GROUND	SAN	SANITARY SEWER
FL	FLANGE	SQ YD	SQUARE YARD
GA	GAUGE	STA	STATION
INV	INVERT	STD	STANDARD
LF	LINEAR FEET	SS	STAINLESS STEEL
LONGT	LONGITUDINALLY	SW	SOUTHWEST
MAX	MAXIMUM	TP	TOP OF PIPE
MB	MOLYBOLT	TYP	TYPICAL
MH	MANHOLE	W	WEST
		WL	WATER LINE

COUNTY **NEW MEXICO Bohannan** A Huston

SANIJUAN

800.877.5332

SAN JUAN COUNTY EAST CULPEPPER WATER CONNECTION PHASE 1: TRANSMISSION LINE AND BOOSTER STATION

GENERAL NOTES AND LEGEND NOTICE OF EXTENDED PAYMENT PROVISION: THIS CONTRACT ALLOWS THE OWNERS TO MAKE BHI PROJECT NO. DWG NO. PAYMENT WITHIN 45 DAYS AFTER SUBMISSION OF G-02 20190029

www.bhinc.com

GEOTECHNICAL NOTES:

GEOTECHNICAL ENGINEERING REPORT REFERENCE:

GEOMAT 915 MALTA AVE FARMINGTON, NEW MEXICO 87401

DATED: NOVEMBER 12,2020

GEOMAT PROJEC: 202-3606

ENGINEERED FILL MATERIALS FOR TANKS AND FOUNDATIONS:

- 1. ON-SITE OR IMPORTED SOILS WITH LOW EXPANSIVE POTENTIALS SHALL BE USED AS FILL MATERIAL FOR THE FOLLOWING:
 - a. GENERAL SITE GRADING
 - b. FOUNDATION AREAS UNDER STRUCTURES
 - c. FOUNDATION BACKFILL UNDER TANKS
- 2. IMPORTED SOIL TO BE USED IN STRUCTURAL FILL PROVIDED IT MEETS THE FOLLOWING GRADATION:

SIZE	PERCENT PASSING			
3 <u>INCH</u>	100			
NO. 4	50-100			
NO. 200	50 MAX			

MAXIMUM EXPANSIVE POTENTIAL (%) * = 1.5

- * MEASURED ON A SAMPLE COMPACTED TO APPROXIMATELY 95 PERCENT OF THE ASTM D698
 MAXIMUM DRY DENSITY AT ABOUT 3 PERCENT BELOW OPTIMUM WATER CONTENT. THE SAMPLE
 IS CONFINED UNDER A 144-PSF SURCHARGE AND SUBMERGED
- 3. FILL OR BACKFILL, CONSISTING OF SOIL APPROVED BY THE GEOTECHNICAL ENGINEER, SHALL BE PLACED AND NOT EXCEED 10 INCH LOOSE LIFTS AND COMPACTED WITH APPROVED COMPACTION EQUIPMENT.
- 4. MATERIAL SHOULD BE COMPACTED TO THE FOLLOWING:

MATERIAL	MINIMUM PERCENT (ASTM D698)
SUBGRADE SOILS BENEATH FILL AREAS	95
ENGINEERED FILL SOILS	95
MISCELLANEOUS BACKFILL	90

5. ON-SITE AND IMPORTED SOILS SHALL BE MOISTENED TO OPTIMUM MOISTURE CONTENT (+/-2%)

PIPELINE EXCAVATION AND BACKFILL:

- 1. CONSTRUCTION OF STABLE TEMPORARY EXCAVATIONS IS THE RESPONSIBILITY OF THE CONTRACTOR. TEMPORARY SLOPES AND EXCAVATIONS SHOULD BE DESIGNED AND CONSTRUCTED IN ACCORDANCE WITH APPLICABLE OSHA GUIDELINES, AS APPROPRIATE.
- 2. ALL DETAILS REGARDING EXCAVATION SAFETY, AS DESCRIBED IN OSHA REGULATIONS, SHALL BE FOLLOWED. ALL EXCAVATIONS IN SOILS GREATER THAN FOUR FEET (4') IN DEPTH SHALL BE SLOPED, SHORED OR BRACED.
- 3. SPOILS SHALL BE PLACED AT LEAST TWO (2) FEET AWAY FROM THE EDGE OF EXCAVATION.
- 4. THE CONTRACTOR SHALL BE RESPONSIBLE FOR MONITORING AND ASSESSING CONDITIONS AFFECTING SOIL STABILITY DURING CONSTRUCTION.
- 5. EXCAVATIONS SHALL BE BACKFILLED TO THE PLANNED FINISHED GRADES USING NATIVE OR IMPORTED SOILS THAT ARE FREE OF DEBRIS, RUBBLE, FROZEN SOIL, ORGANIC MATERIAL, OR OTHER DELETERIOUS MATERIAL.
- 6. FILL MATERIAL SHALL BE FREE OF COBBLES OR BOULDERS GREATER THAN SIX INCHES IN DIAMETER.
- 7. EXCAVATED BEDROCK MAY NOT BE SUITABLE FOR USE AS BACKFILL MATERIAL.
- 8. BACKFILL MATERIAL SHOULD BE COMPACTED TO A MINIMUM OF 90 PERCENT OF MAXIMUM DRY DENSITY AS DETERMINED BY ASTM D698. IN AREAS WHERE THE FINAL BACKFILL IS LOCATED UNDER PAVEMENTS OR OTHER STRUCTURES, THE UPPER TWO (2.0) FEET OF BACKFILL SHOULD BE COMPACTED TO A MINIMUM OF 95 PERCENT OF THE D698 MAXIMUM DRY DENSITY.
- 9. SOILS SHOULD BE COMPACTED AT A MOISTURE CONTENT BETWEEN THREE (3.0) PERCENT BELOW AND ONE (1.0) PERCENT ABOVE OPTIMUM.

BACKFILL MATERIAL SHALL BE PLACED IN HORIZONTAL LIFTS USING EQUIPMENT AND PROCEDURES THAT WILL PRODUCE RECOMMENDED MOISTURE CONTENTS AND DENSITIES THROUGHOUT THE LIFT. IN THE CASE OF CONFLICTING MOISTURE AND/OR DENSITY SPECIFICATIONS, THE CRITERIA SPECIFIED BY THE PREVAILING JURISDICTION SHALL GOVERN.

10. CONTRACTOR SHALL FOLLOW NMDOT MINIMUM TESTING REQUIREMENTS FOR WORK WITHIN NMDOT ROW.

ENGINEER'S SEAL



		The same of							
ORMATION		DATE		DATE	!	DATE	DATE		DATE
AS-BUILT INFORMATION		CONTRACTOR	WORK	STAKED BY	INSPECTOR'S	ACCEPTANCE BY	FIELD VERIFICATION BY		DRAWINGS CORRECTED BY
	ВУ								

SAN JUAN

COUNTY

NEW MEXICO


SINCE 1887


Bohannan A Huston
www.bhinc.com 800.877.5332


SAN JUAN COUNTY
EAST CULPEPPER WATER CONNECTION
PHASE 1: TRANSMISSION LINE AND BOOSTER STATION


NOTICE OF EXTENDED PAYMENT PROVISION:
THIS CONTRACT ALLOWS THE OWNERS TO MAKE
PAYMENT WITHIN 45 DAYS AFTER SUBMISSION OF
AN UNDISPUTED REQUEST FOR PAYMENT.


BHI PROJECT NO.

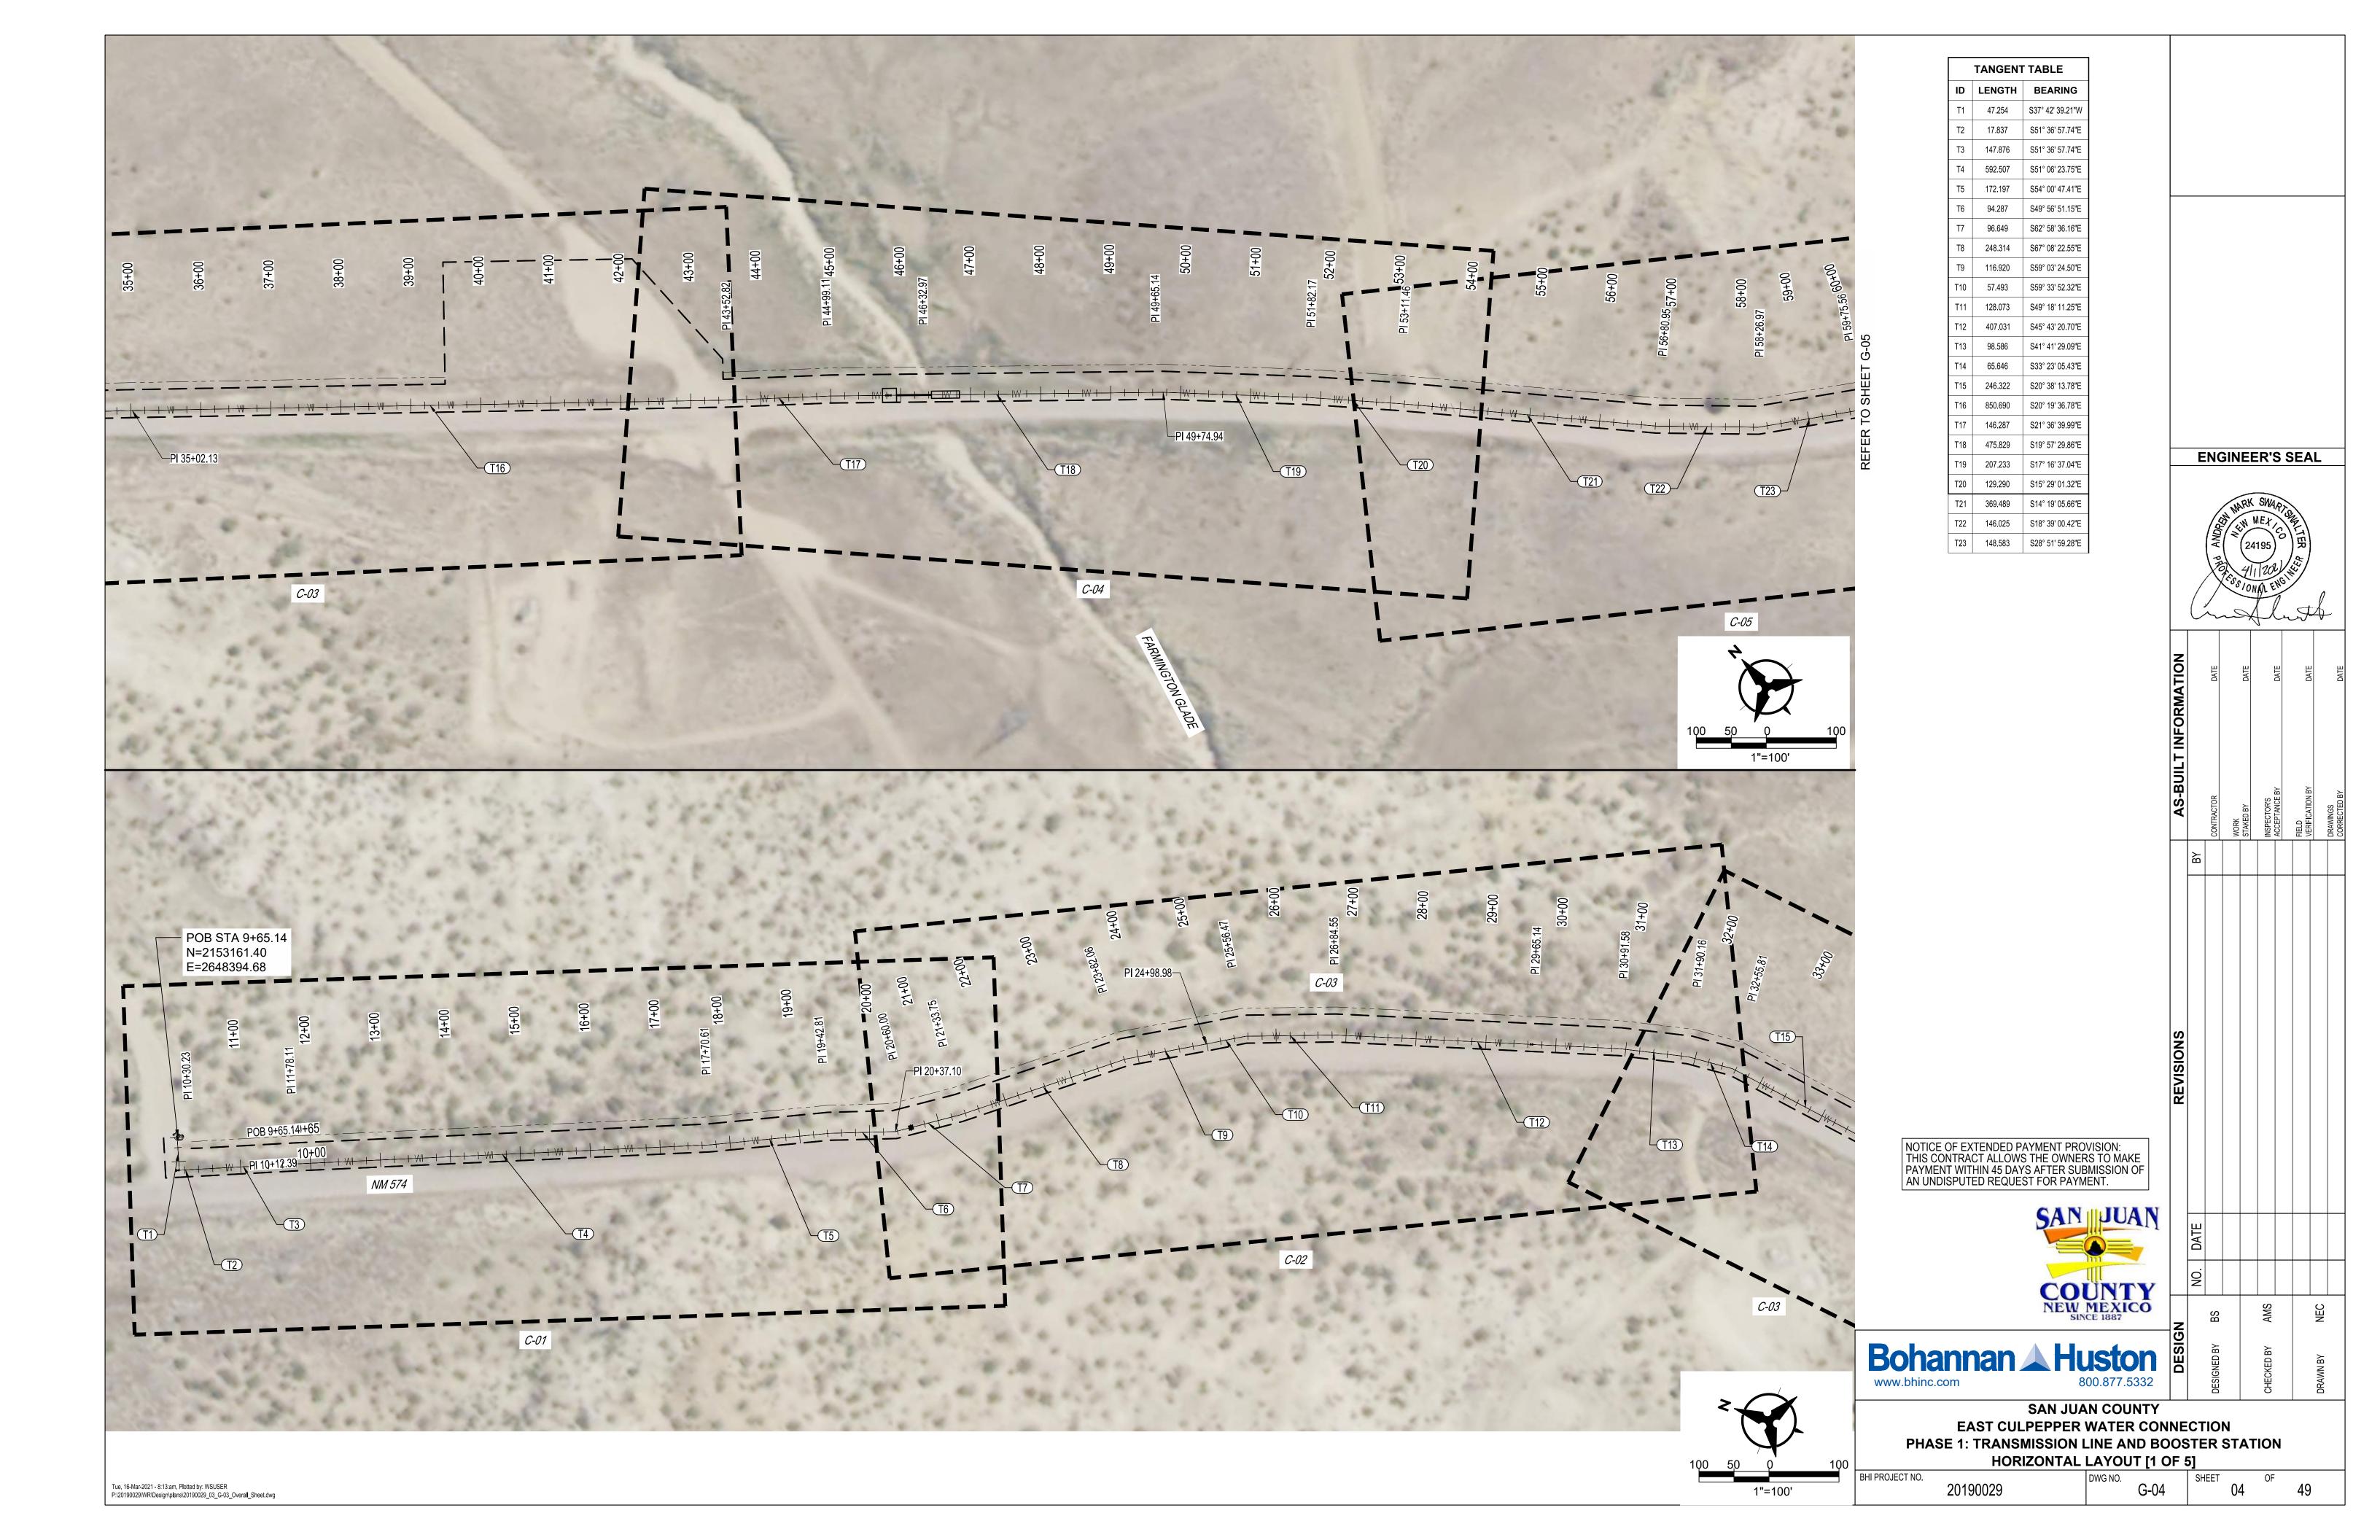


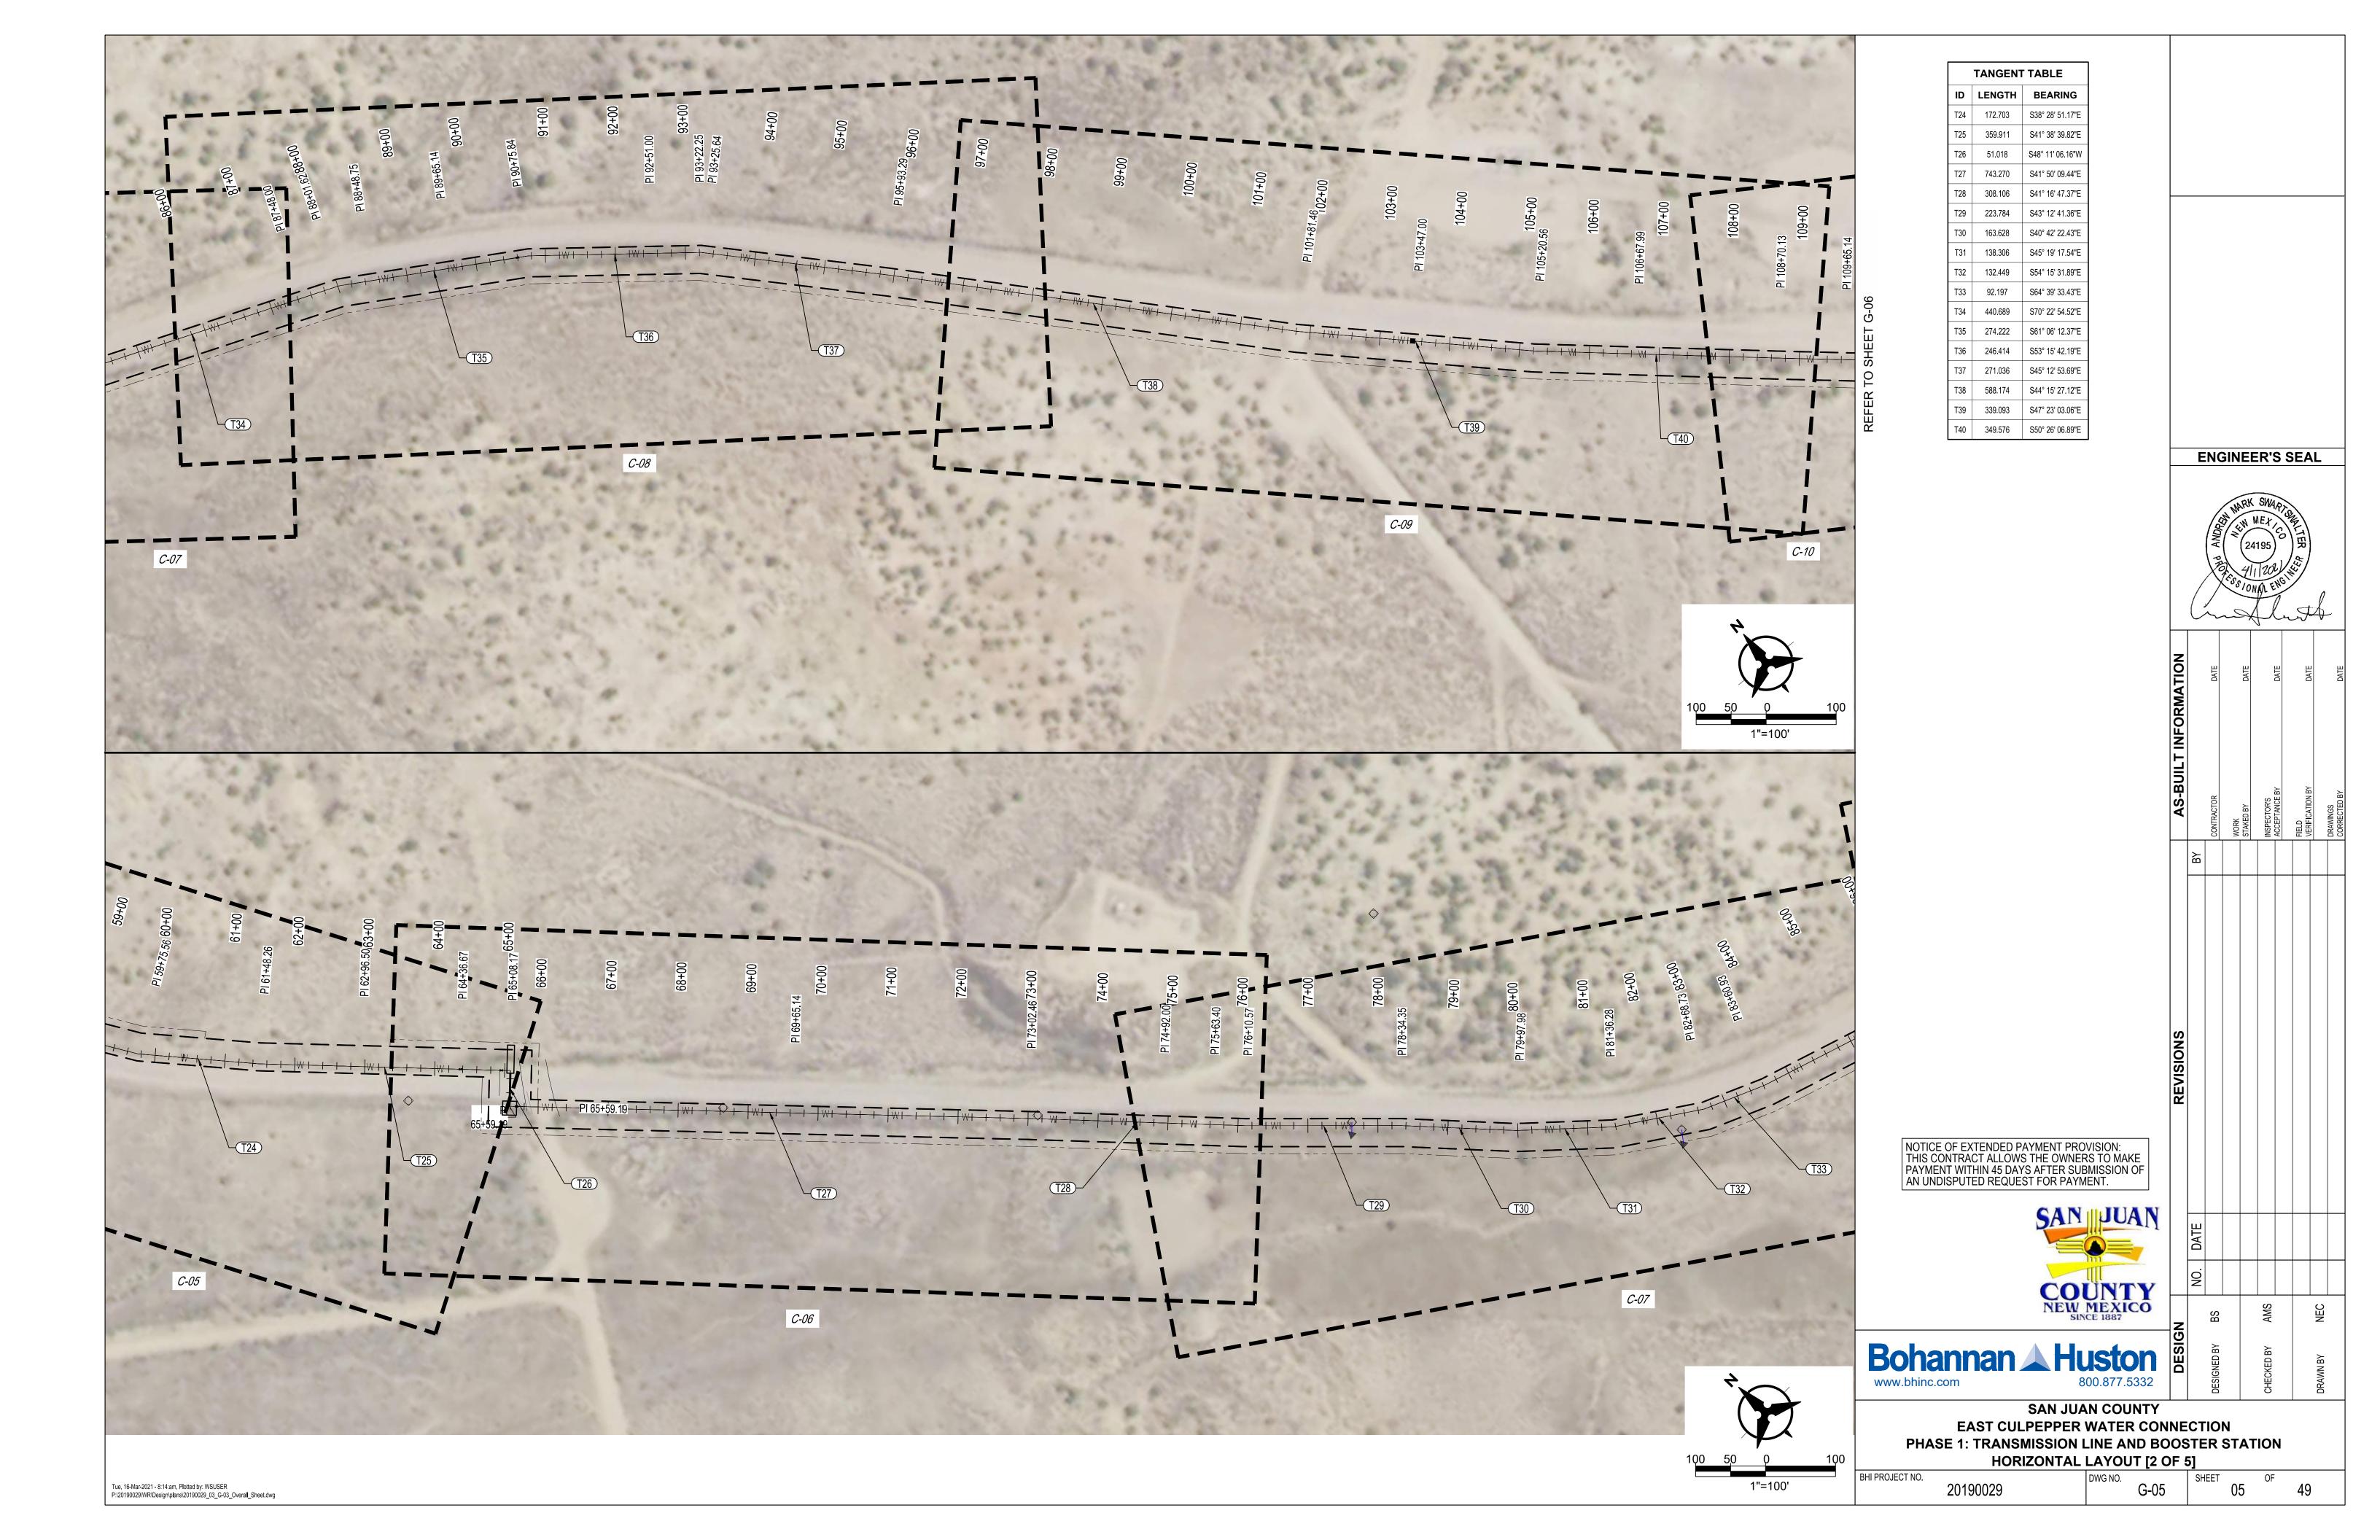


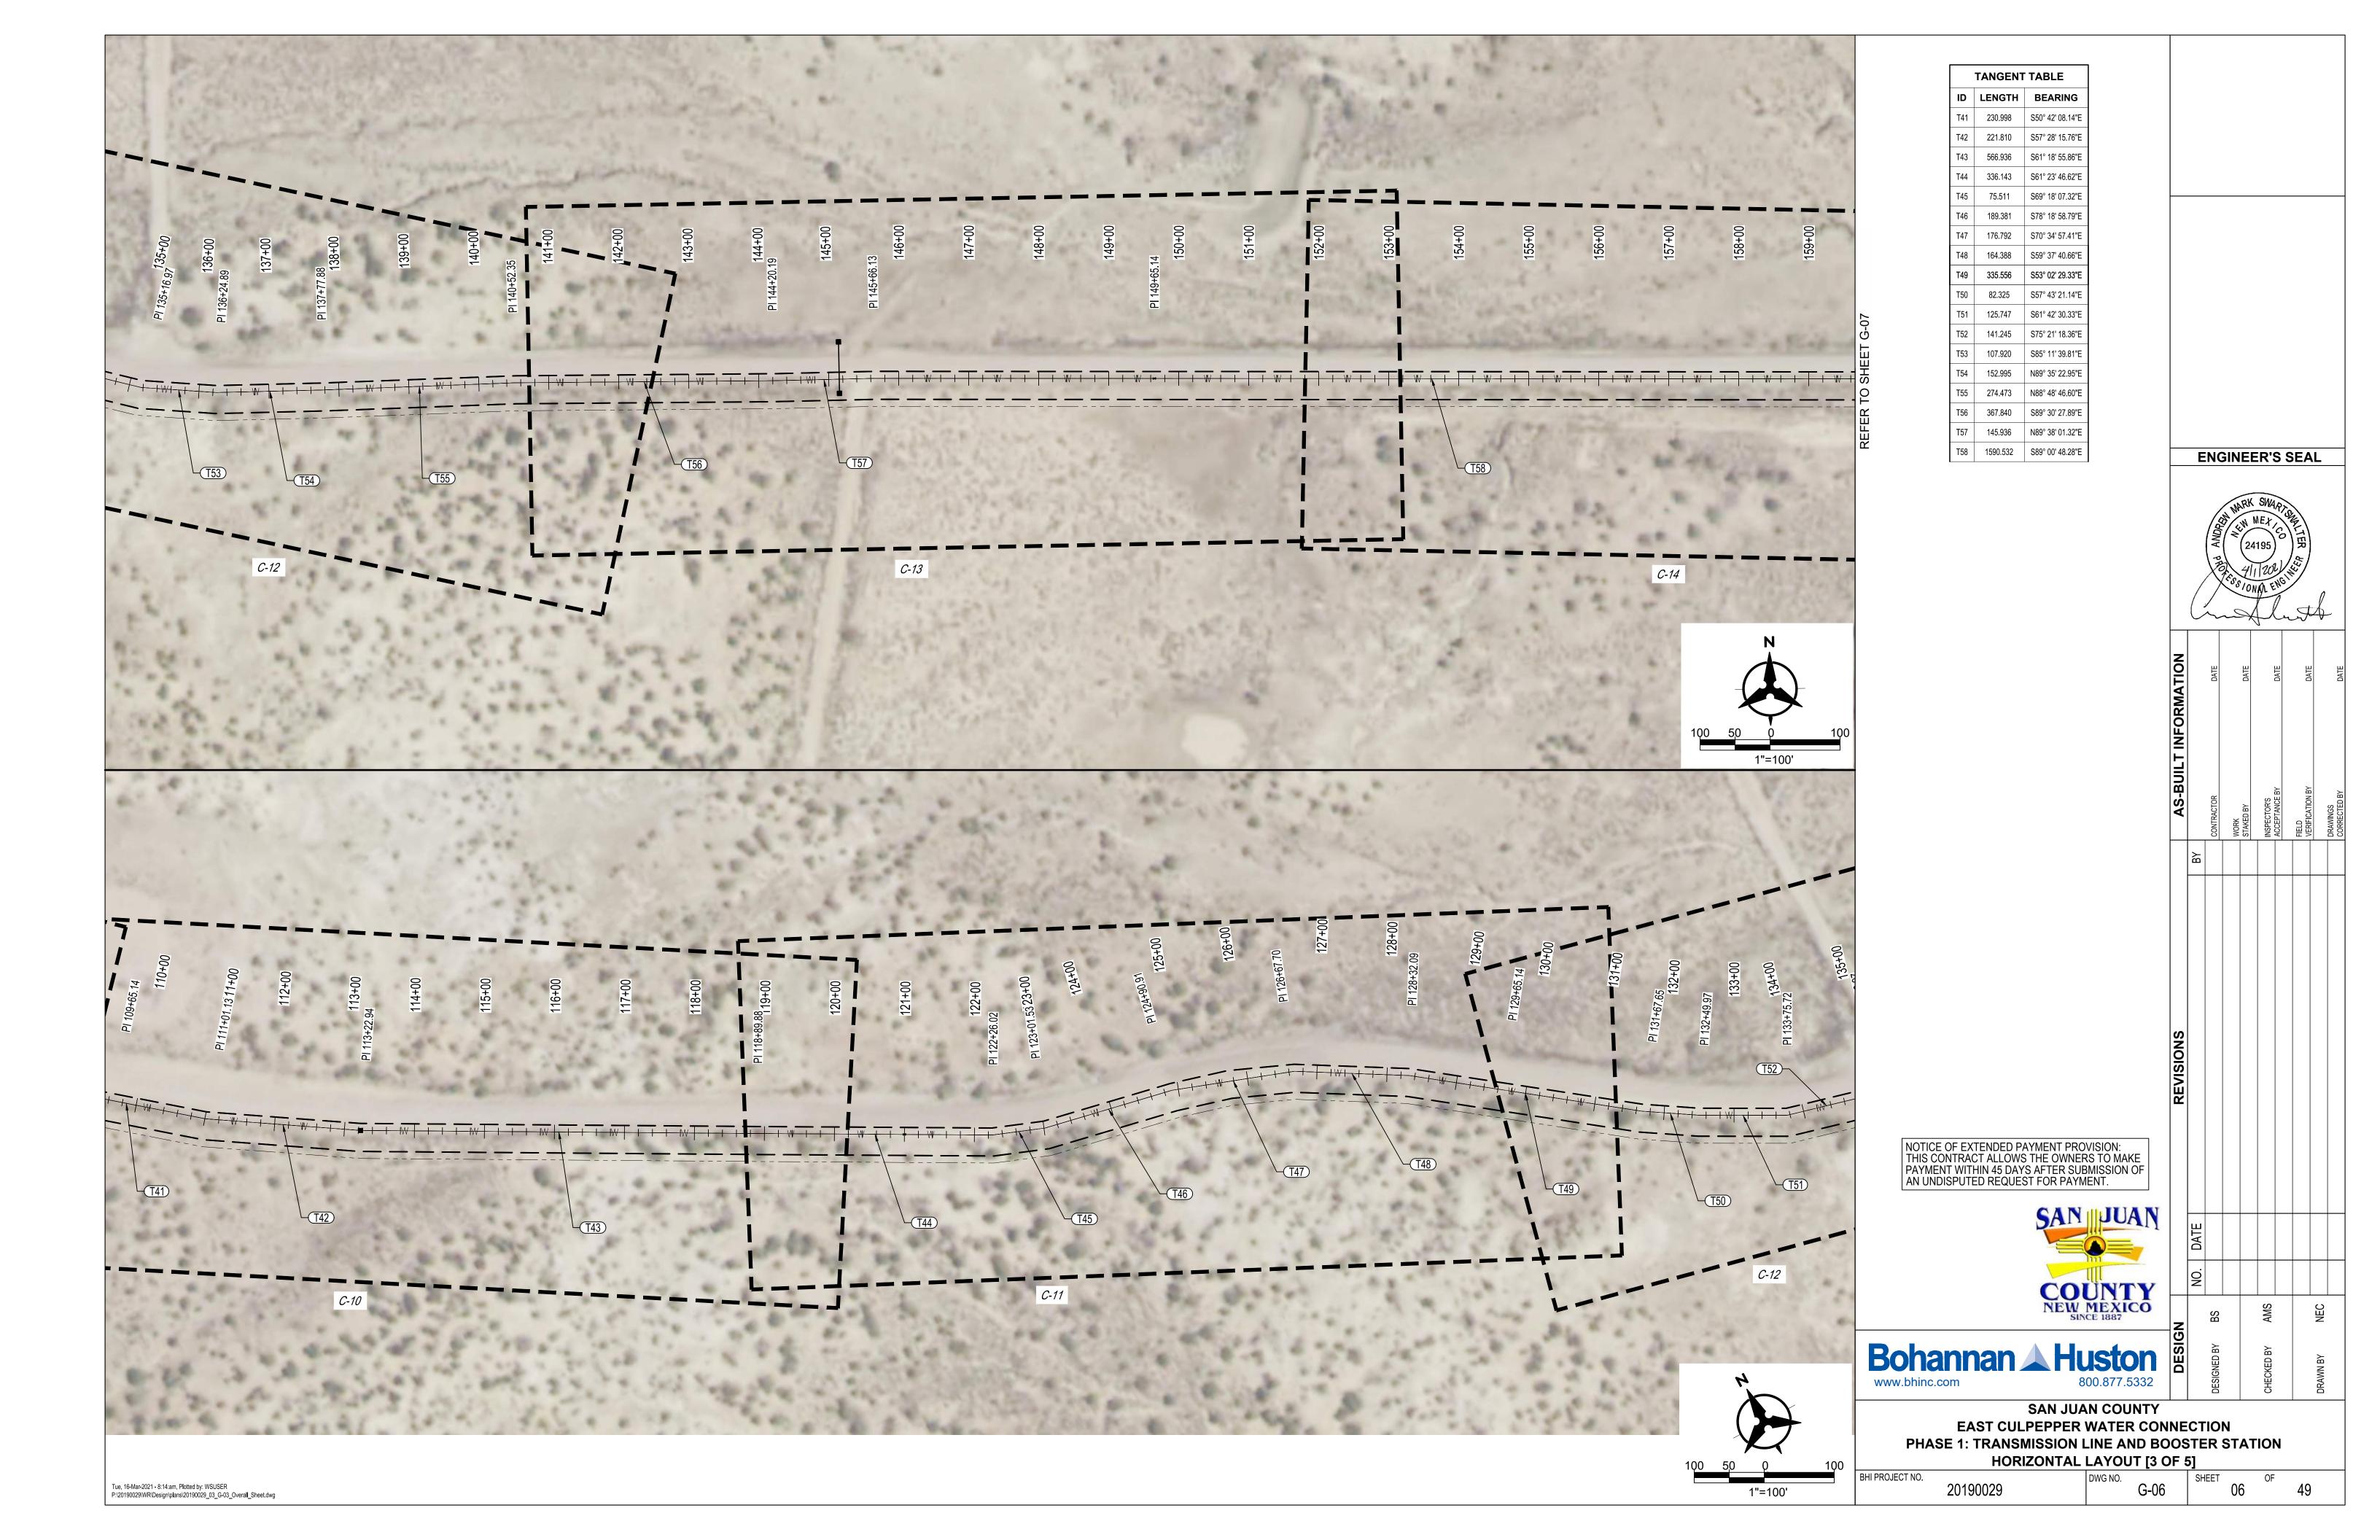


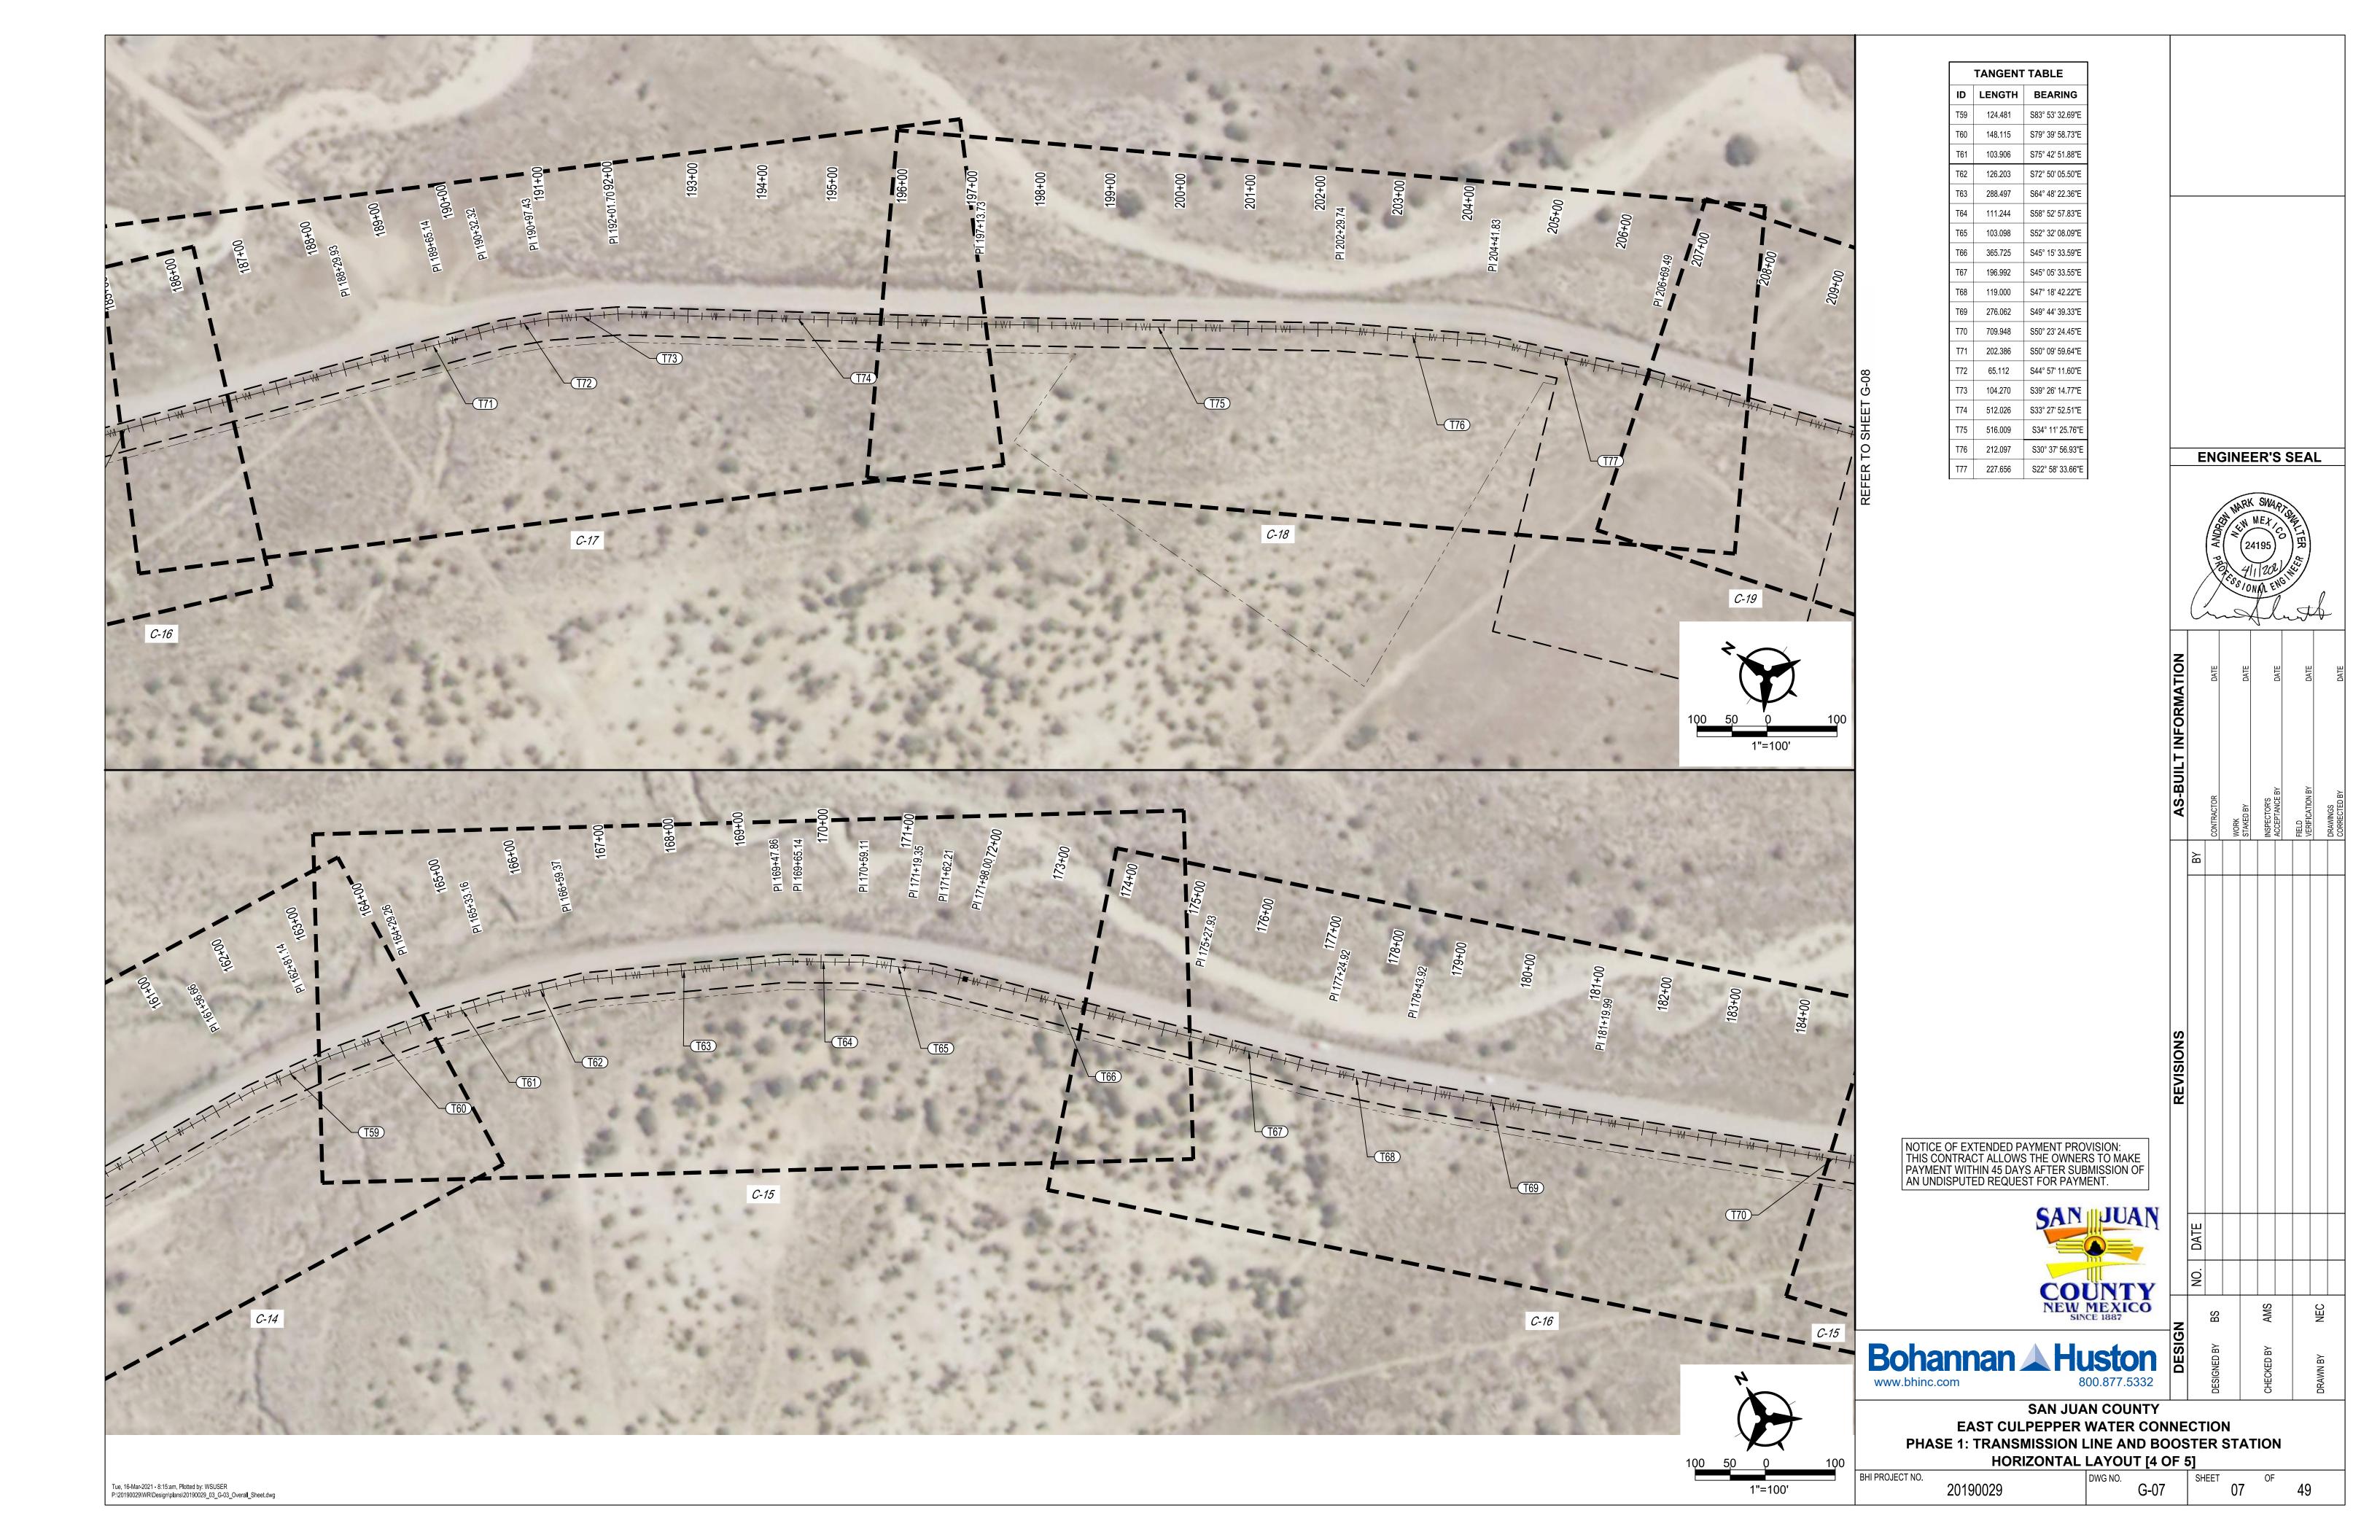


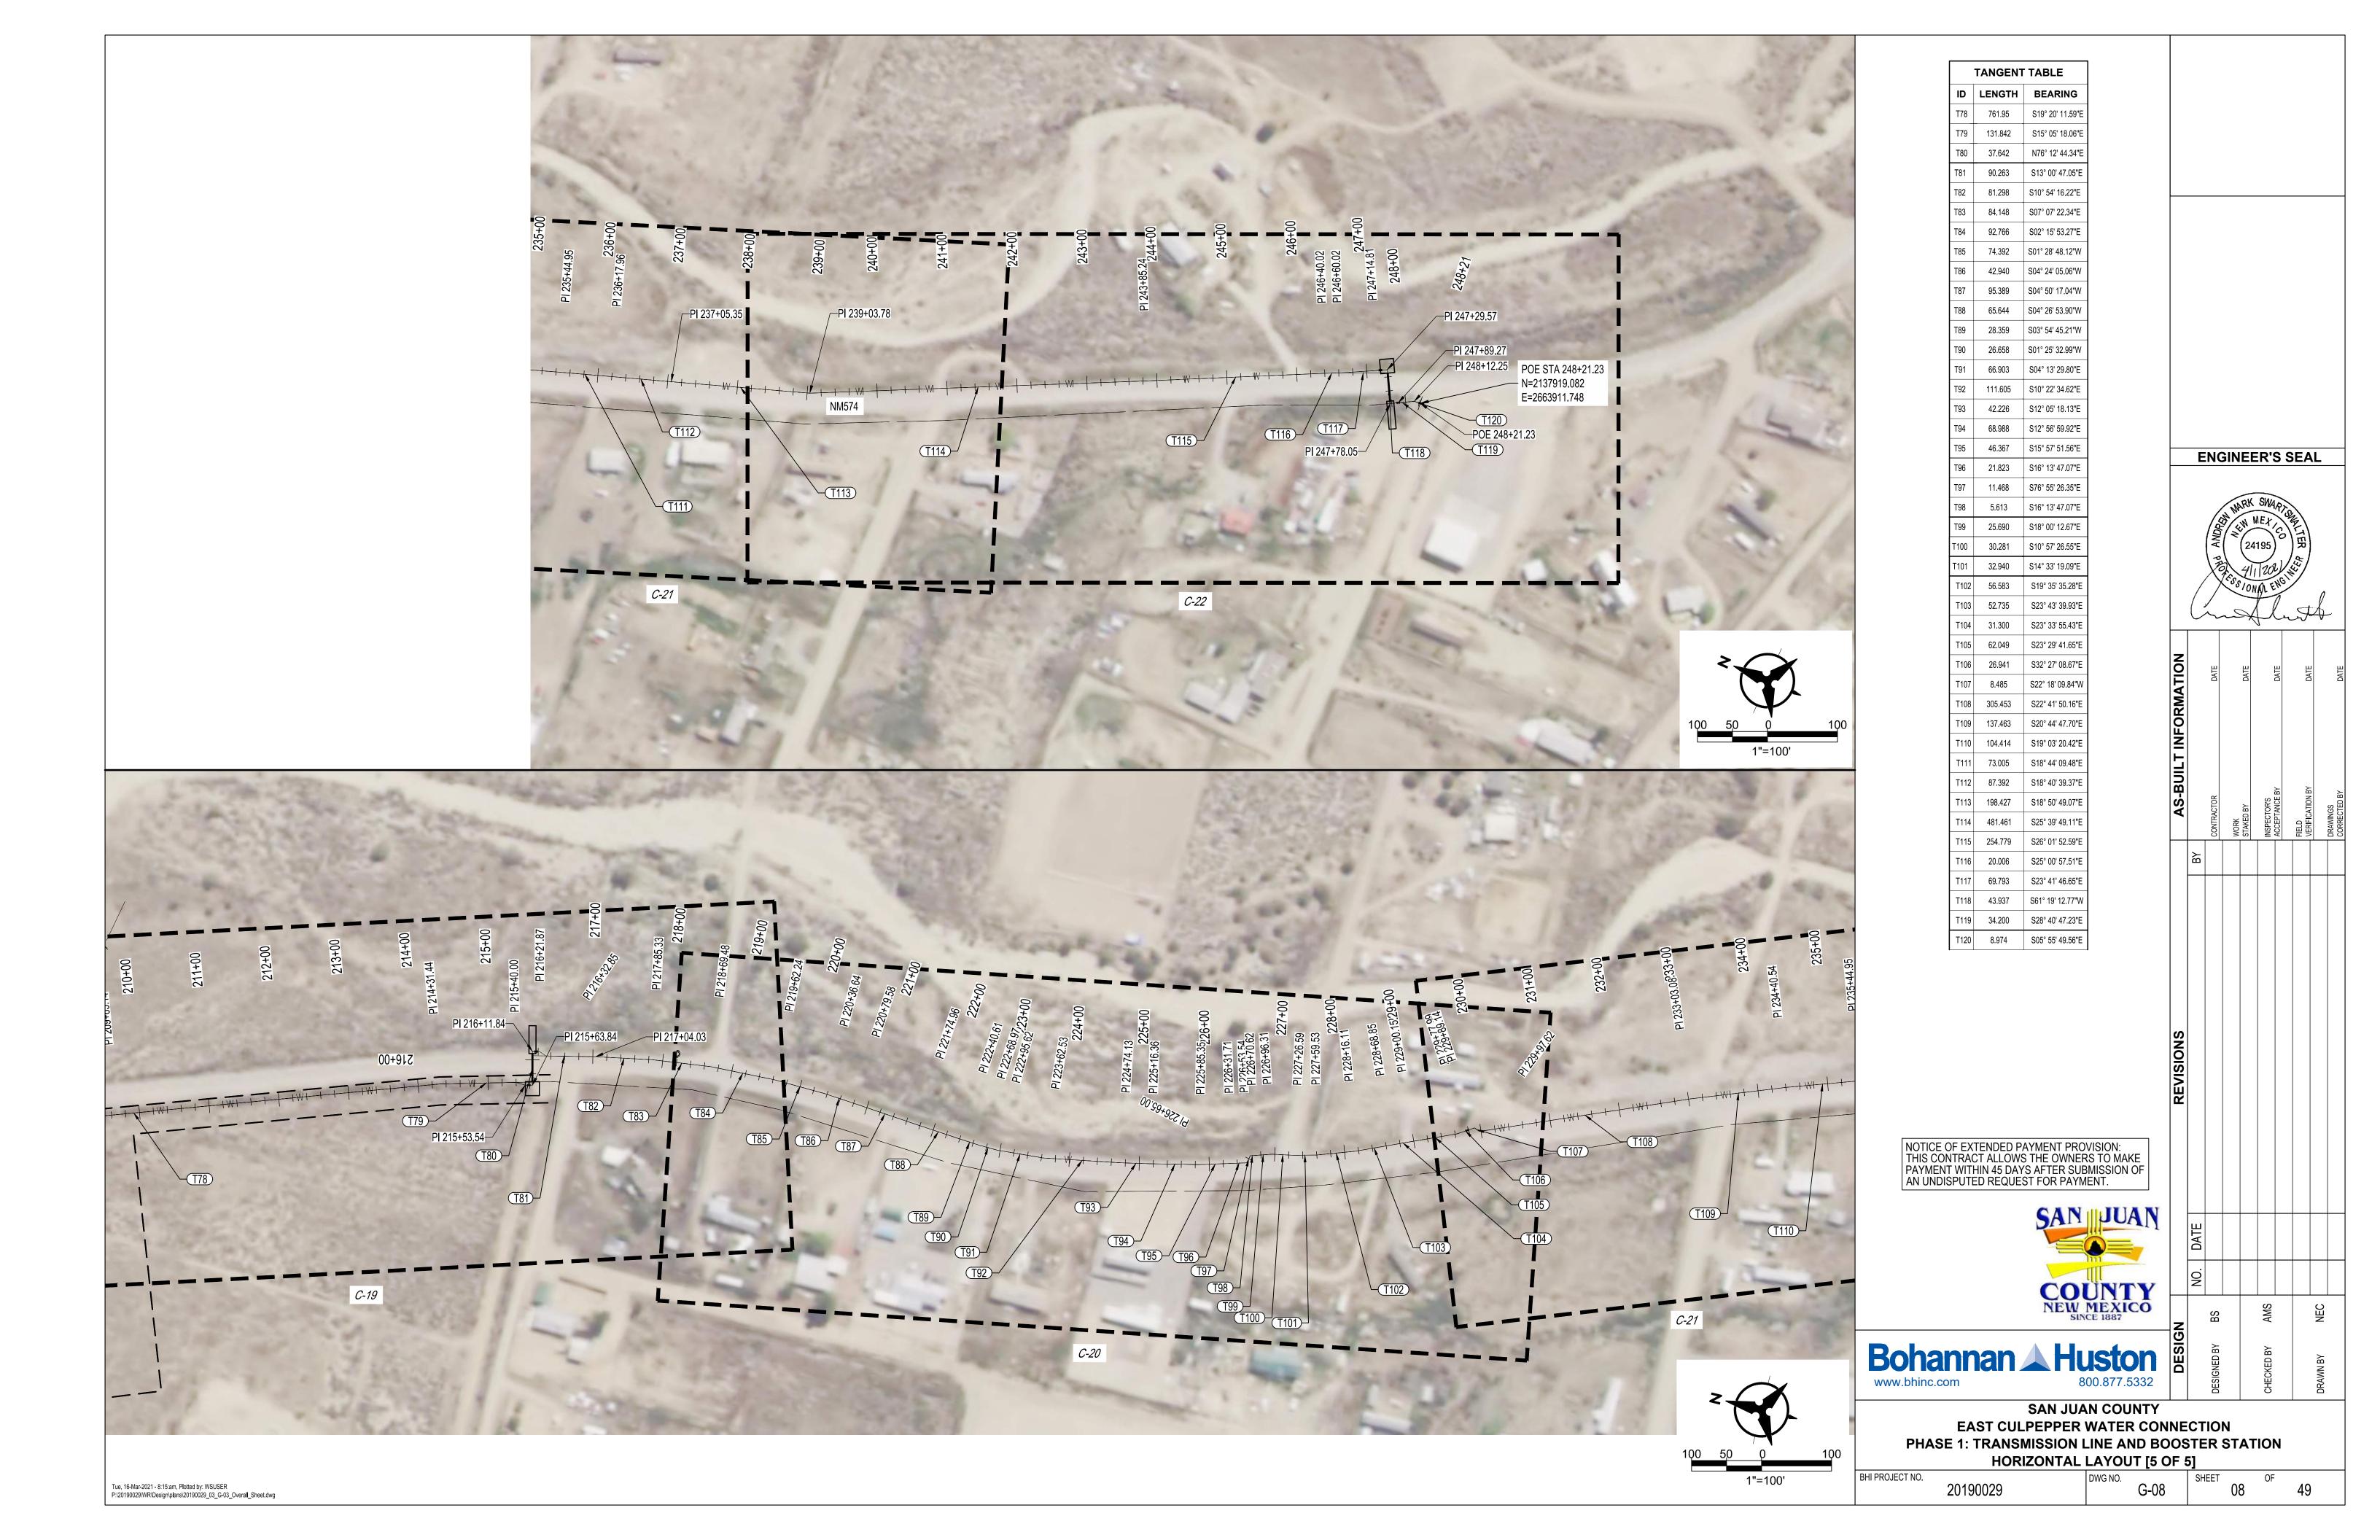


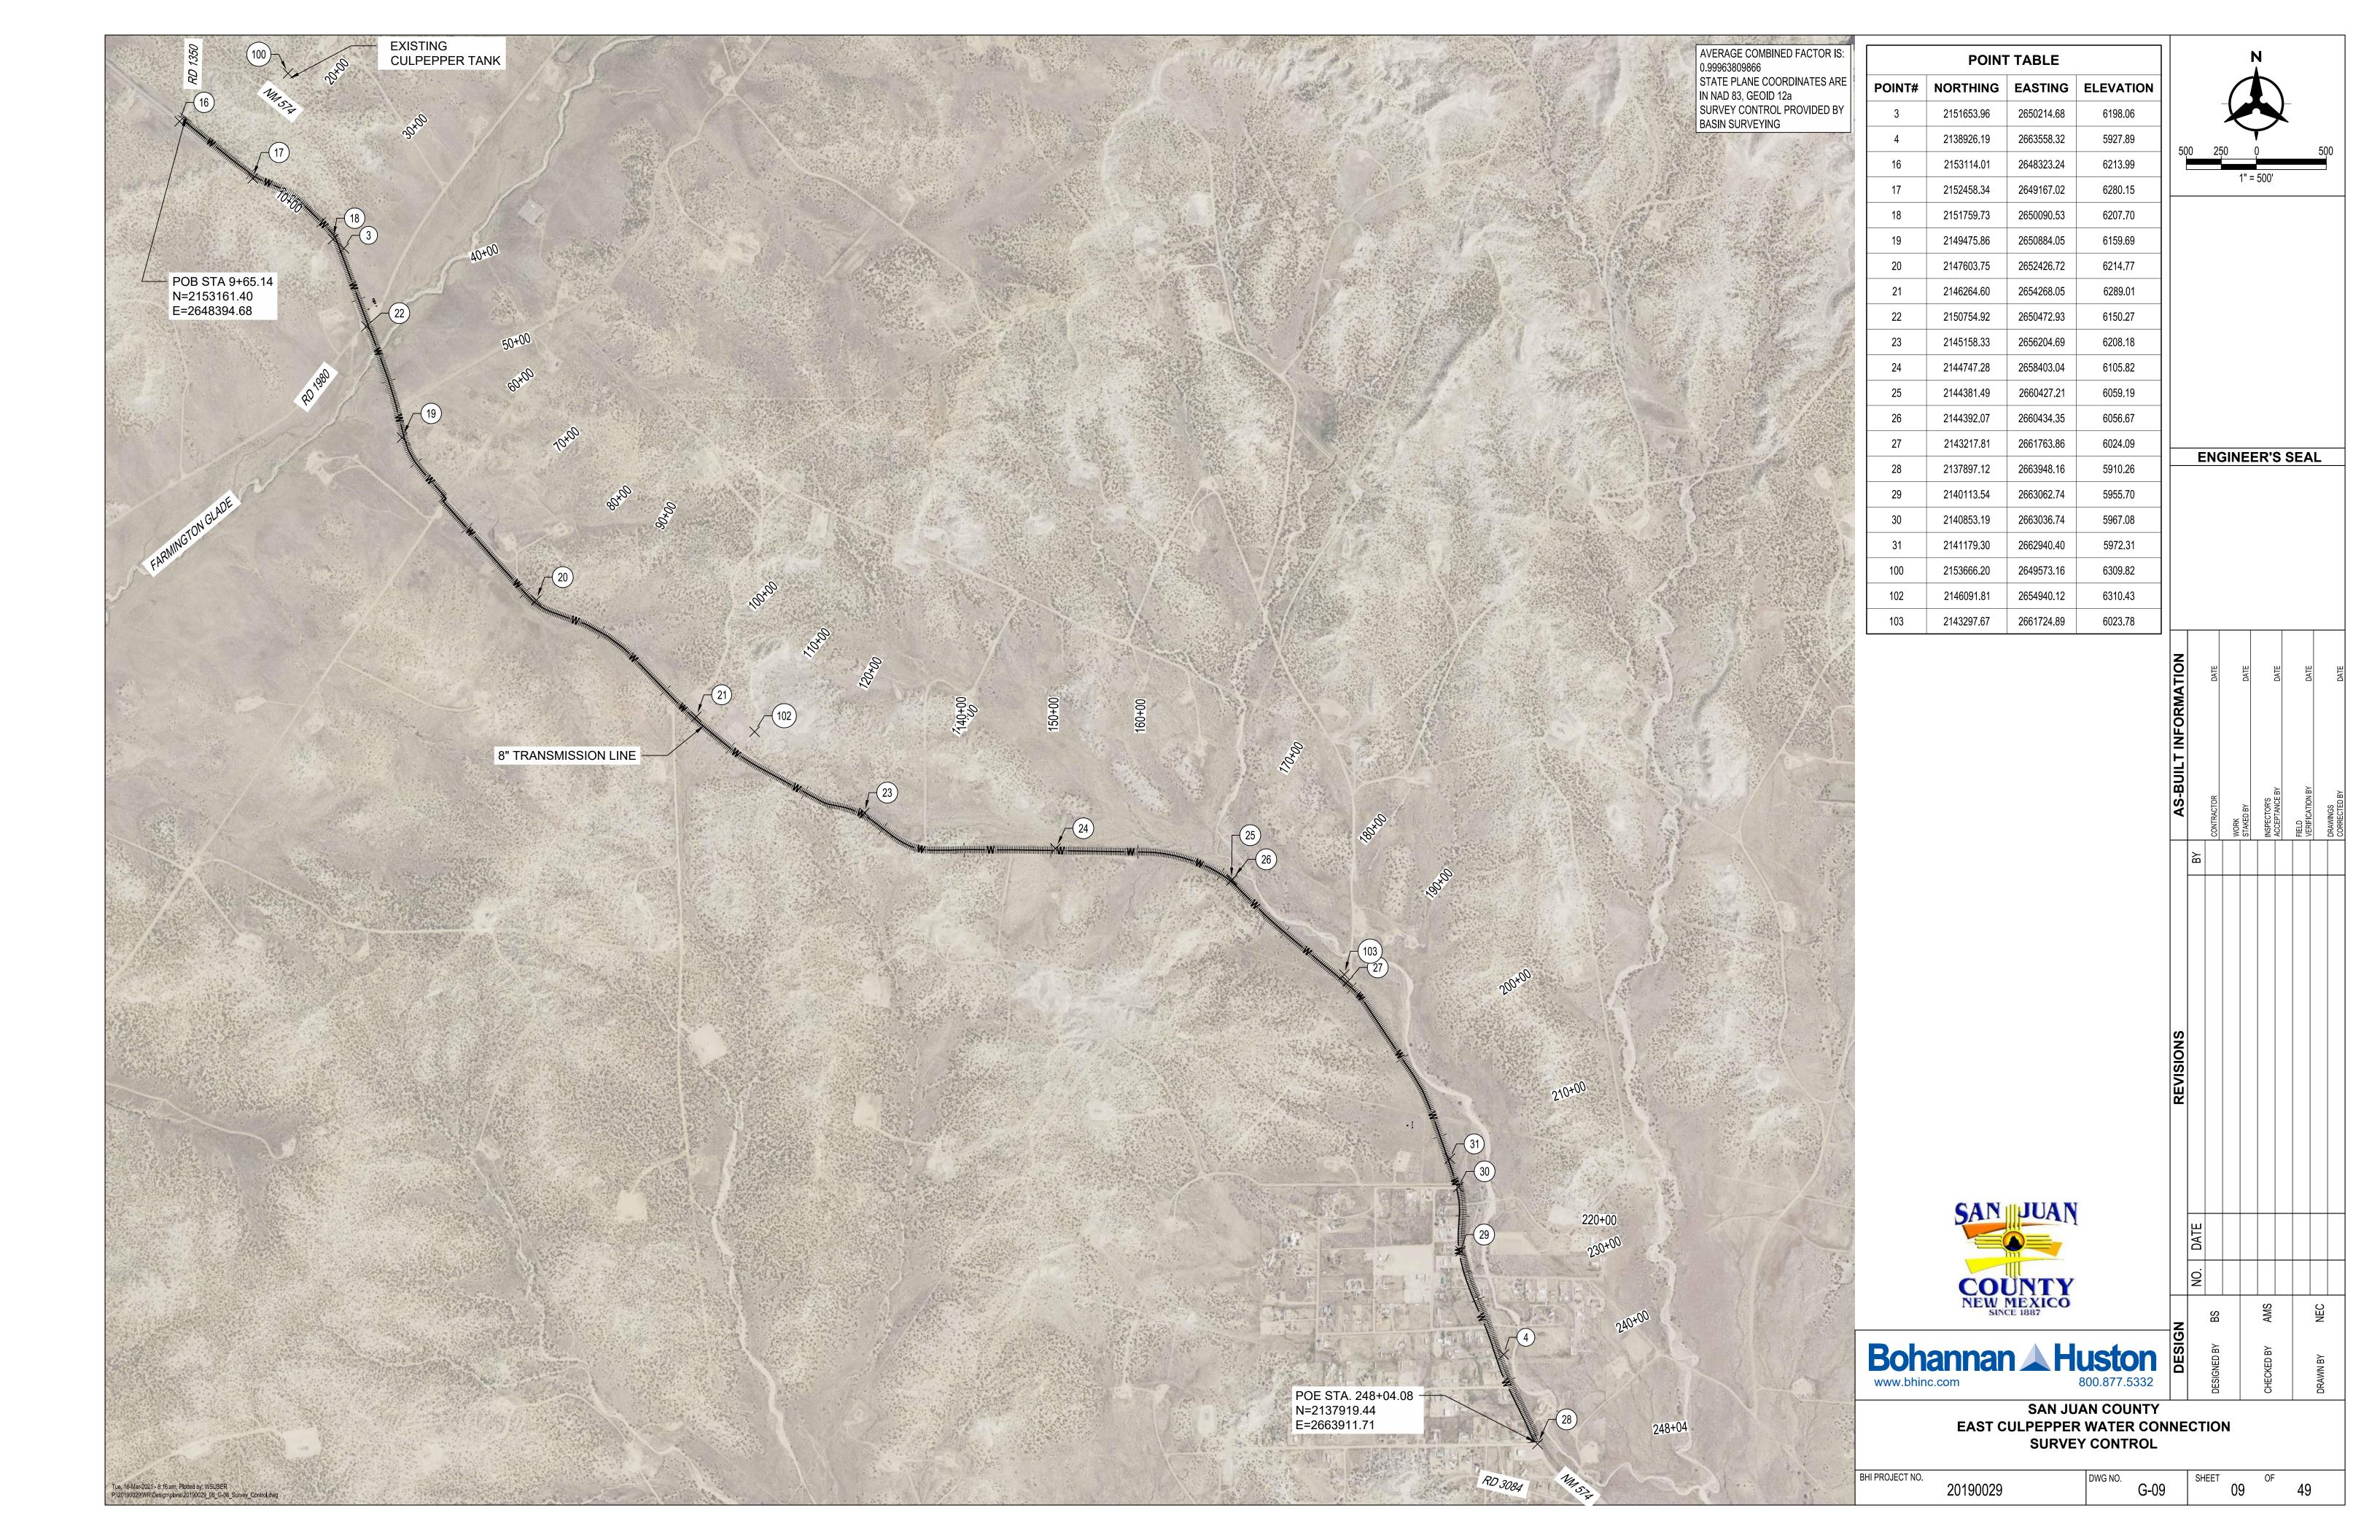


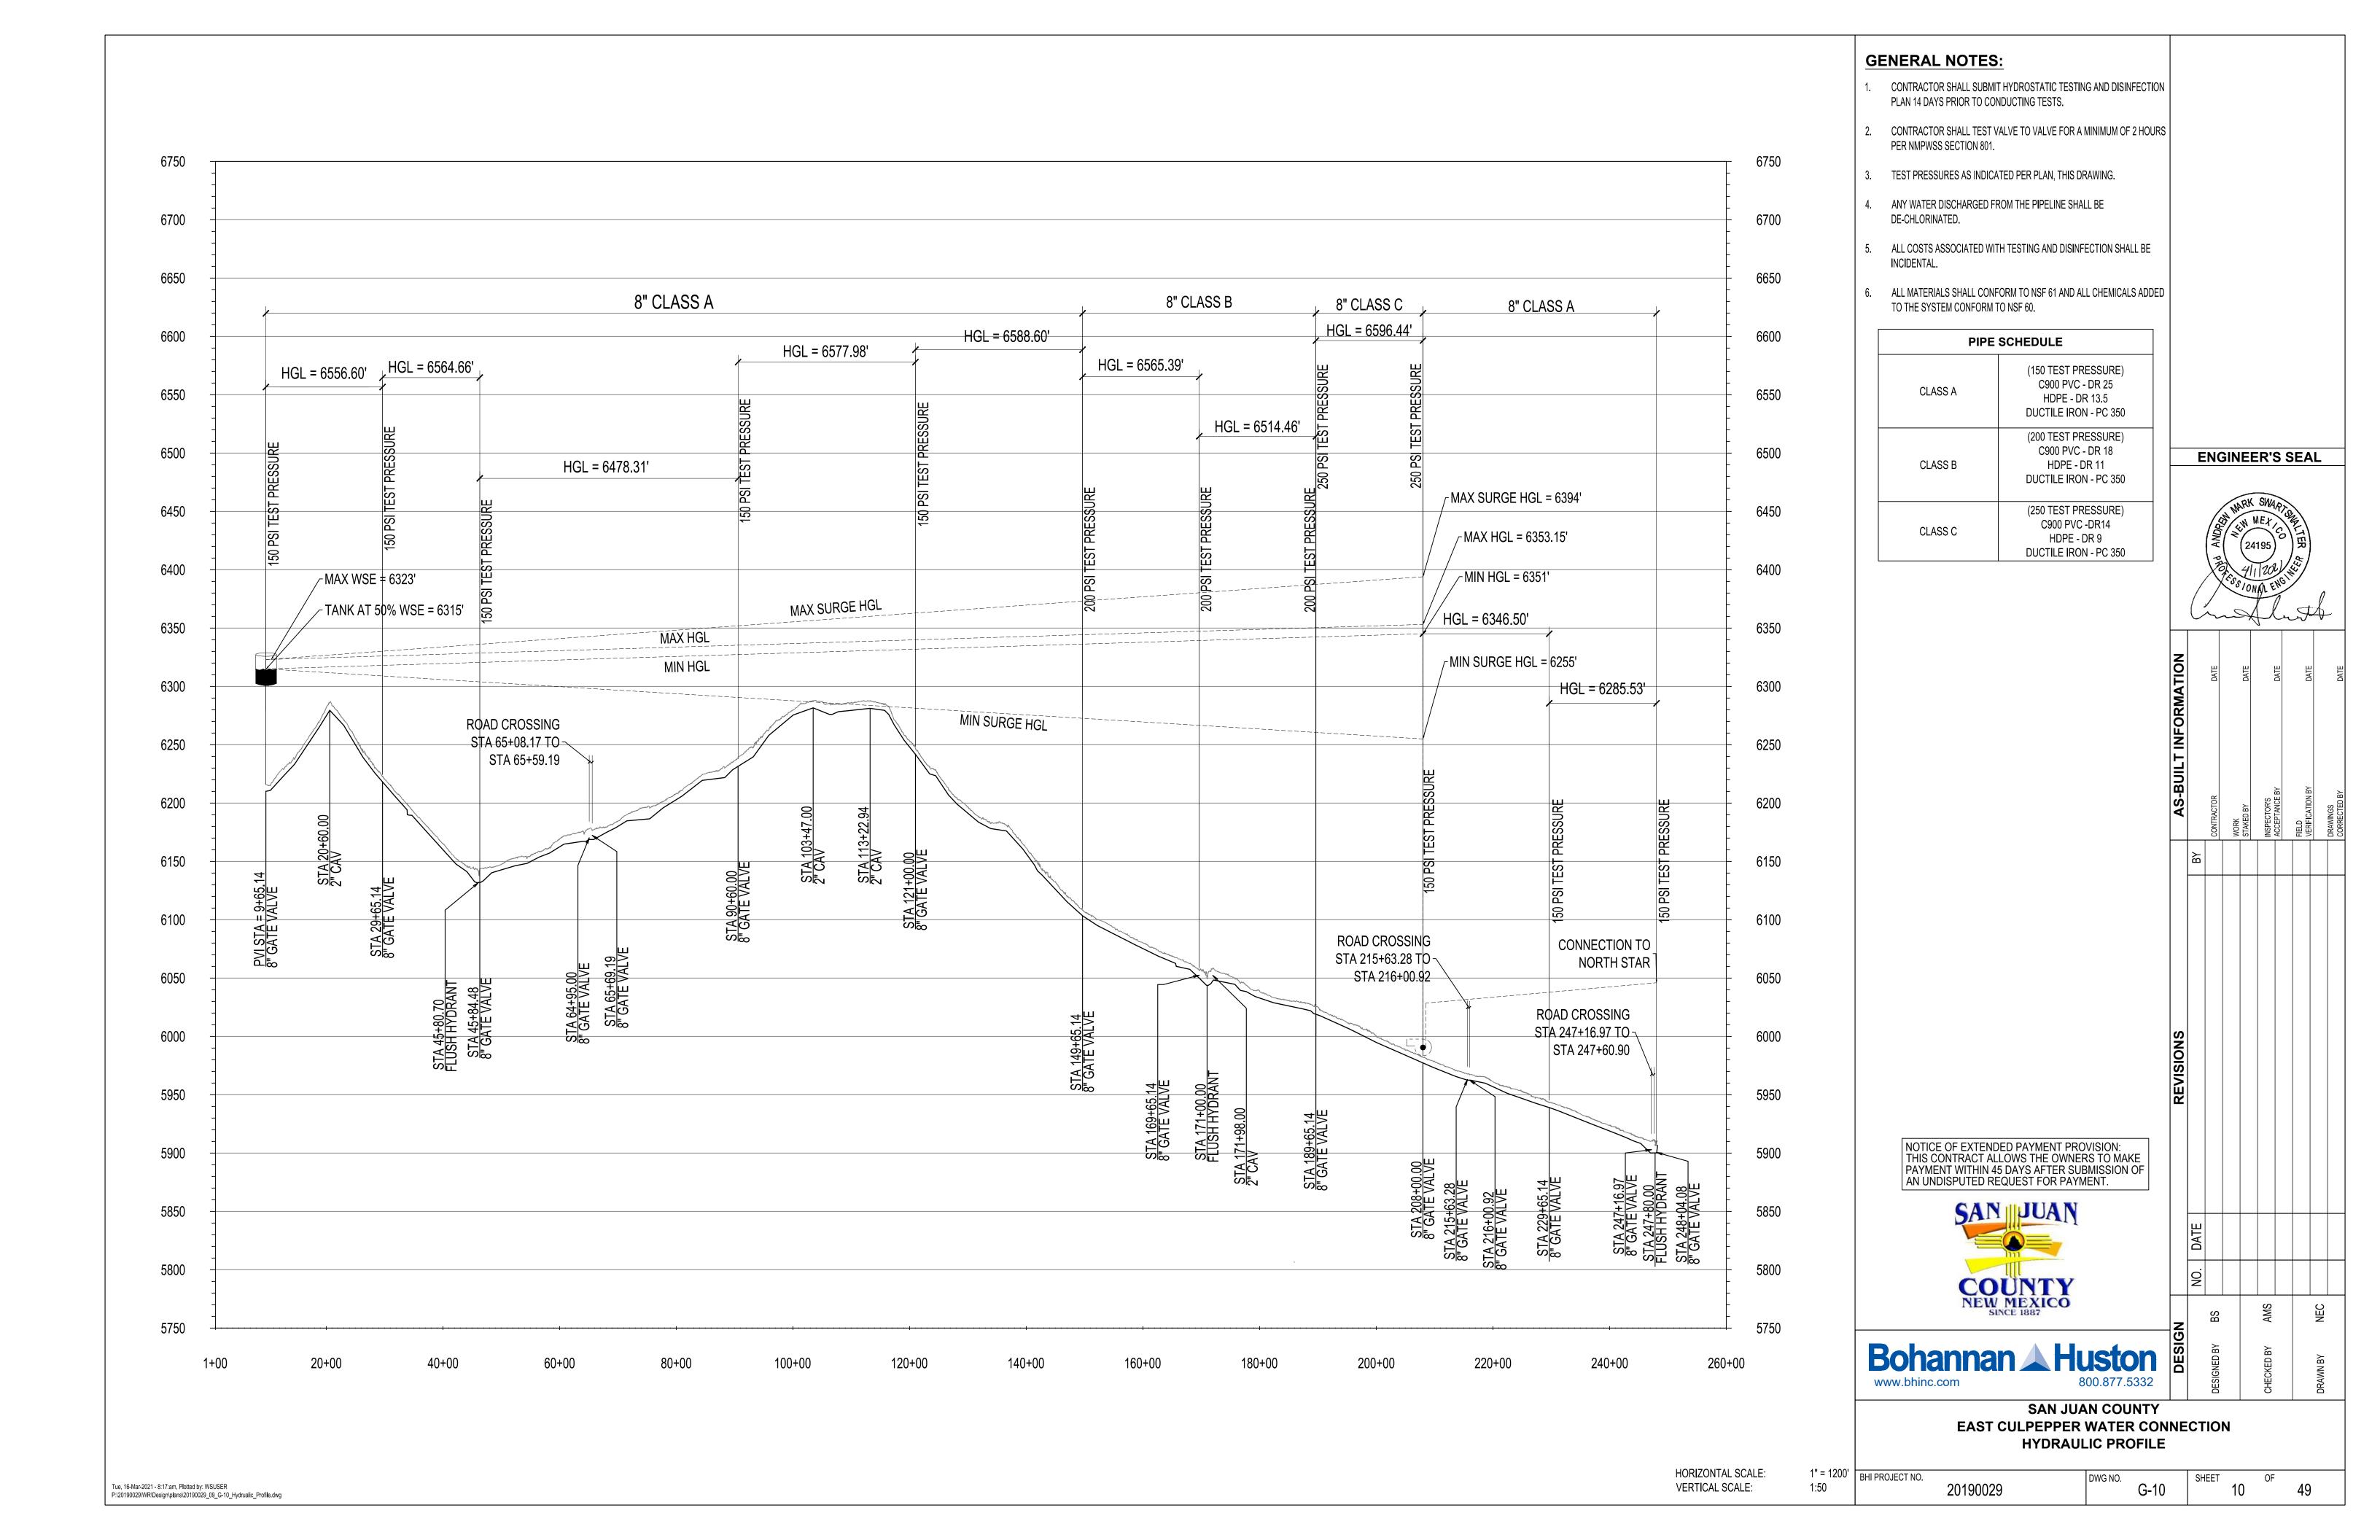


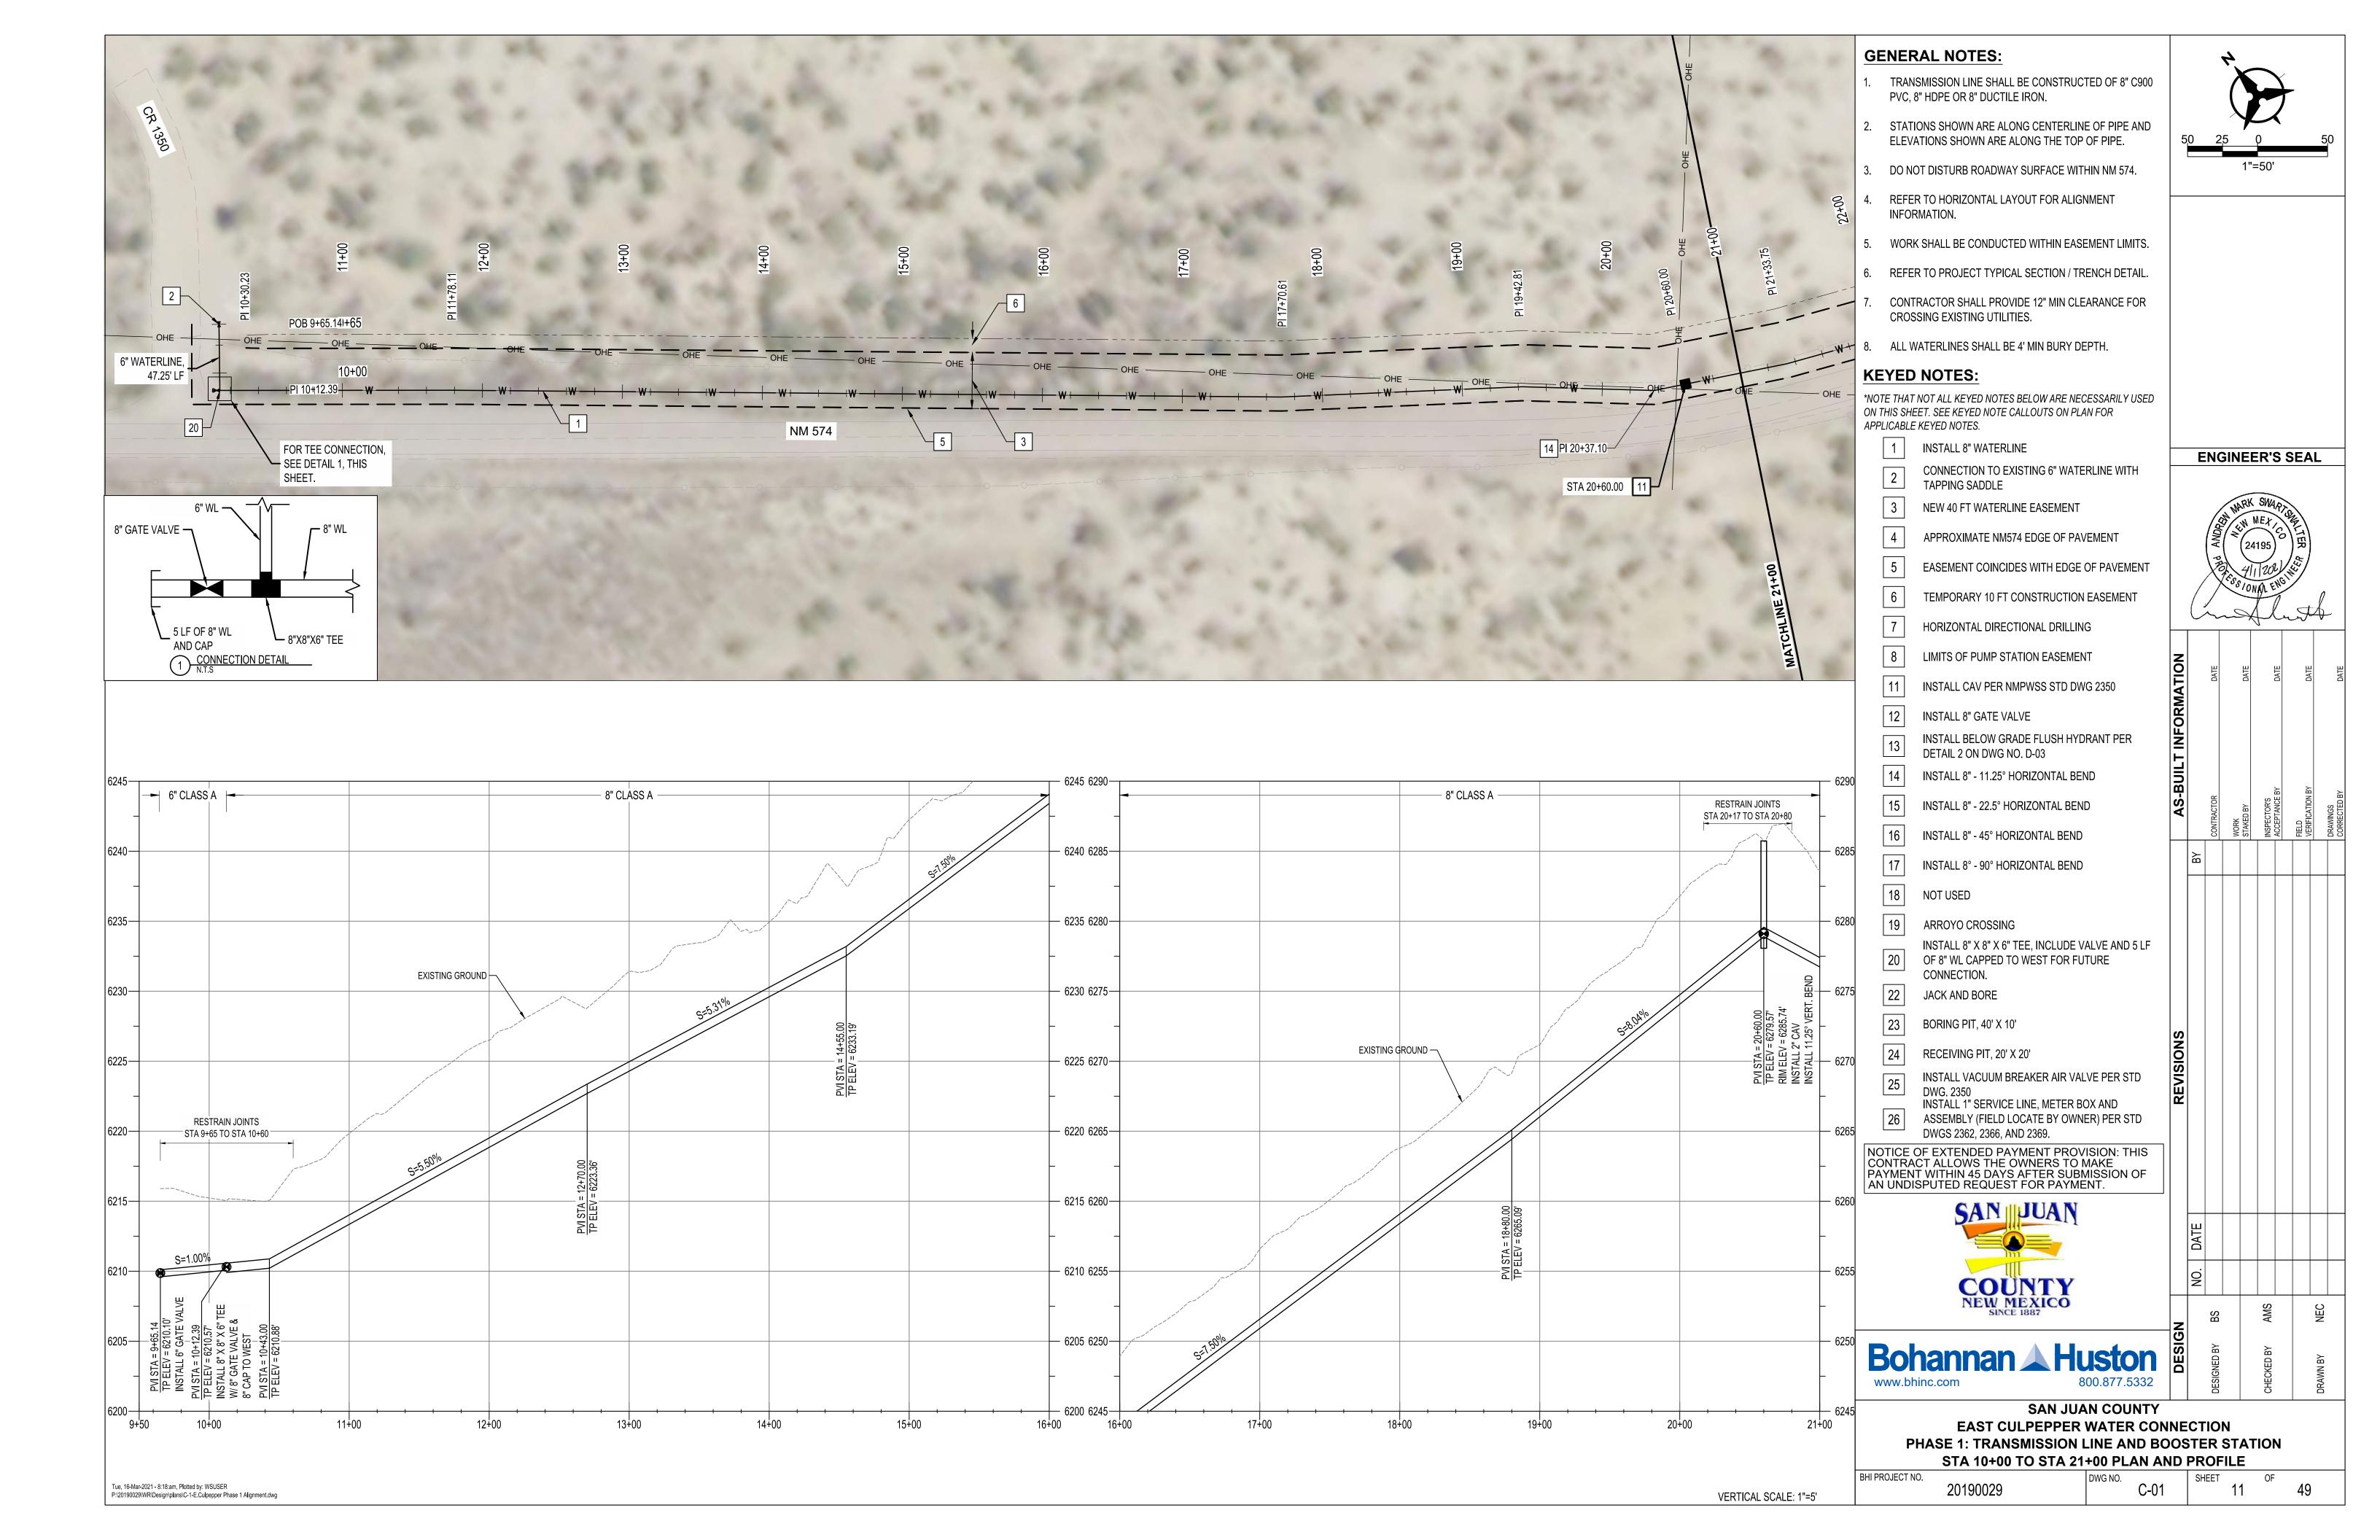

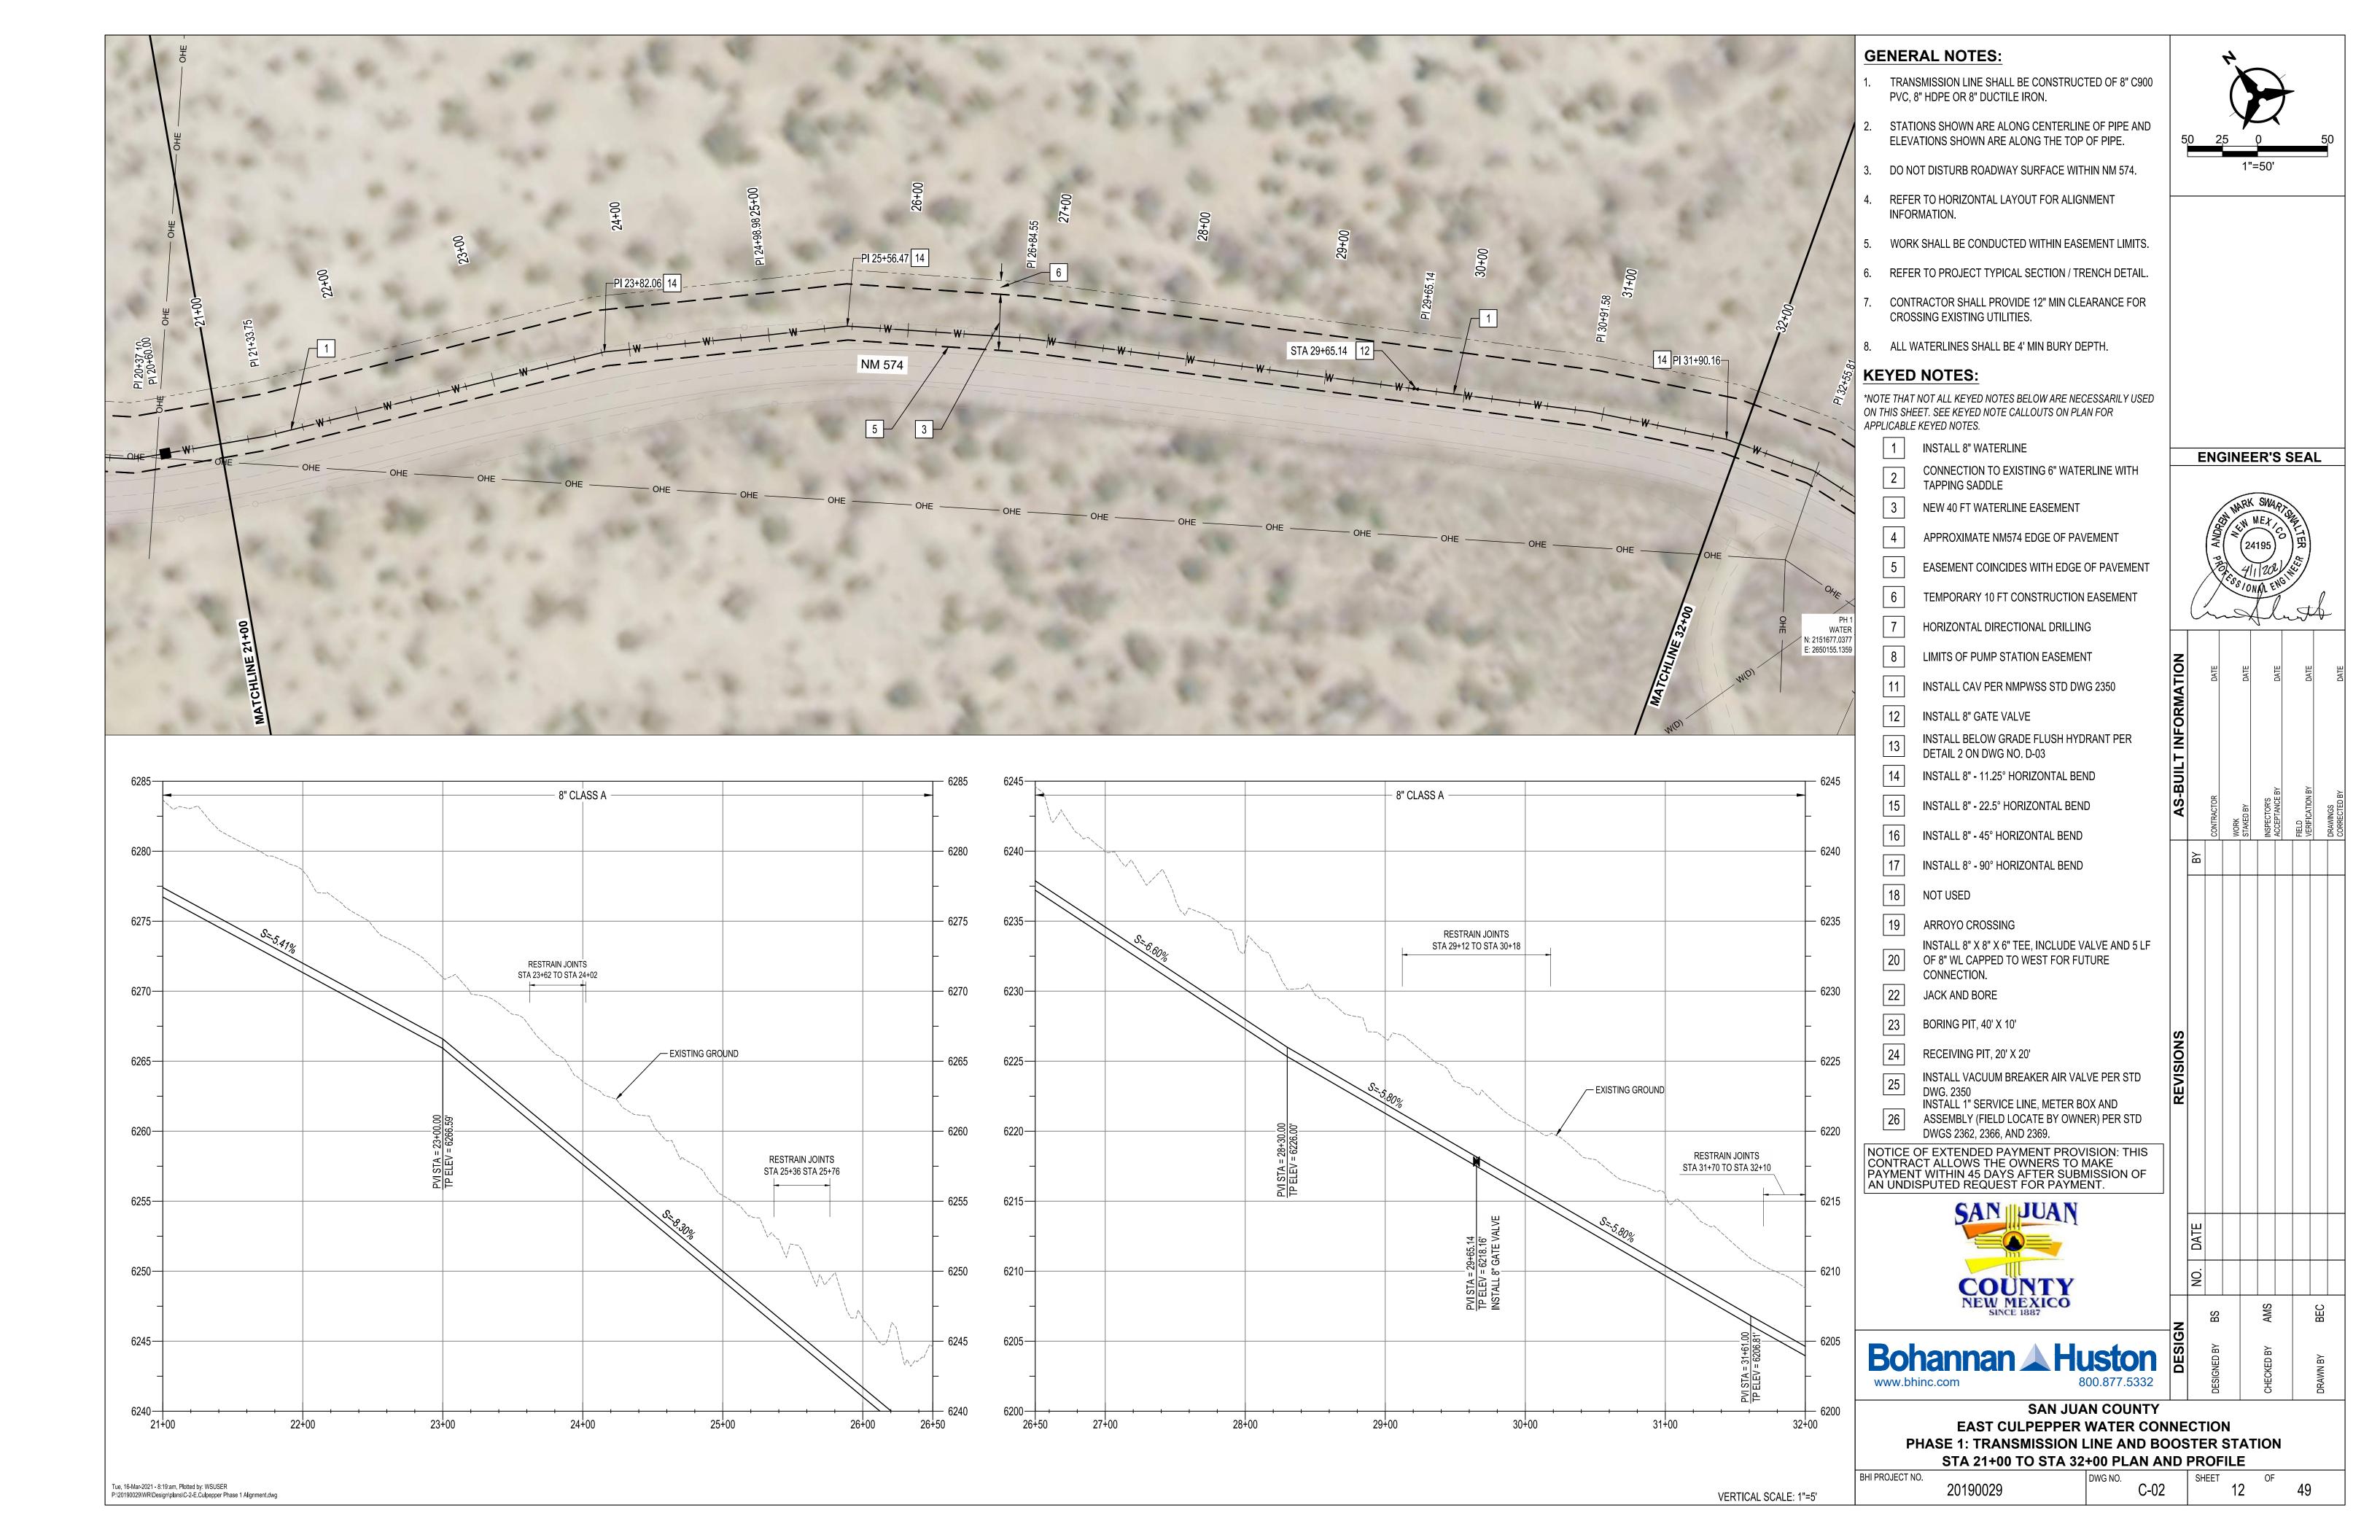

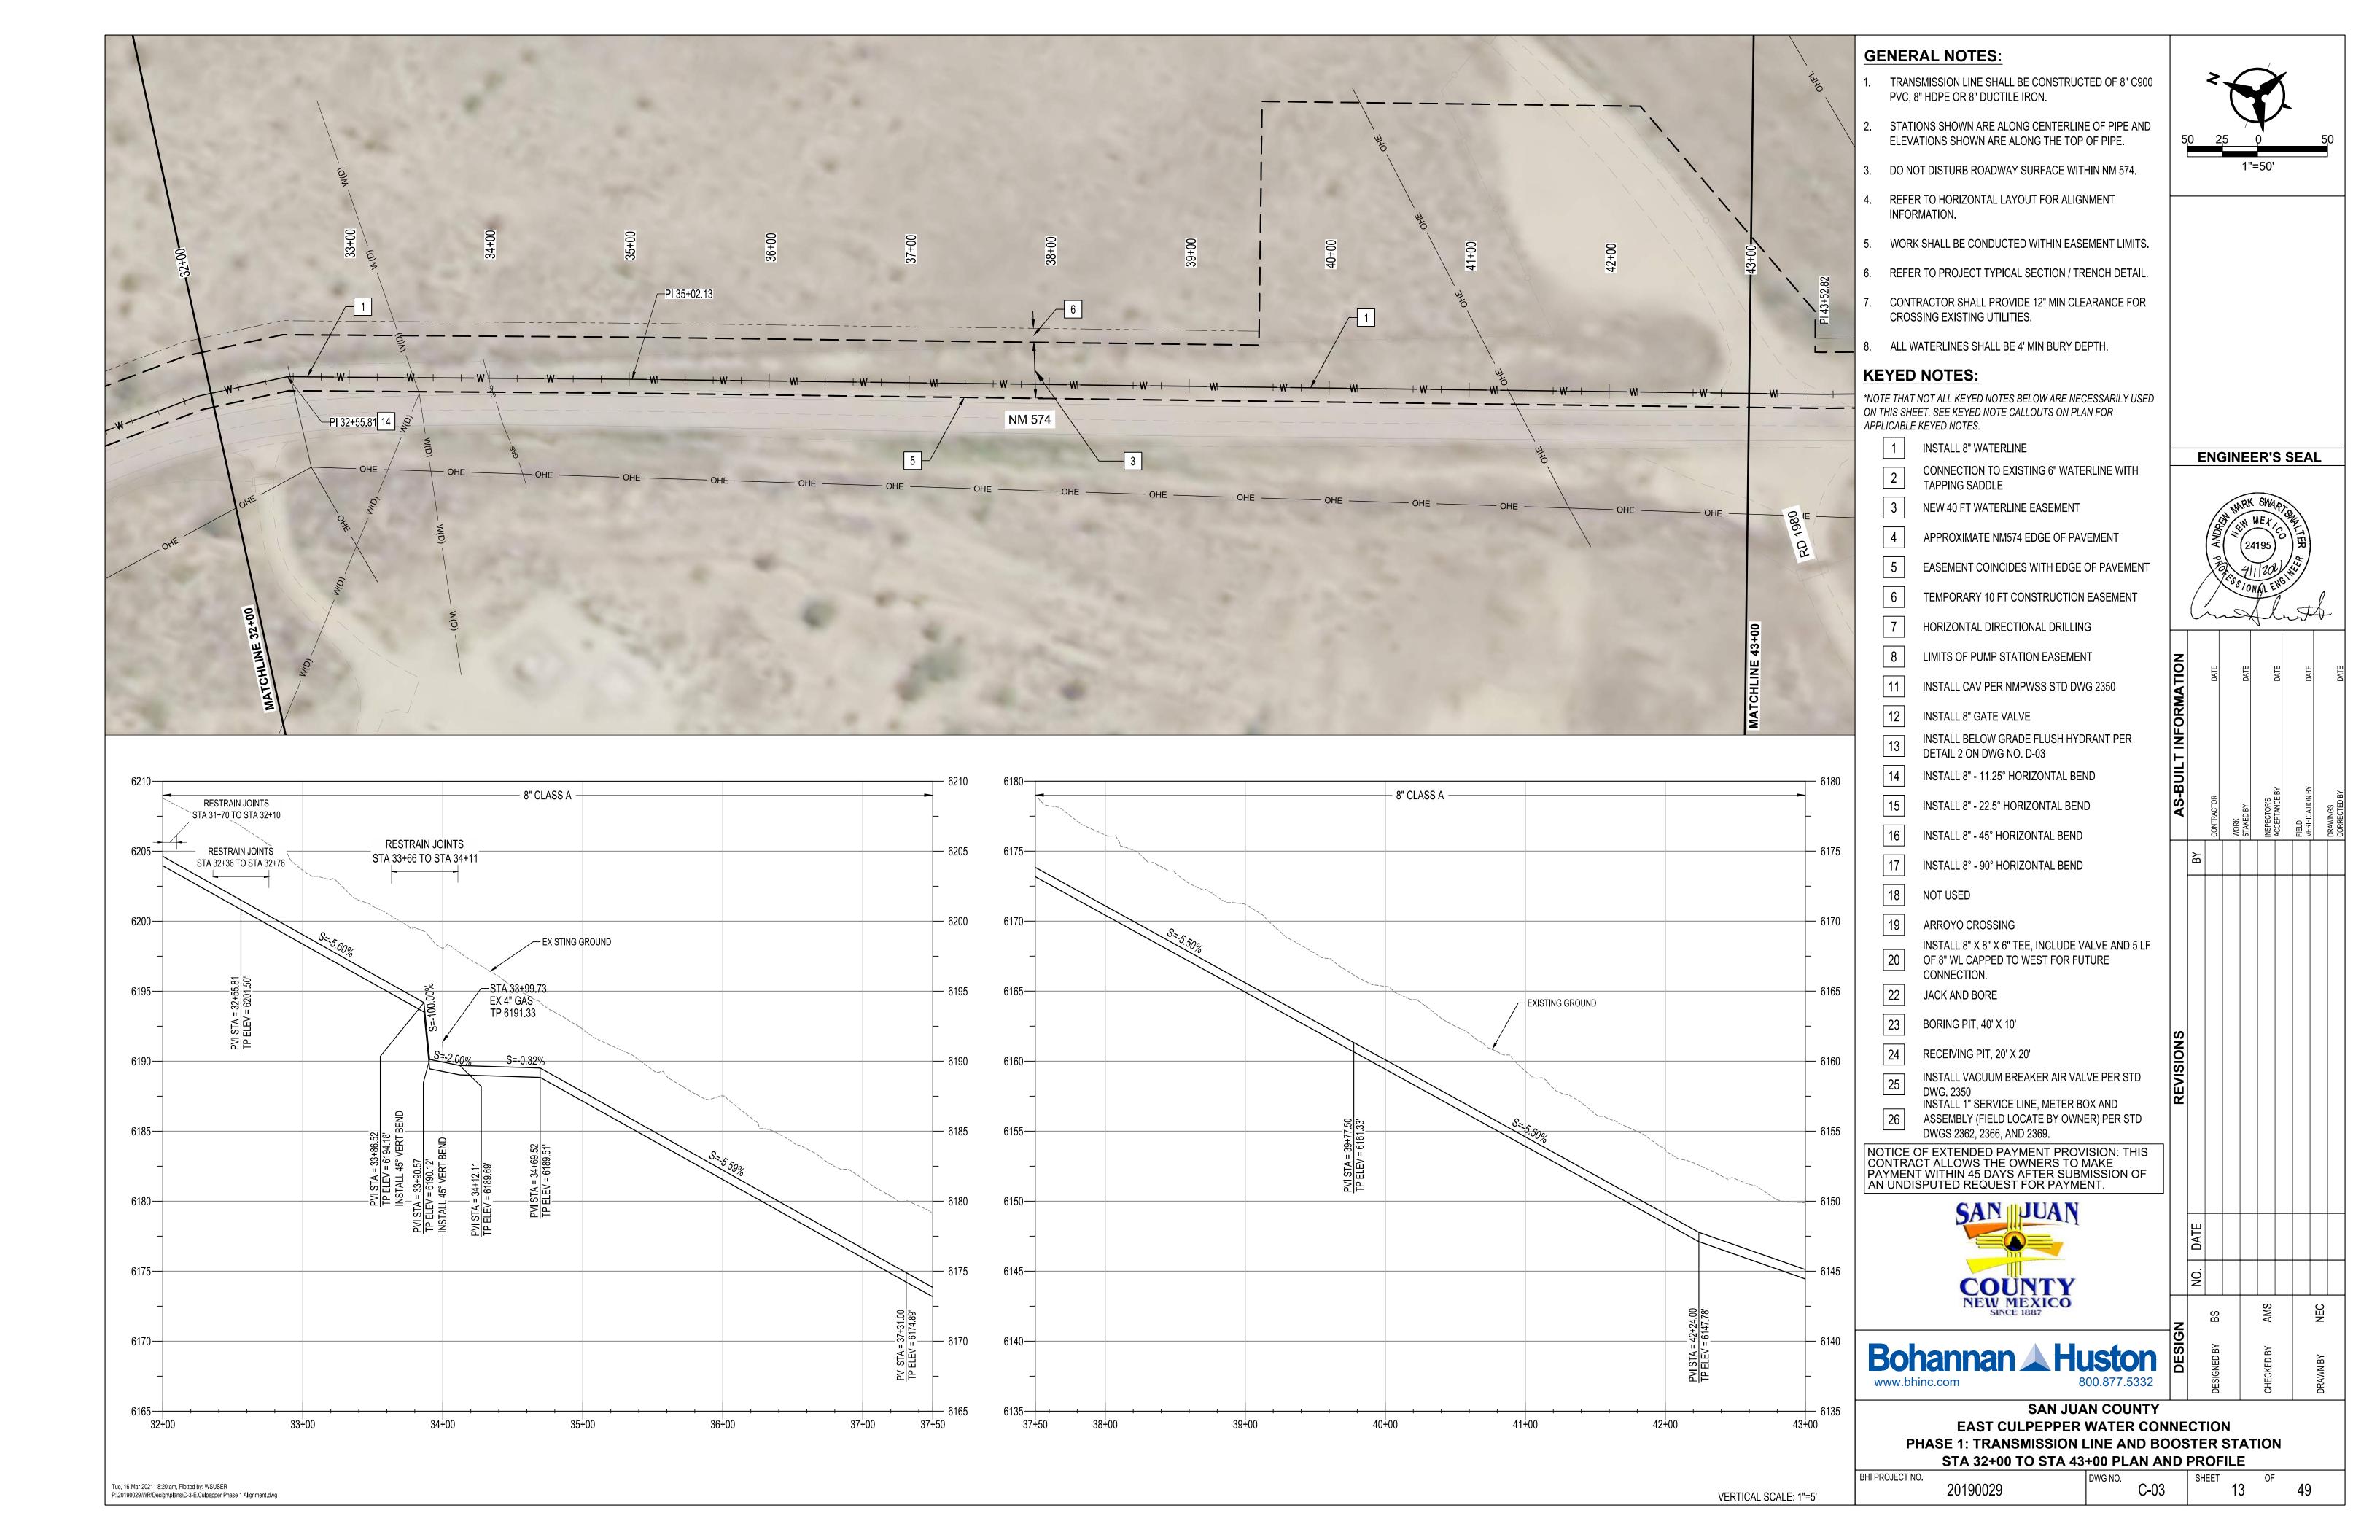

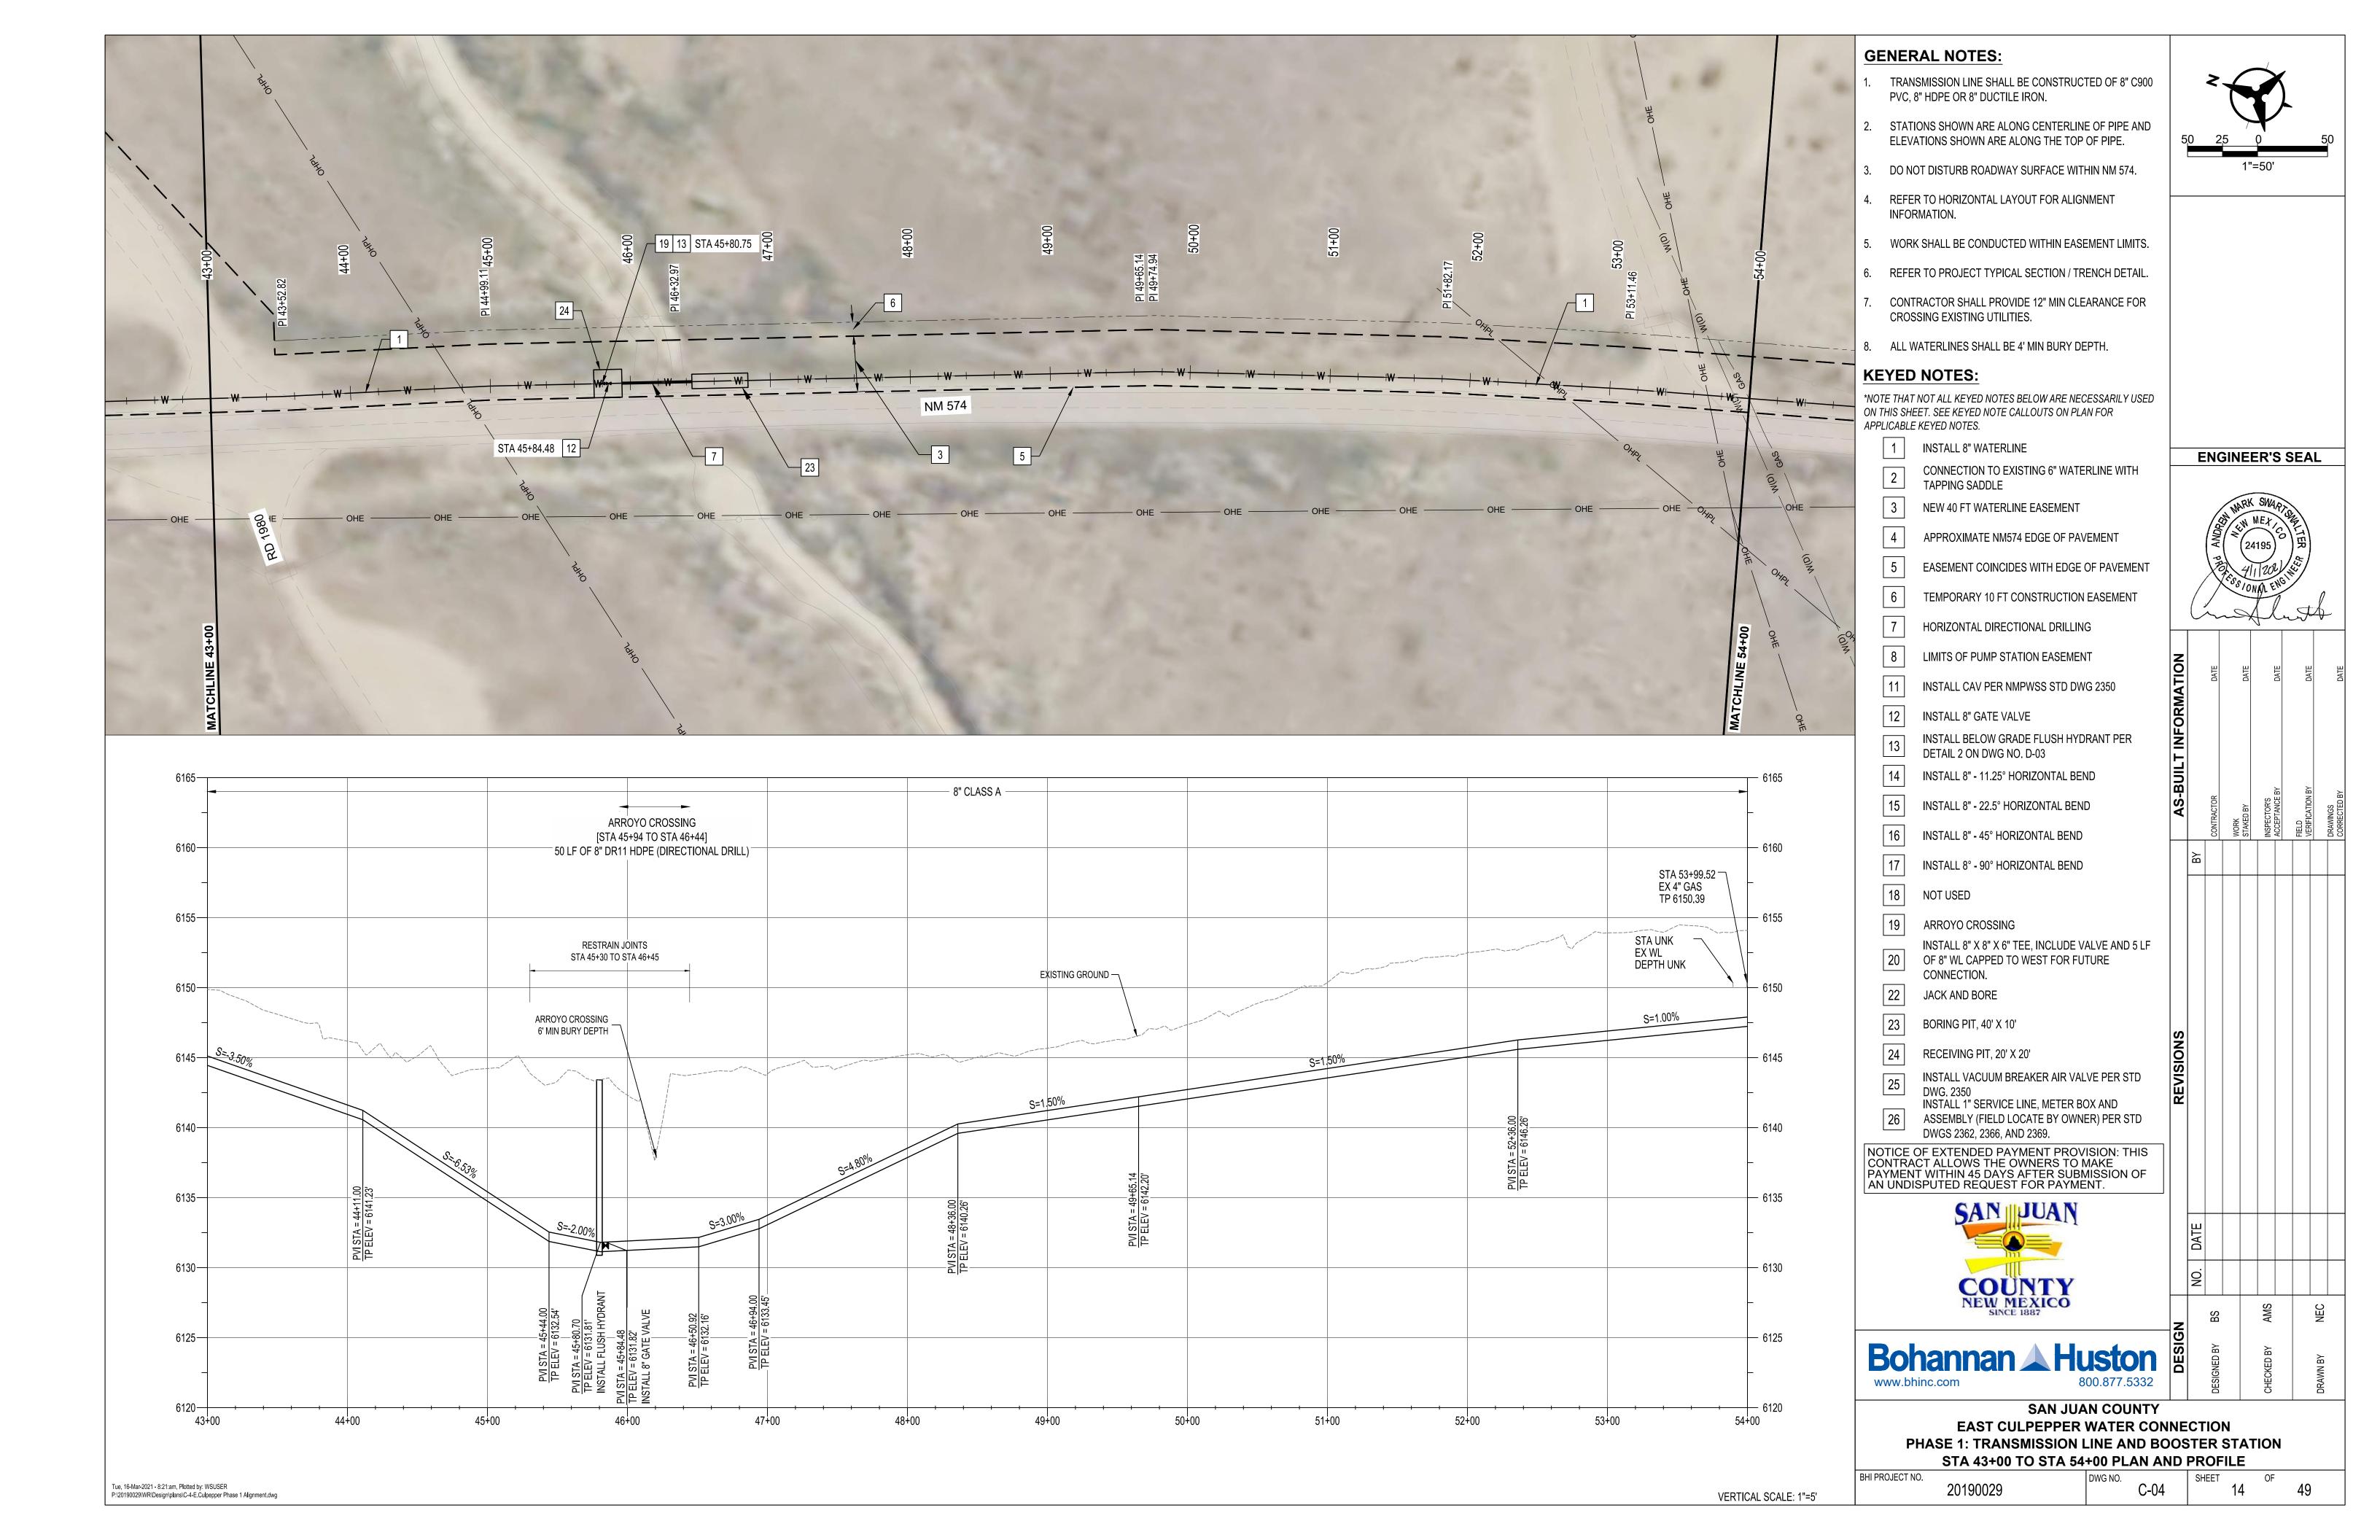

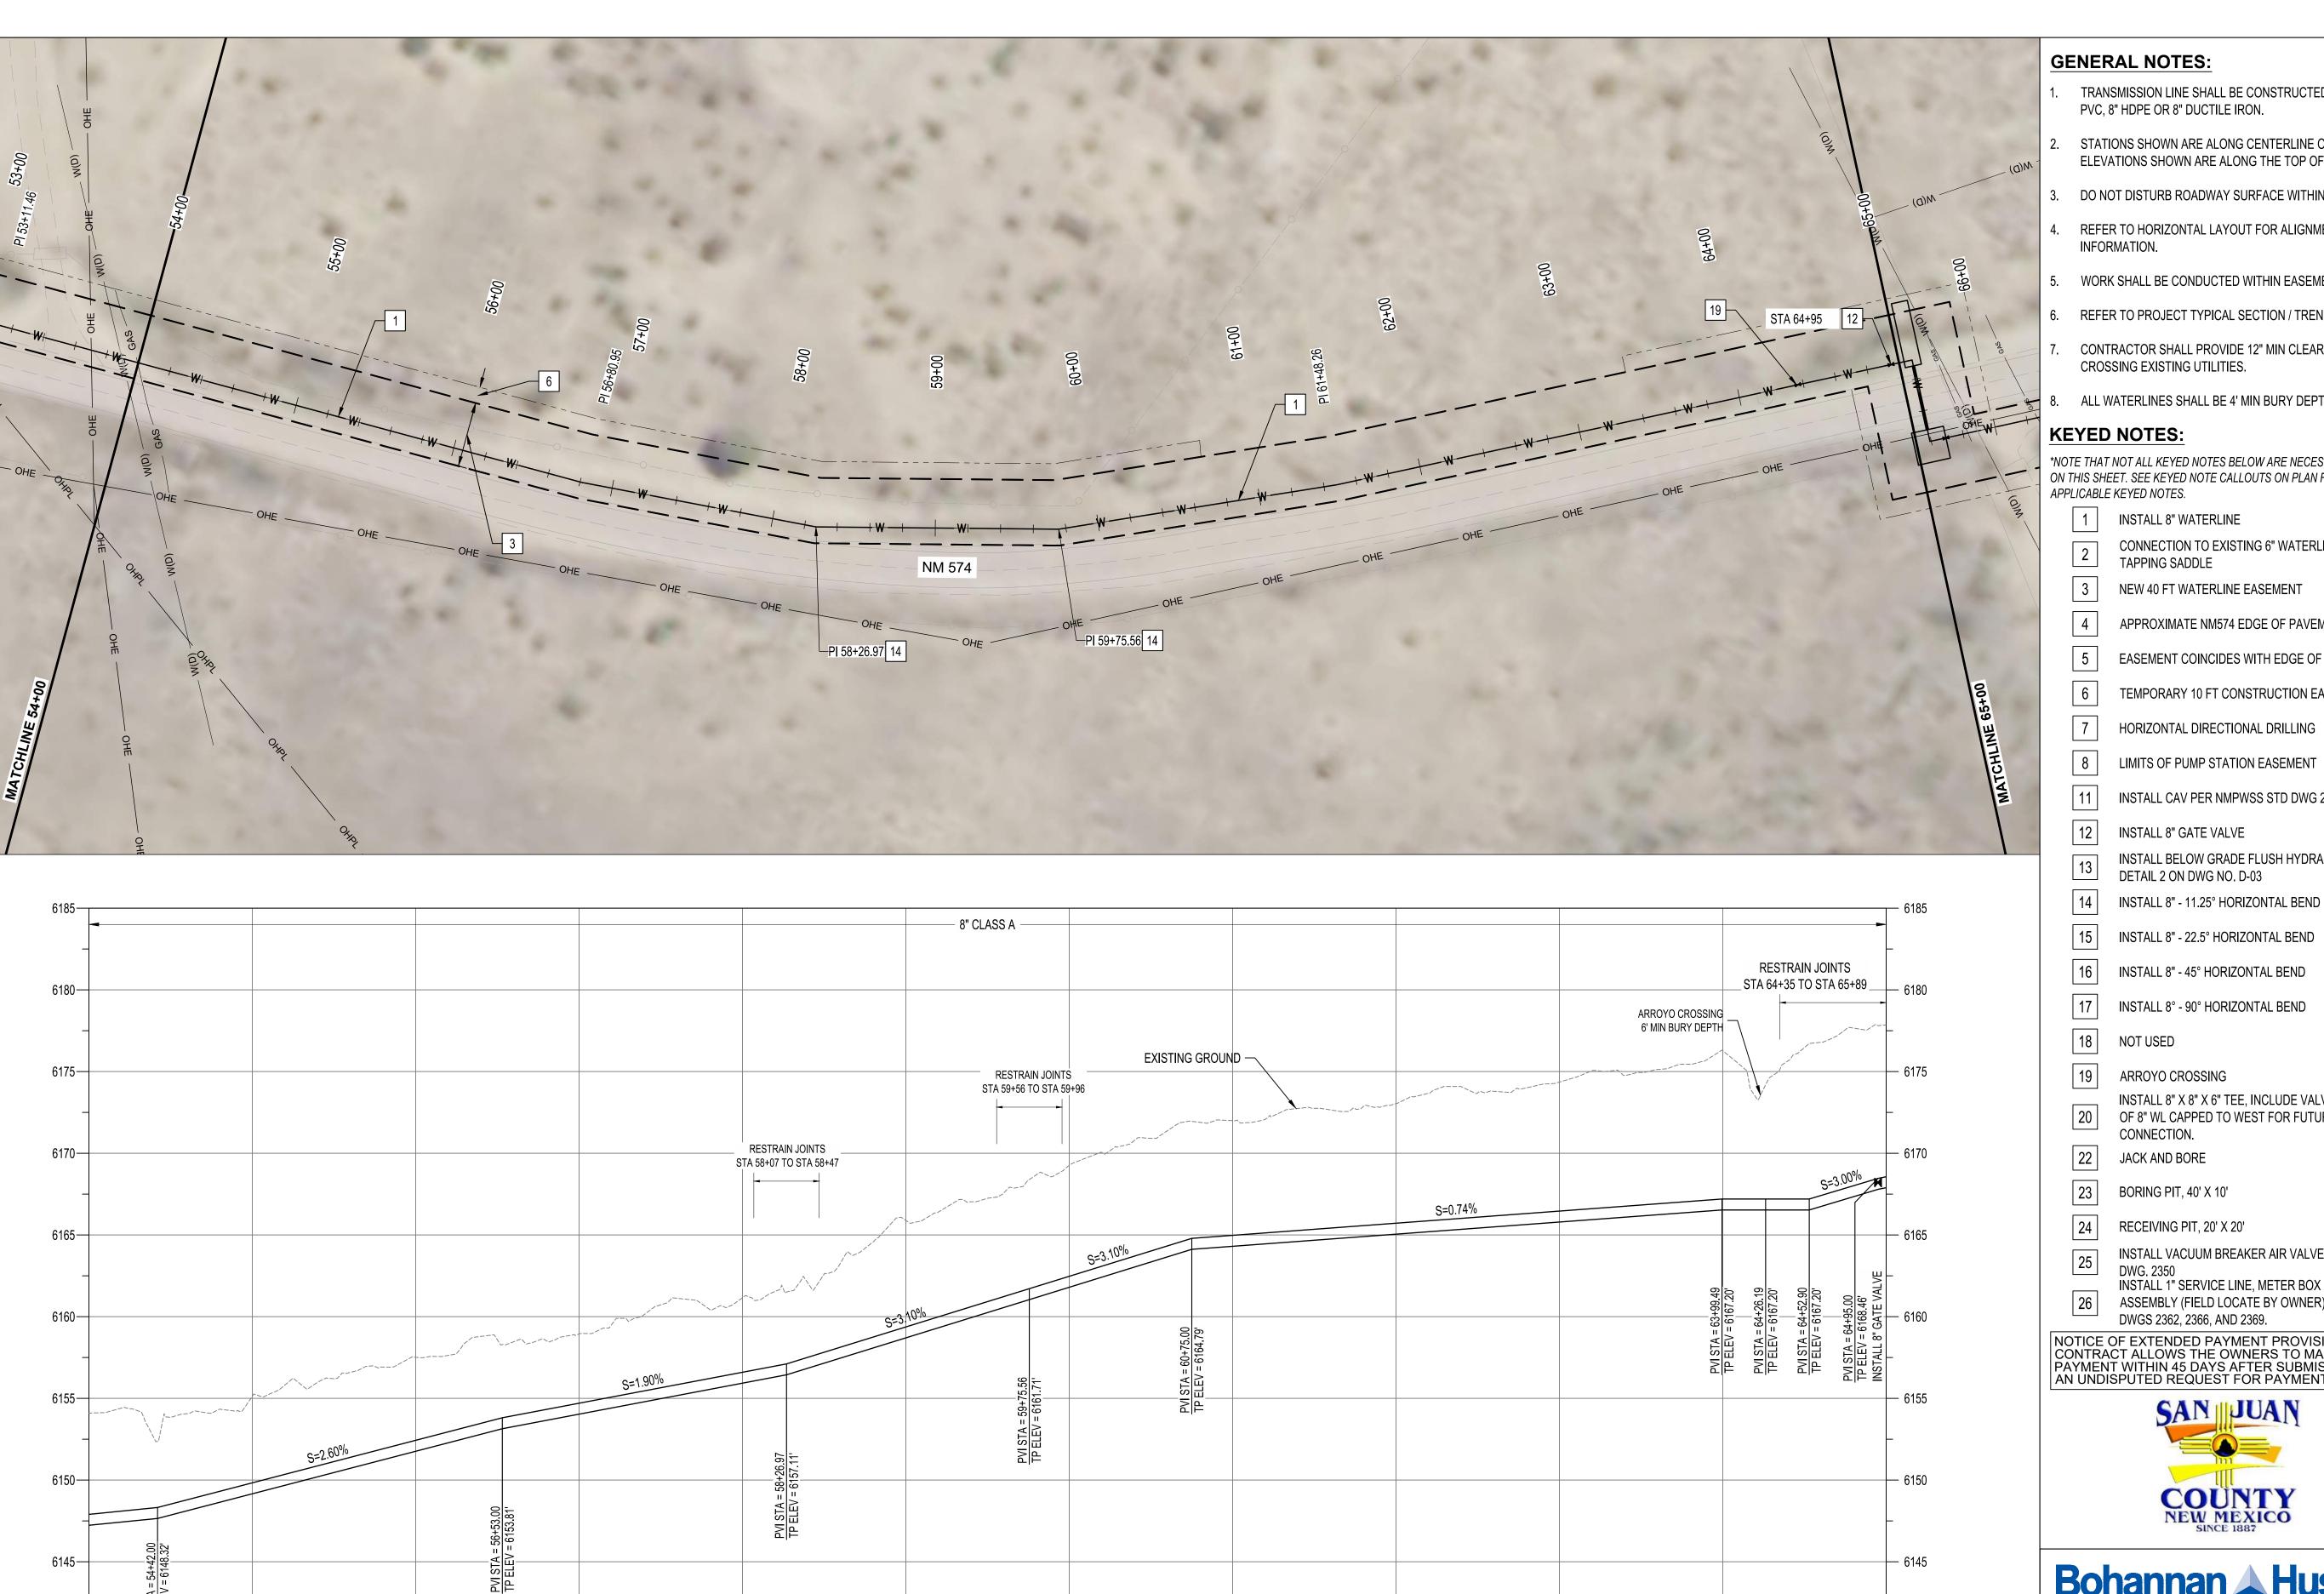

61÷00

56÷00

Tue, 16-Mar-2021 - 8:23:am, Plotted by: WSUSER

P:\20190029\WR\Design\plans\C-5-E.Culpepper Phase 1 Alignment.dwg

57÷00

GENERAL NOTES:

- TRANSMISSION LINE SHALL BE CONSTRUCTED OF 8" C900 PVC, 8" HDPE OR 8" DUCTILE IRON.
 - STATIONS SHOWN ARE ALONG CENTERLINE OF PIPE AND ELEVATIONS SHOWN ARE ALONG THE TOP OF PIPE.
 - DO NOT DISTURB ROADWAY SURFACE WITHIN NM 574.
- REFER TO HORIZONTAL LAYOUT FOR ALIGNMENT
- 5. WORK SHALL BE CONDUCTED WITHIN EASEMENT LIMITS.
- REFER TO PROJECT TYPICAL SECTION / TRENCH DETAIL.
- CONTRACTOR SHALL PROVIDE 12" MIN CLEARANCE FOR CROSSING EXISTING UTILITIES.
- ALL WATERLINES SHALL BE 4' MIN BURY DEPTH.

*NOTE THAT NOT ALL KEYED NOTES BELOW ARE NECESSARILY USED ON THIS SHEET. SEE KEYED NOTE CALLOUTS ON PLAN FOR APPLICABLE KEYED NOTES.

- **INSTALL 8" WATERLINE**
- CONNECTION TO EXISTING 6" WATERLINE WITH TAPPING SADDLE

ENGINEER'S SEAL

- NEW 40 FT WATERLINE EASEMENT
- APPROXIMATE NM574 EDGE OF PAVEMENT
- EASEMENT COINCIDES WITH EDGE OF PAVEMENT
- TEMPORARY 10 FT CONSTRUCTION EASEMENT
- HORIZONTAL DIRECTIONAL DRILLING
- LIMITS OF PUMP STATION EASEMENT
- INSTALL CAV PER NMPWSS STD DWG 2350
- **INSTALL 8" GATE VALVE**
- INSTALL BELOW GRADE FLUSH HYDRANT PER
- DETAIL 2 ON DWG NO. D-03
- INSTALL 8" 22.5° HORIZONTAL BEND
- INSTALL 8" 45° HORIZONTAL BEND
- INSTALL 8° 90° HORIZONTAL BEND
- NOT USED
- ARROYO CROSSING
- INSTALL 8" X 8" X 6" TEE, INCLUDE VALVE AND 5 LF OF 8" WL CAPPED TO WEST FOR FUTURE
- JACK AND BORE
- BORING PIT, 40' X 10'
- RECEIVING PIT, 20' X 20'

www.bhinc.com

65÷00

VERTICAL SCALE: 1"=5'

- INSTALL VACUUM BREAKER AIR VALVE PER STD
- INSTALL 1" SERVICE LINE, METER BOX AND ASSEMBLY (FIELD LOCATE BY OWNER) PER STD
- NOTICE OF EXTENDED PAYMENT PROVISION: THIS CONTRACT ALLOWS THE OWNERS TO MAKE PAYMENT WITHIN 45 DAYS AFTER SUBMISSION OF AN UNDISPUTED REQUEST FOR PAYMENT.





NEW MEXICO SINCE 1887


SAN JUAN COUNTY


EAST CULPEPPER WATER CONNECTION PHASE 1: TRANSMISSION LINE AND BOOSTER STATION STA 54+00 TO STA 65+00 PLAN AND PROFILE


BHI PROJECT NO. 20190029

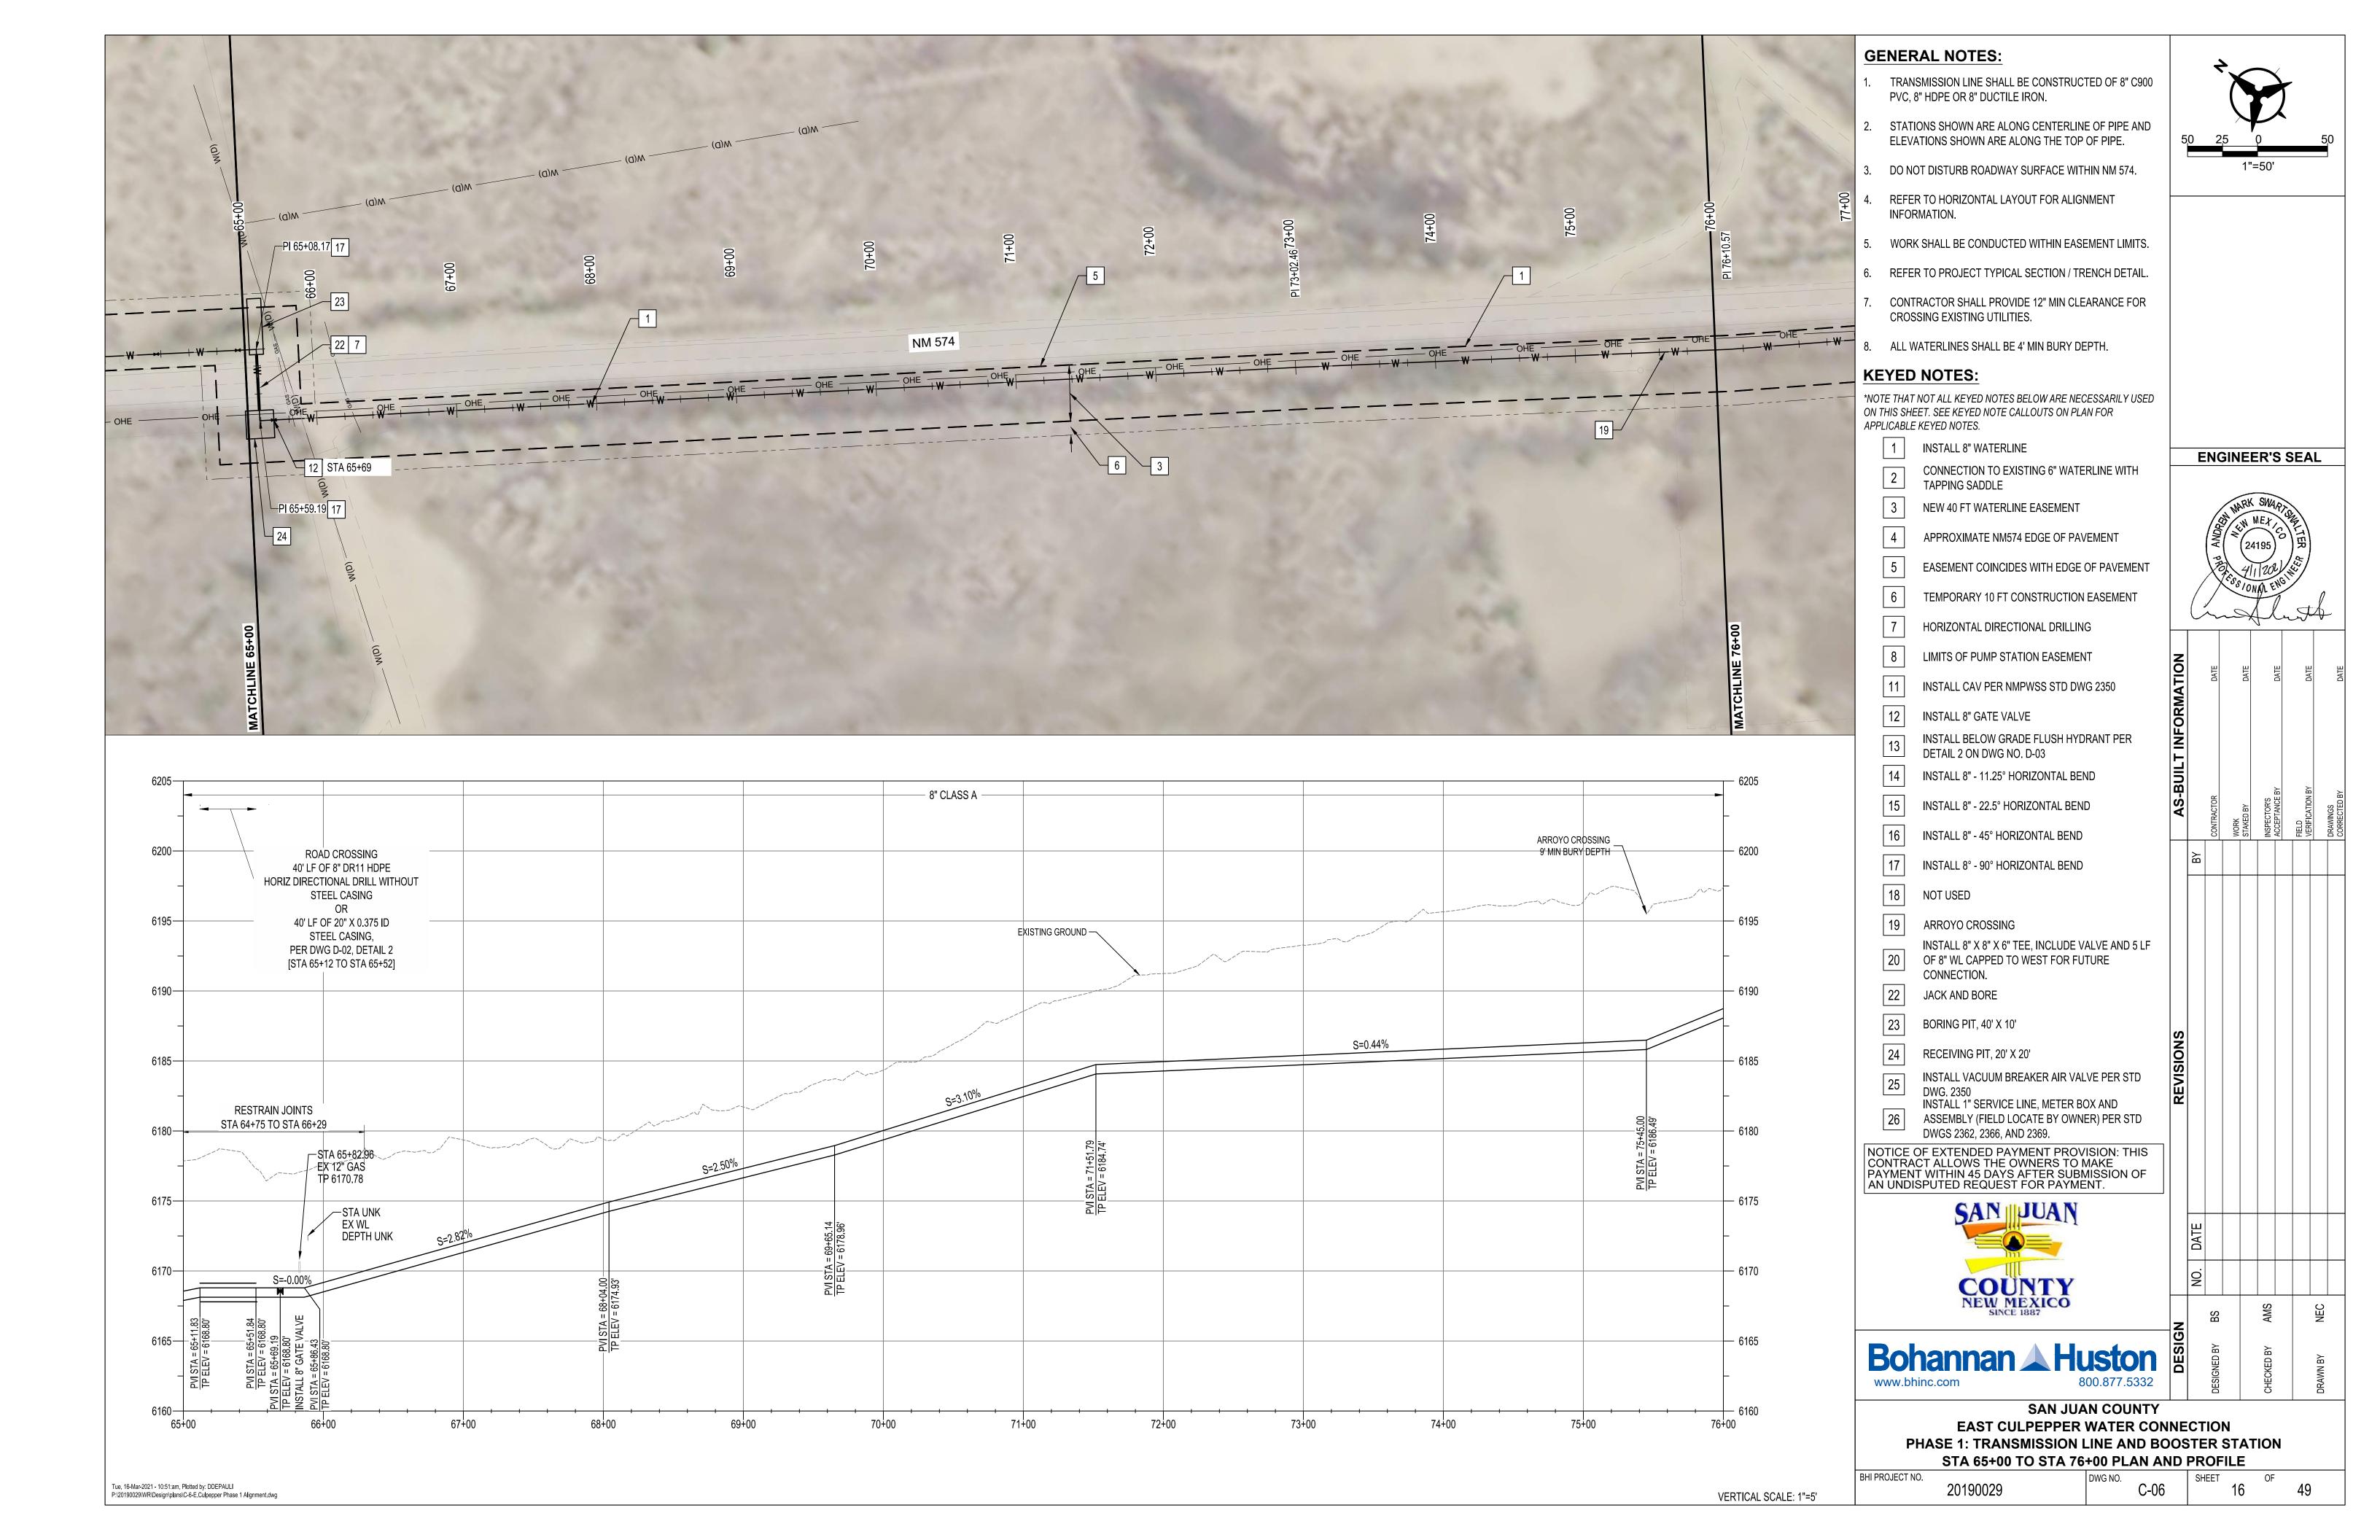


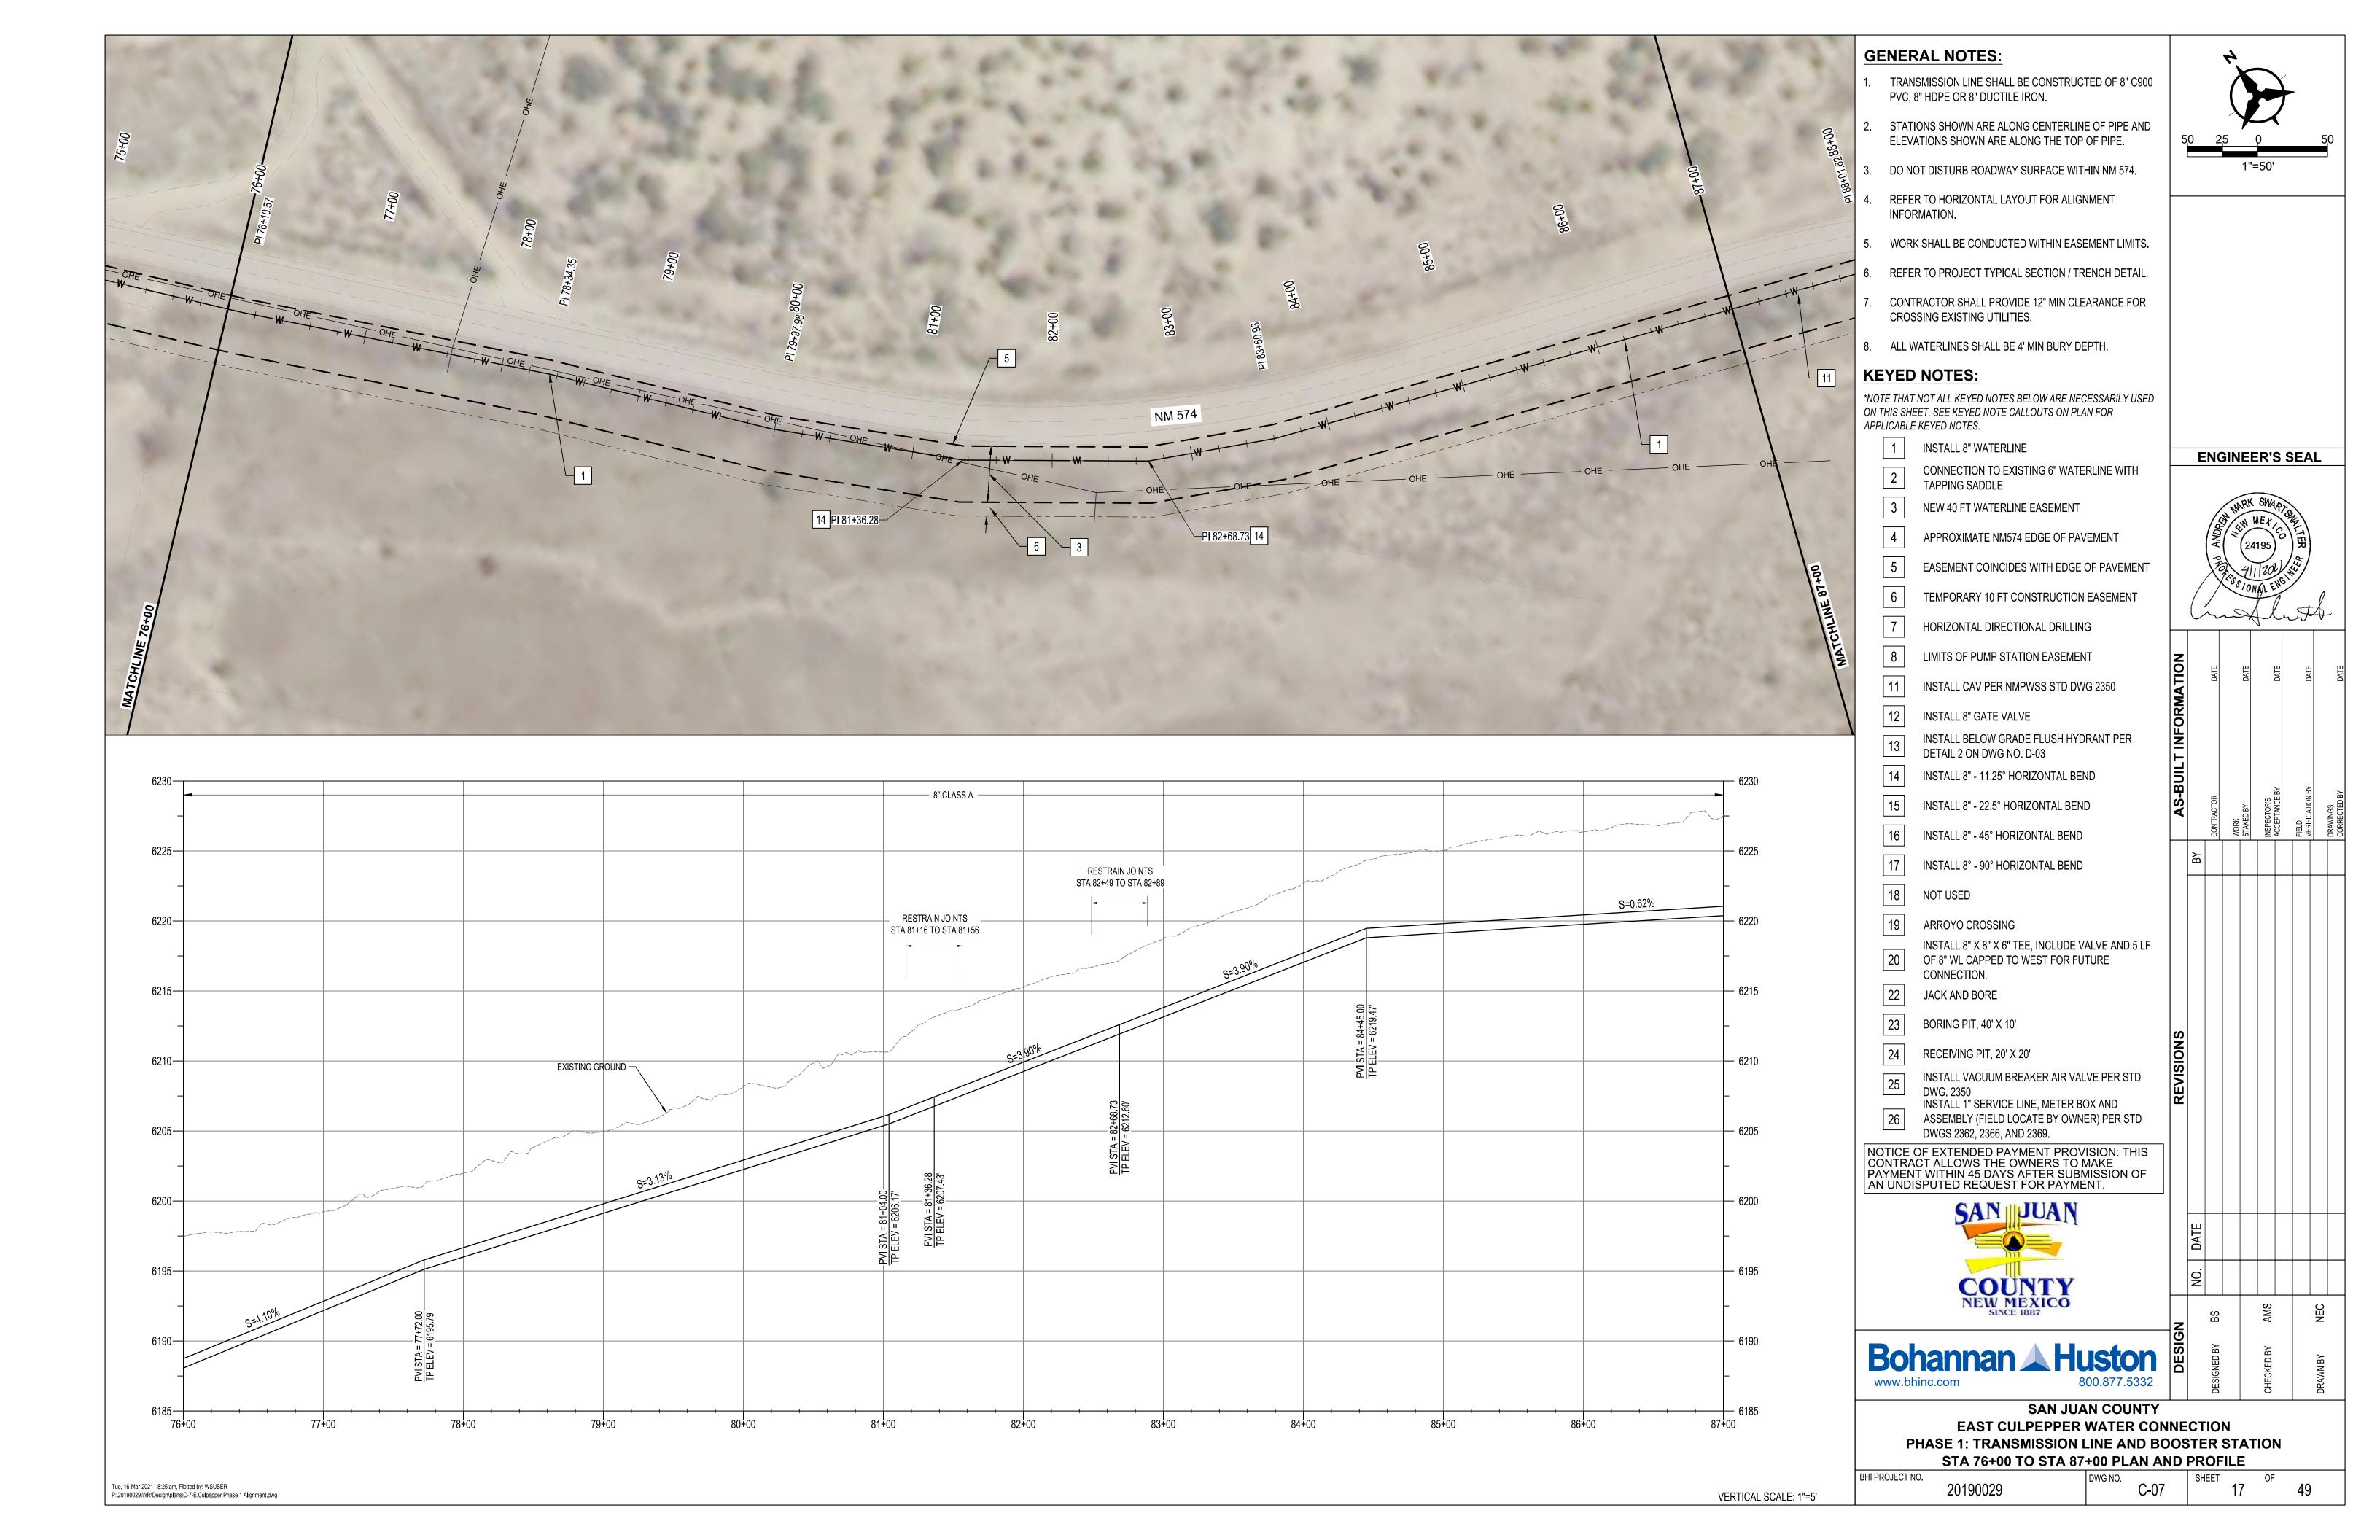

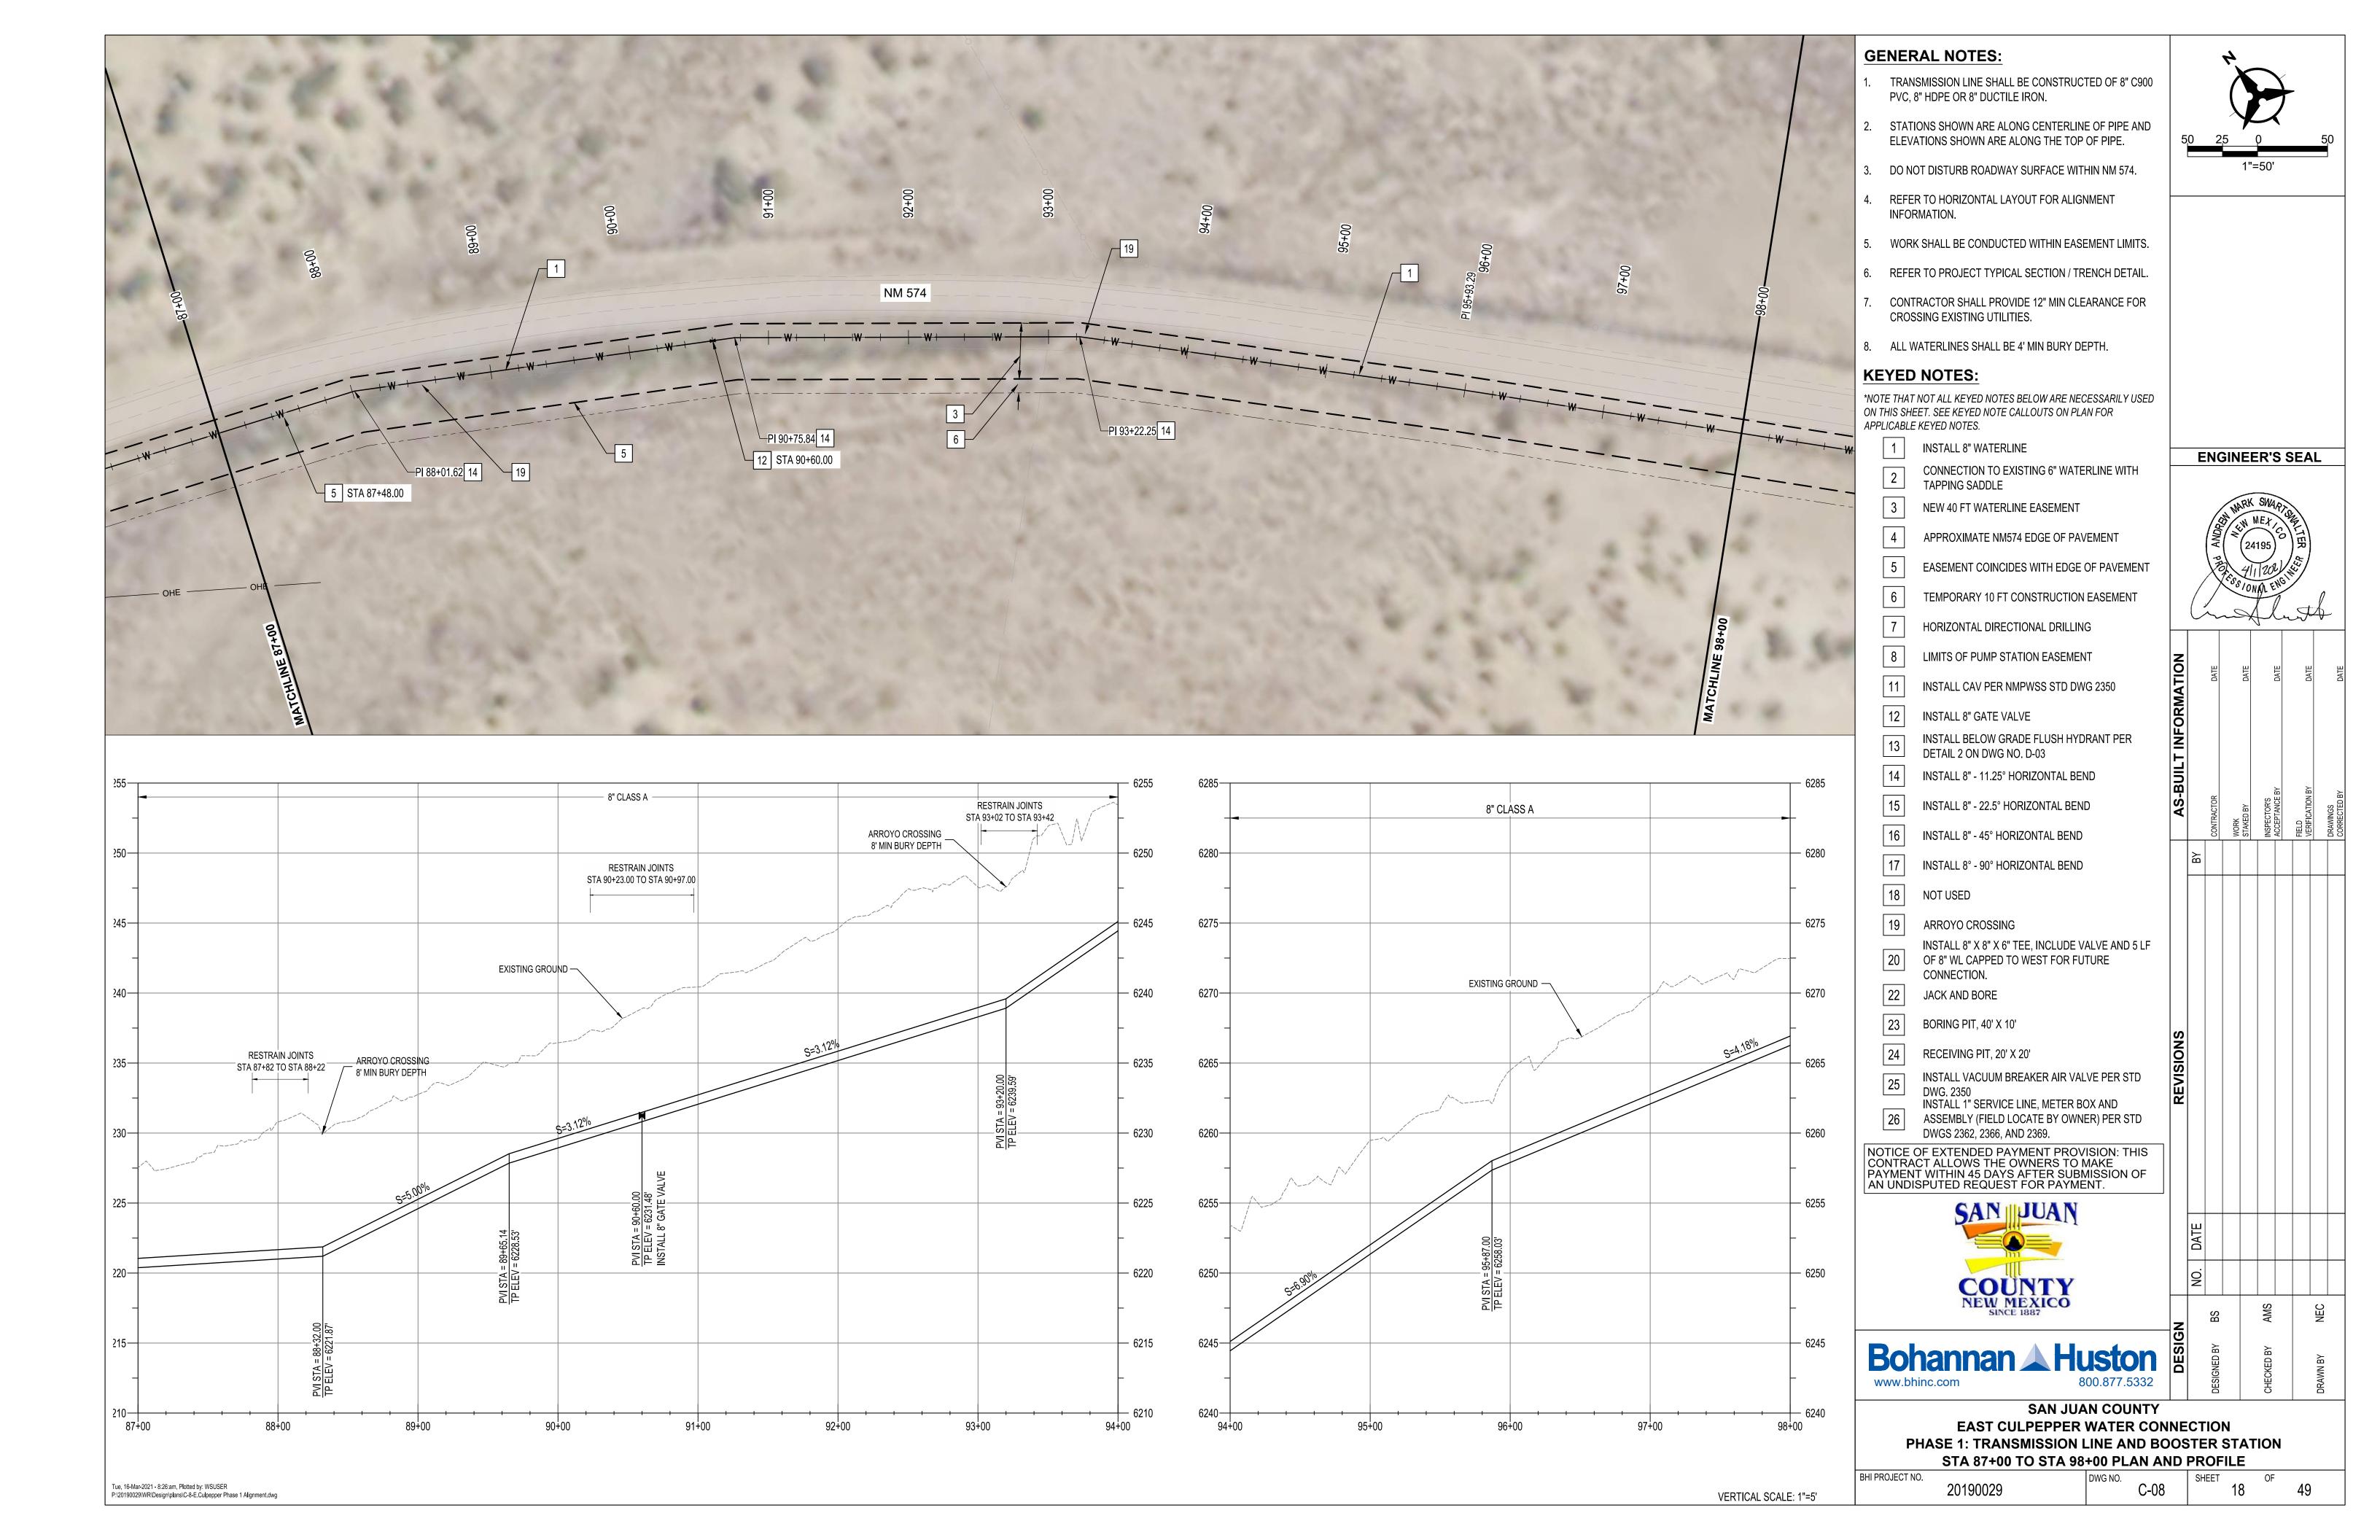

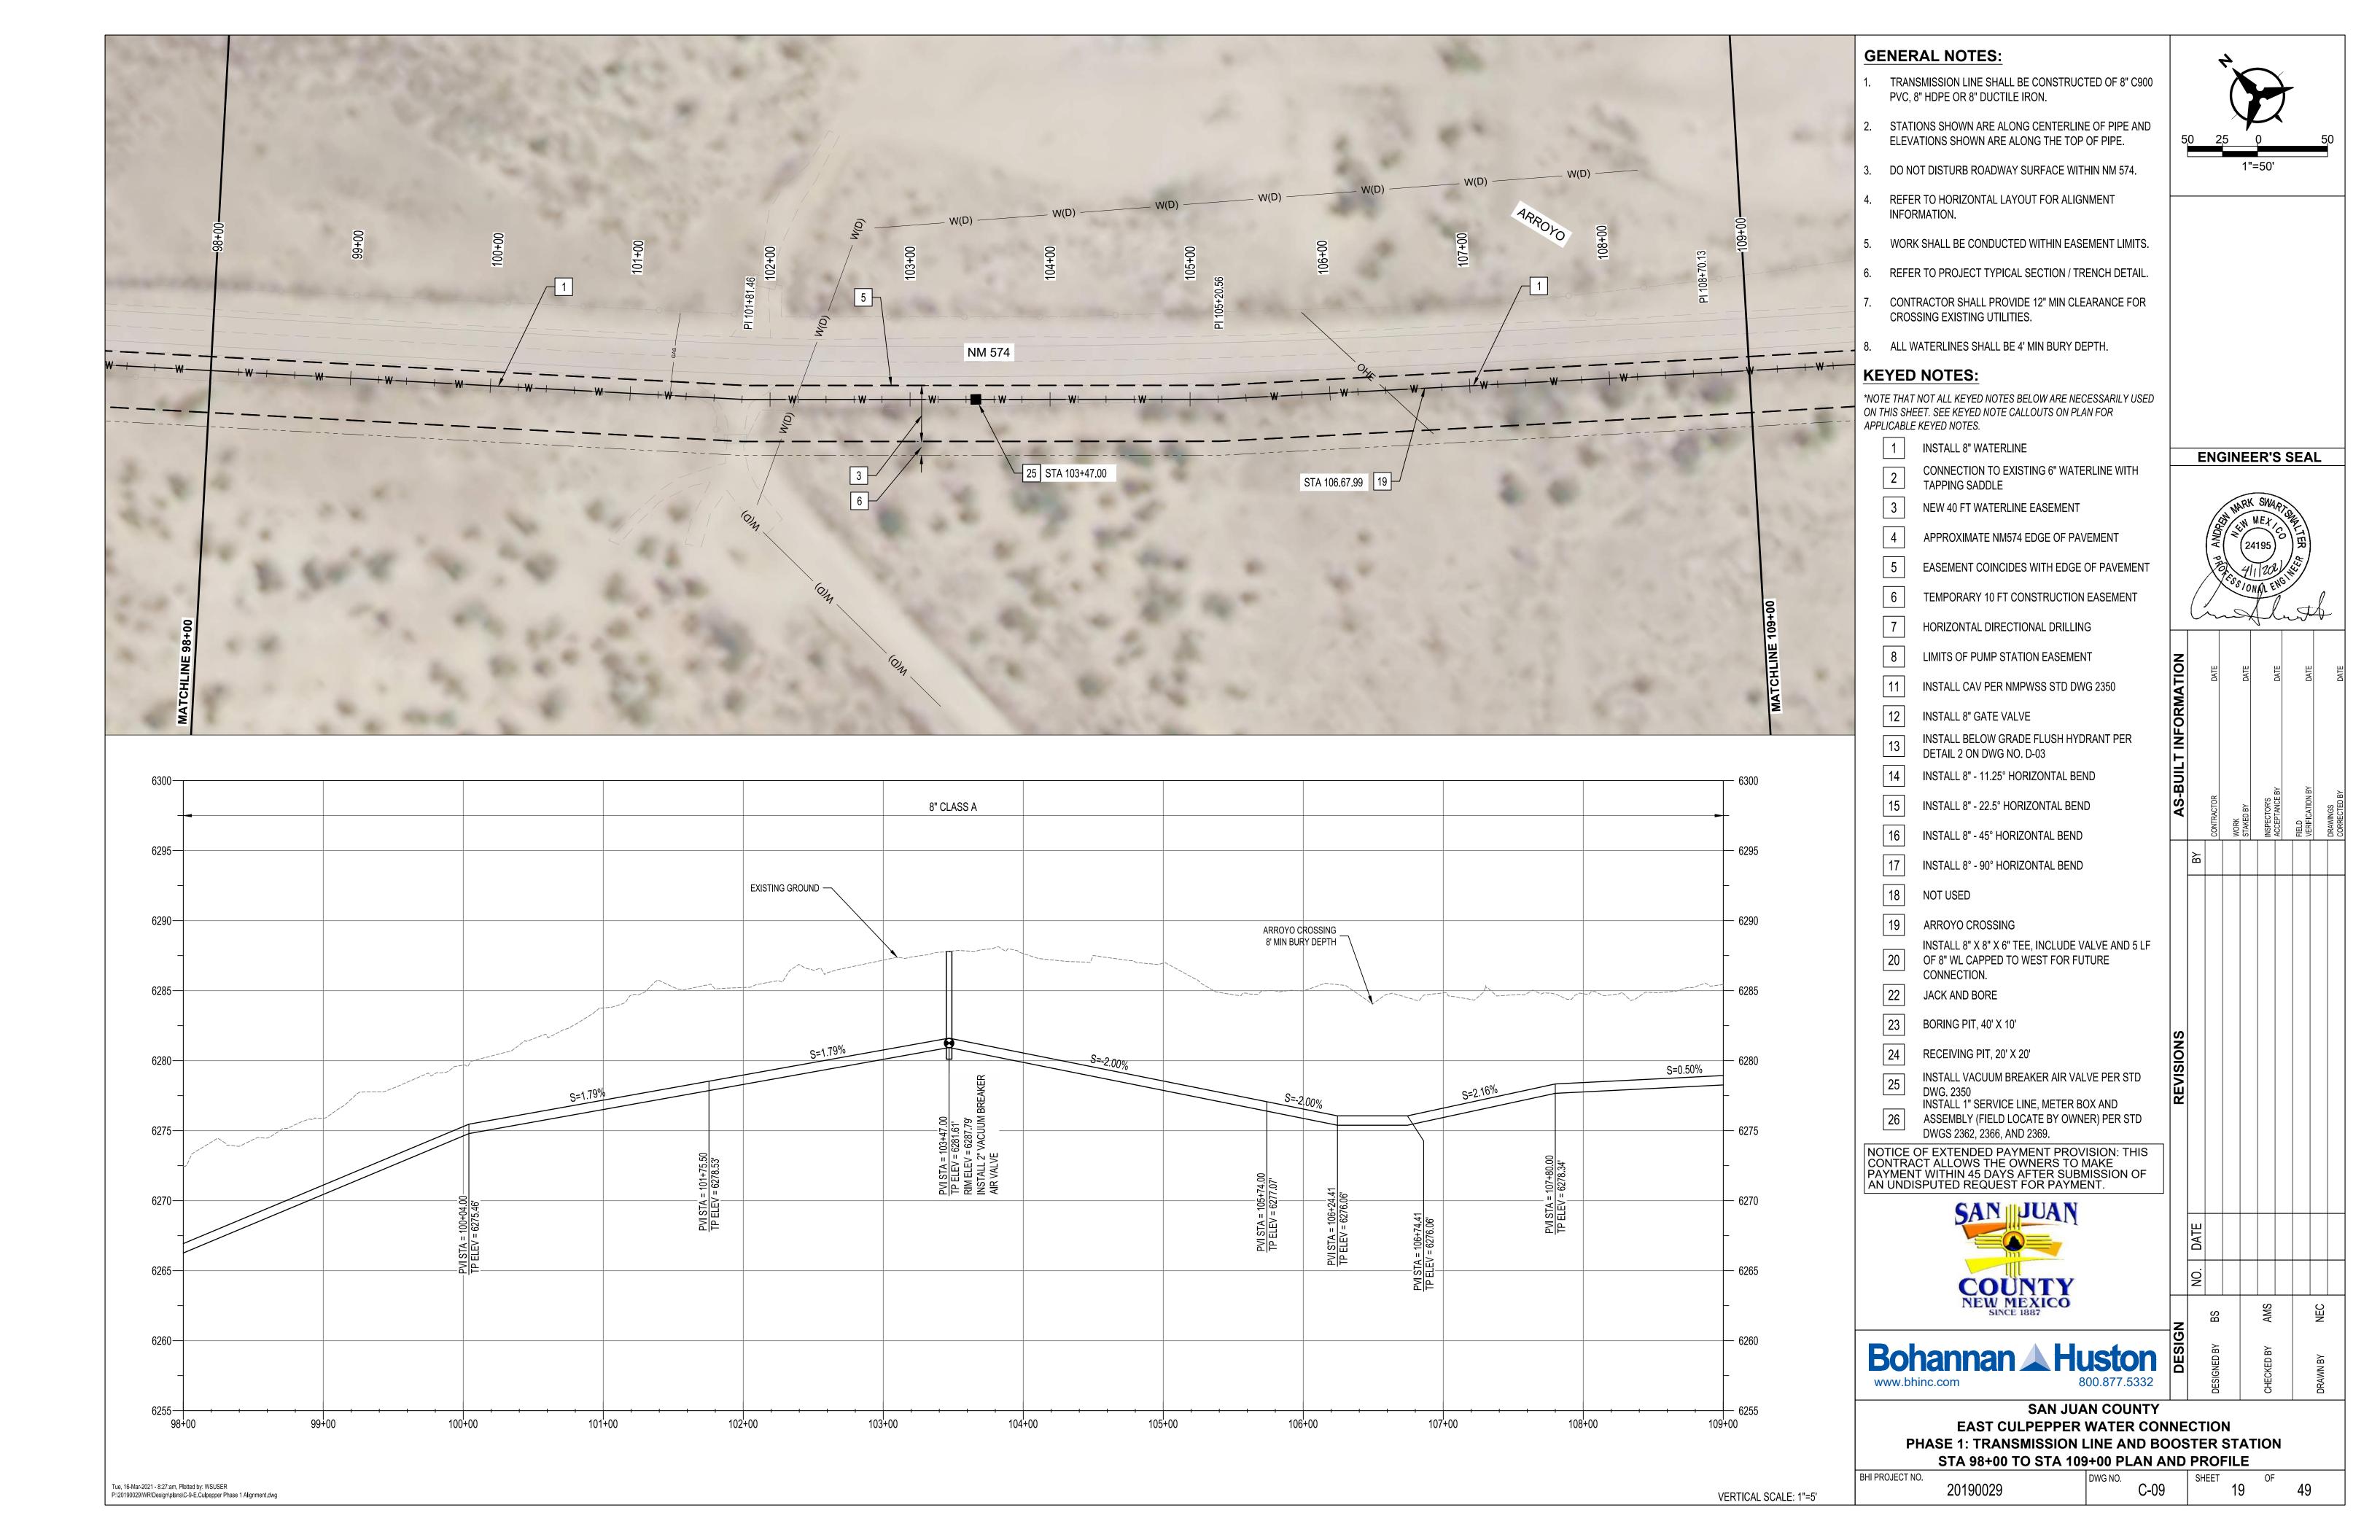

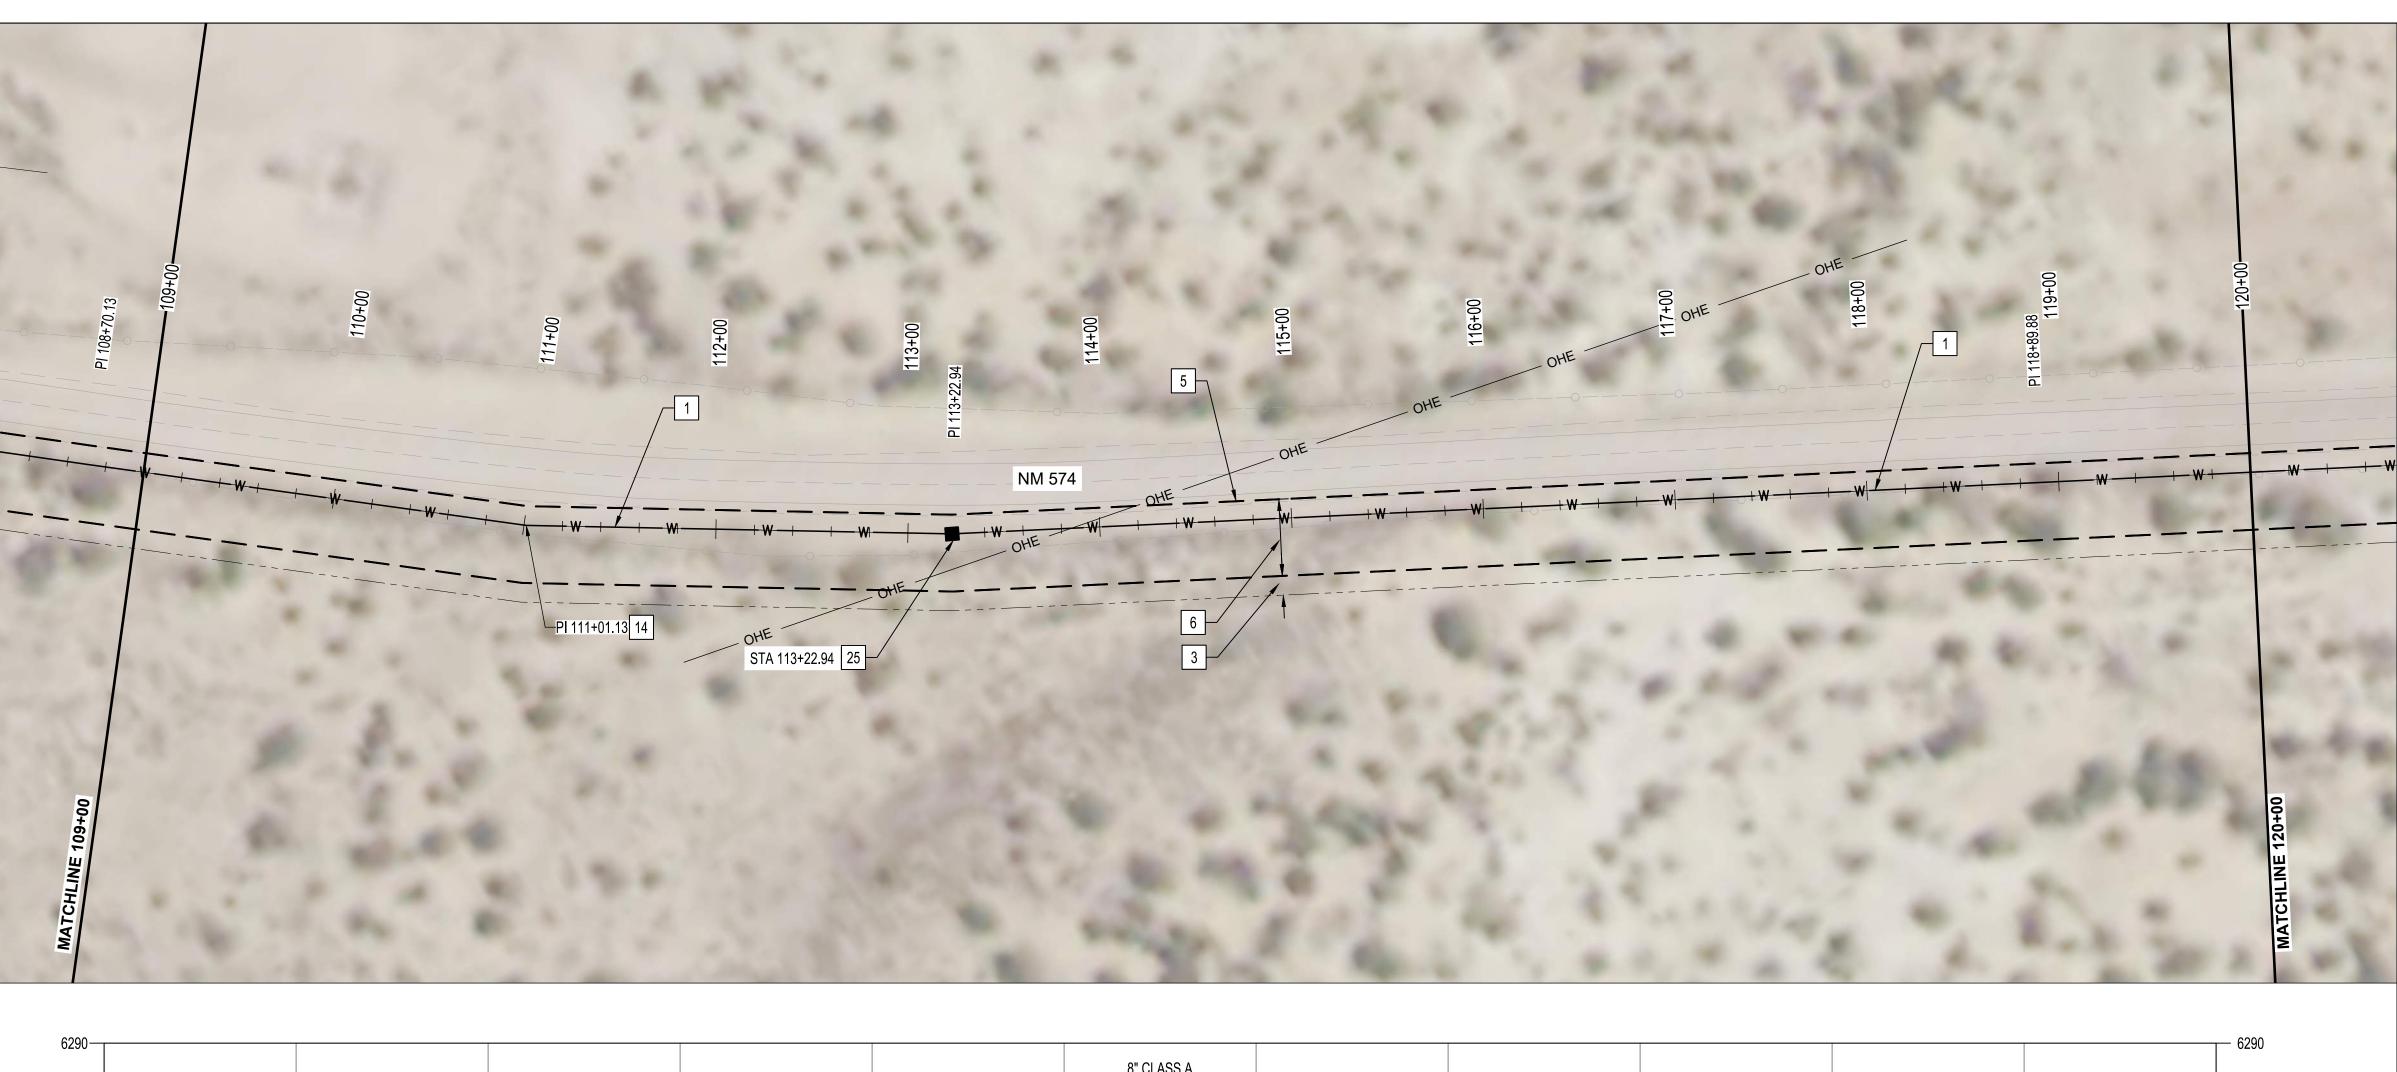

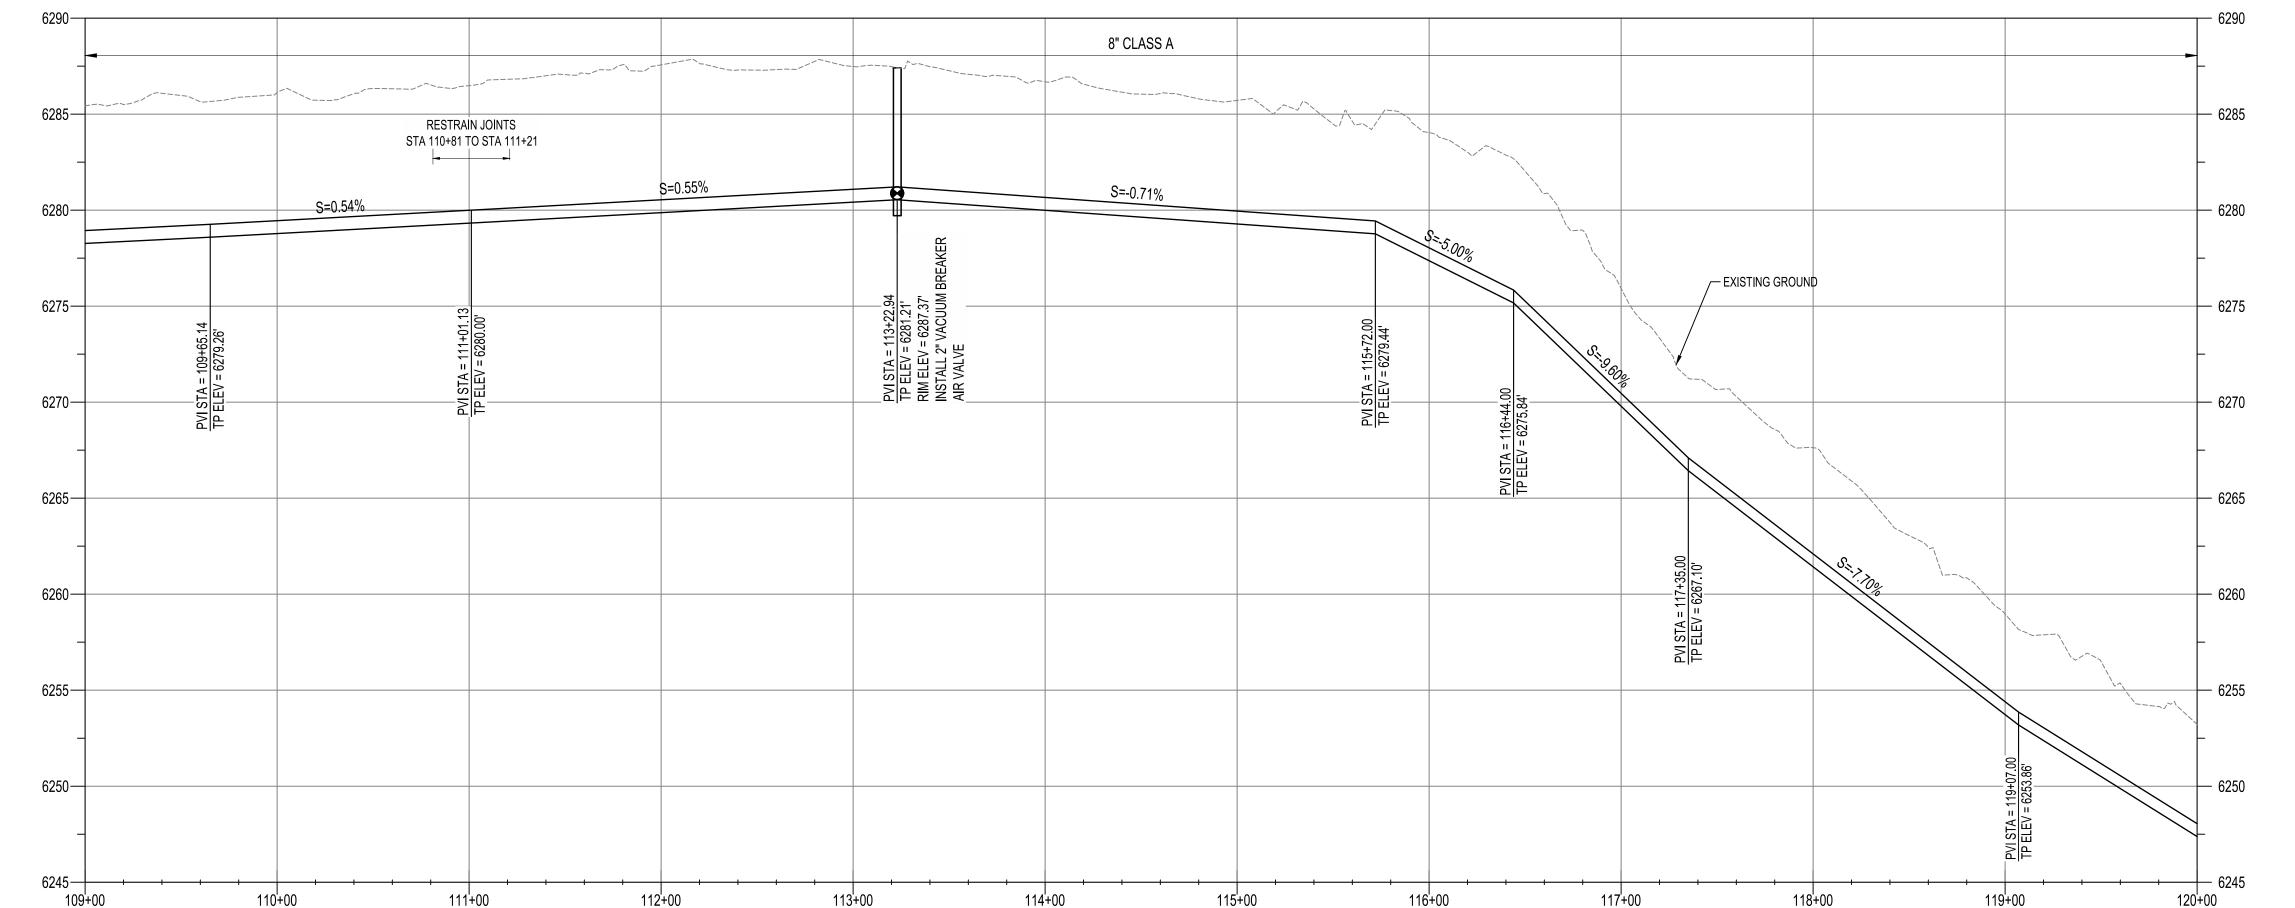

Tue, 16-Mar-2021 - 8:29:am, Plotted by: WSUSER

P:\20190029\WR\Design\plans\C-10-E.Culpepper Phase 1 Alignment.dwg

GENERAL NOTES:

- TRANSMISSION LINE SHALL BE CONSTRUCTED OF 8" C900 PVC, 8" HDPE OR 8" DUCTILE IRON.
 - STATIONS SHOWN ARE ALONG CENTERLINE OF PIPE AND
- ELEVATIONS SHOWN ARE ALONG THE TOP OF PIPE.

3. DO NOT DISTURB ROADWAY SURFACE WITHIN NM 574.

- 4. REFER TO HORIZONTAL LAYOUT FOR ALIGNMENT INFORMATION.
- 5. WORK SHALL BE CONDUCTED WITHIN EASEMENT LIMITS.
- 6. REFER TO PROJECT TYPICAL SECTION / TRENCH DETAIL.
- CONTRACTOR SHALL PROVIDE 12" MIN CLEARANCE FOR CROSSING EXISTING UTILITIES.
- 8. ALL WATERLINES SHALL BE 4' MIN BURY DEPTH.

KEYED NOTES:

*NOTE THAT NOT ALL KEYED NOTES BELOW ARE NECESSARILY USED ON THIS SHEET. SEE KEYED NOTE CALLOUTS ON PLAN FOR APPLICABLE KEYED NOTES.

- **INSTALL 8" WATERLINE**
- CONNECTION TO EXISTING 6" WATERLINE WITH TAPPING SADDLE

ENGINEER'S SEAL

- NEW 40 FT WATERLINE EASEMENT
- APPROXIMATE NM574 EDGE OF PAVEMENT
- EASEMENT COINCIDES WITH EDGE OF PAVEMENT
- TEMPORARY 10 FT CONSTRUCTION EASEMENT
- HORIZONTAL DIRECTIONAL DRILLING
- LIMITS OF PUMP STATION EASEMENT
- INSTALL CAV PER NMPWSS STD DWG 2350
- INSTALL 8" GATE VALVE
- INSTALL BELOW GRADE FLUSH HYDRANT PER

INSTALL 8" - 22.5° HORIZONTAL BEND

INSTALL 8° - 90° HORIZONTAL BEND

- DETAIL 2 ON DWG NO. D-03
- INSTALL 8" 11.25° HORIZONTAL BEND
- INSTALL 8" 45° HORIZONTAL BEND
- 18 NOT USED
- ARROYO CROSSING
- INSTALL 8" X 8" X 6" TEE, INCLUDE VALVE AND 5 LF OF 8" WL CAPPED TO WEST FOR FUTURE CONNECTION.
- JACK AND BORE
- 23 BORING PIT, 40' X 10'
- RECEIVING PIT, 20' X 20'

VERTICAL SCALE: 1"=5'

- INSTALL VACUUM BREAKER AIR VALVE PER STD DWG. 2350
- INSTALL 1" SERVICE LINE, METER BOX AND
- ASSEMBLY (FIELD LOCATE BY OWNER) PER STD DWGS 2362, 2366, AND 2369.


NOTICE OF EXTENDED PAYMENT PROVISION: THIS CONTRACT ALLOWS THE OWNERS TO MAKE PAYMENT WITHIN 45 DAYS AFTER SUBMISSION OF AN UNDISPUTED REQUEST FOR PAYMENT.








SAN JUAN COUNTY EAST CULPEPPER WATER CONNECTION PHASE 1: TRANSMISSION LINE AND BOOSTER STATION STA 109+00 TO STA 120+00 PLAN AND PROFILE


BHI PROJECT NO. 20190029

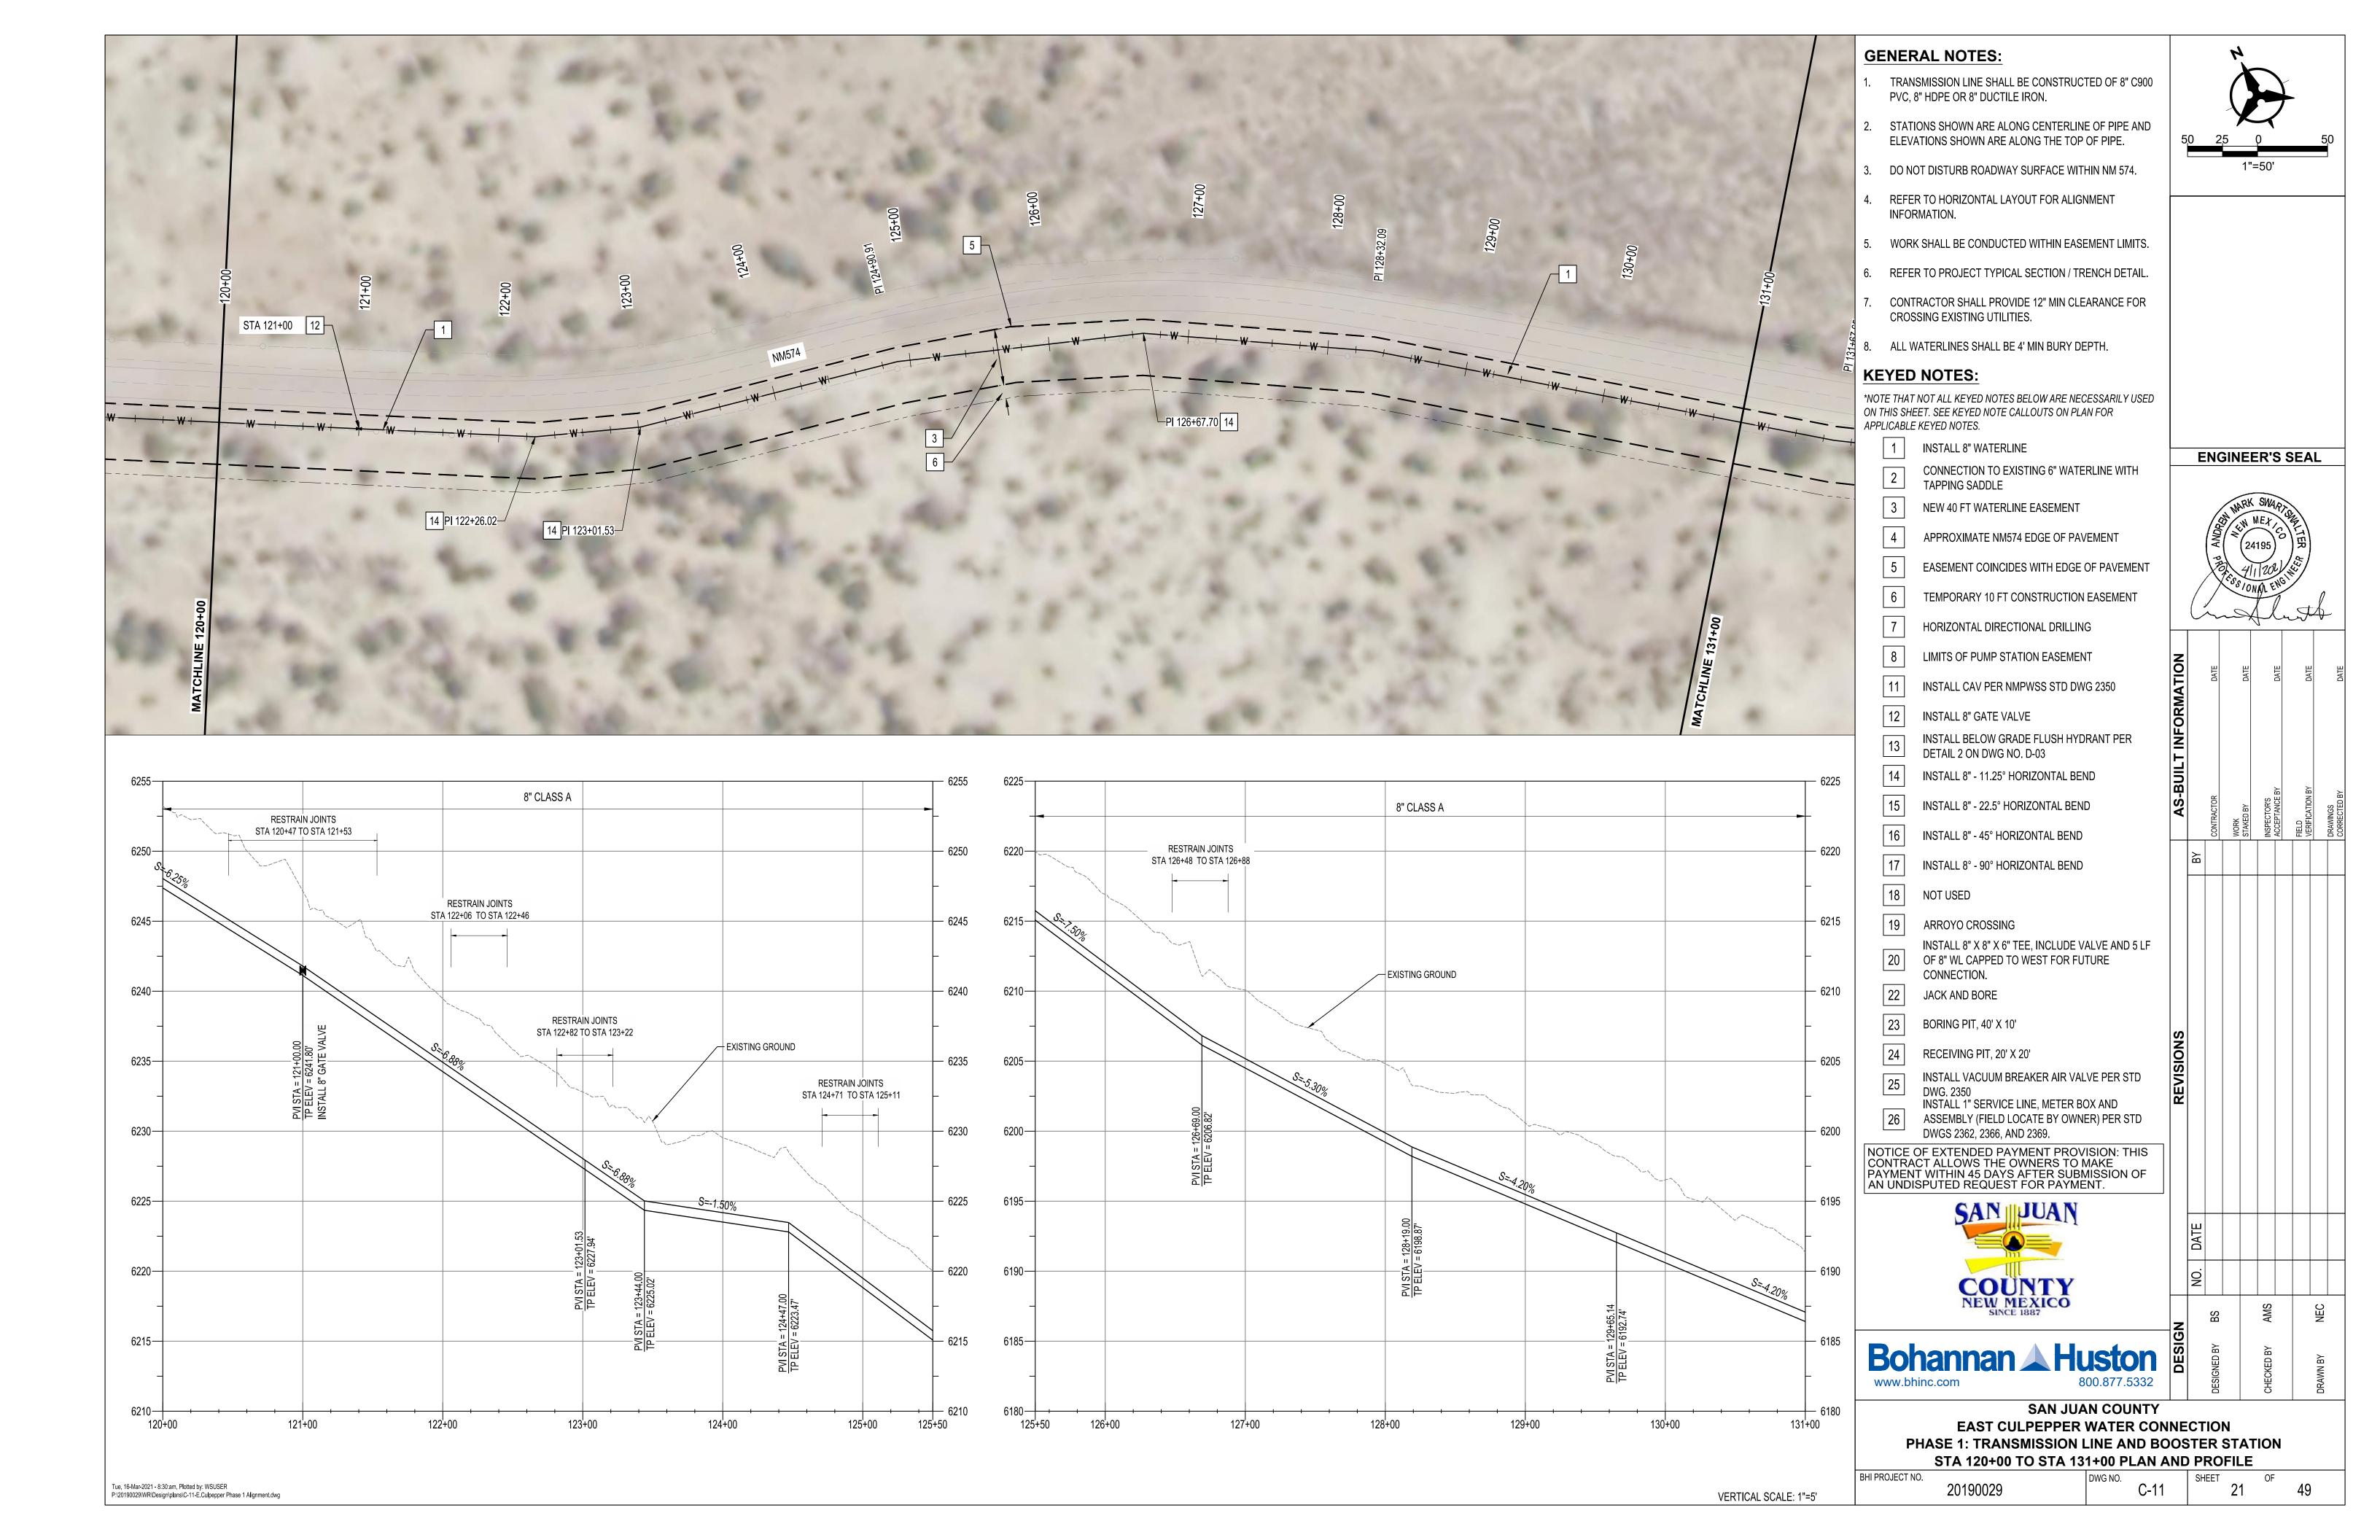


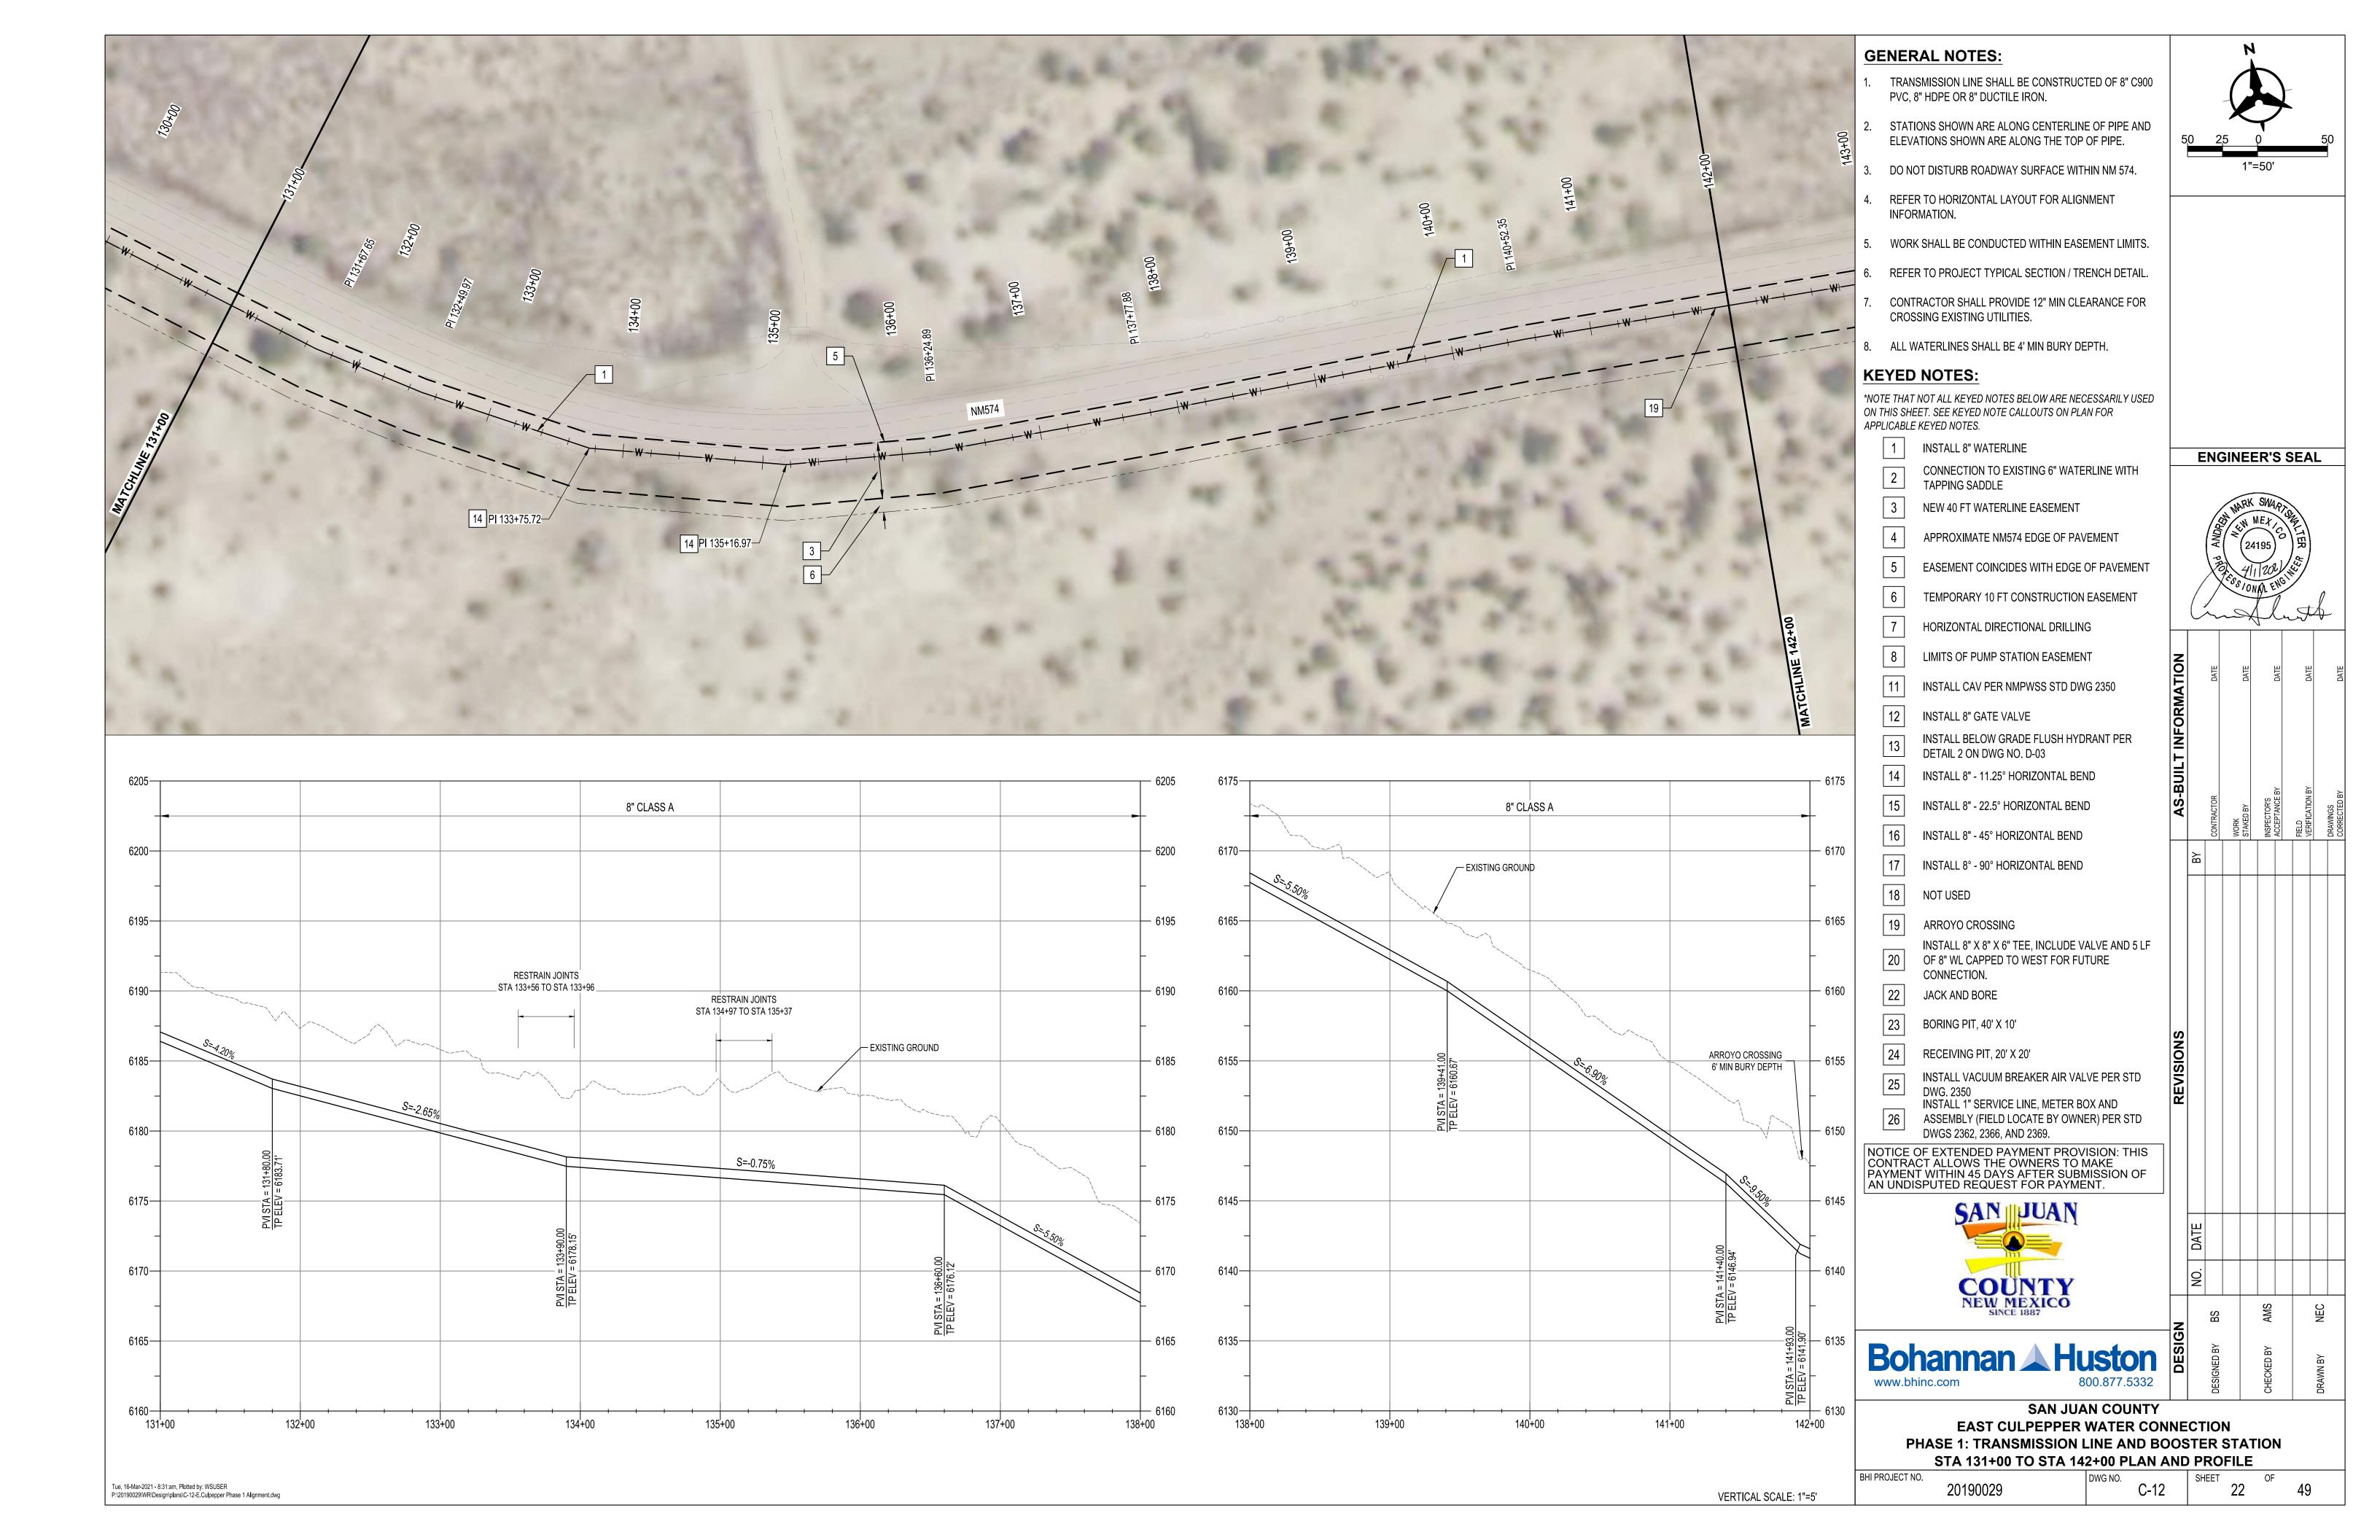

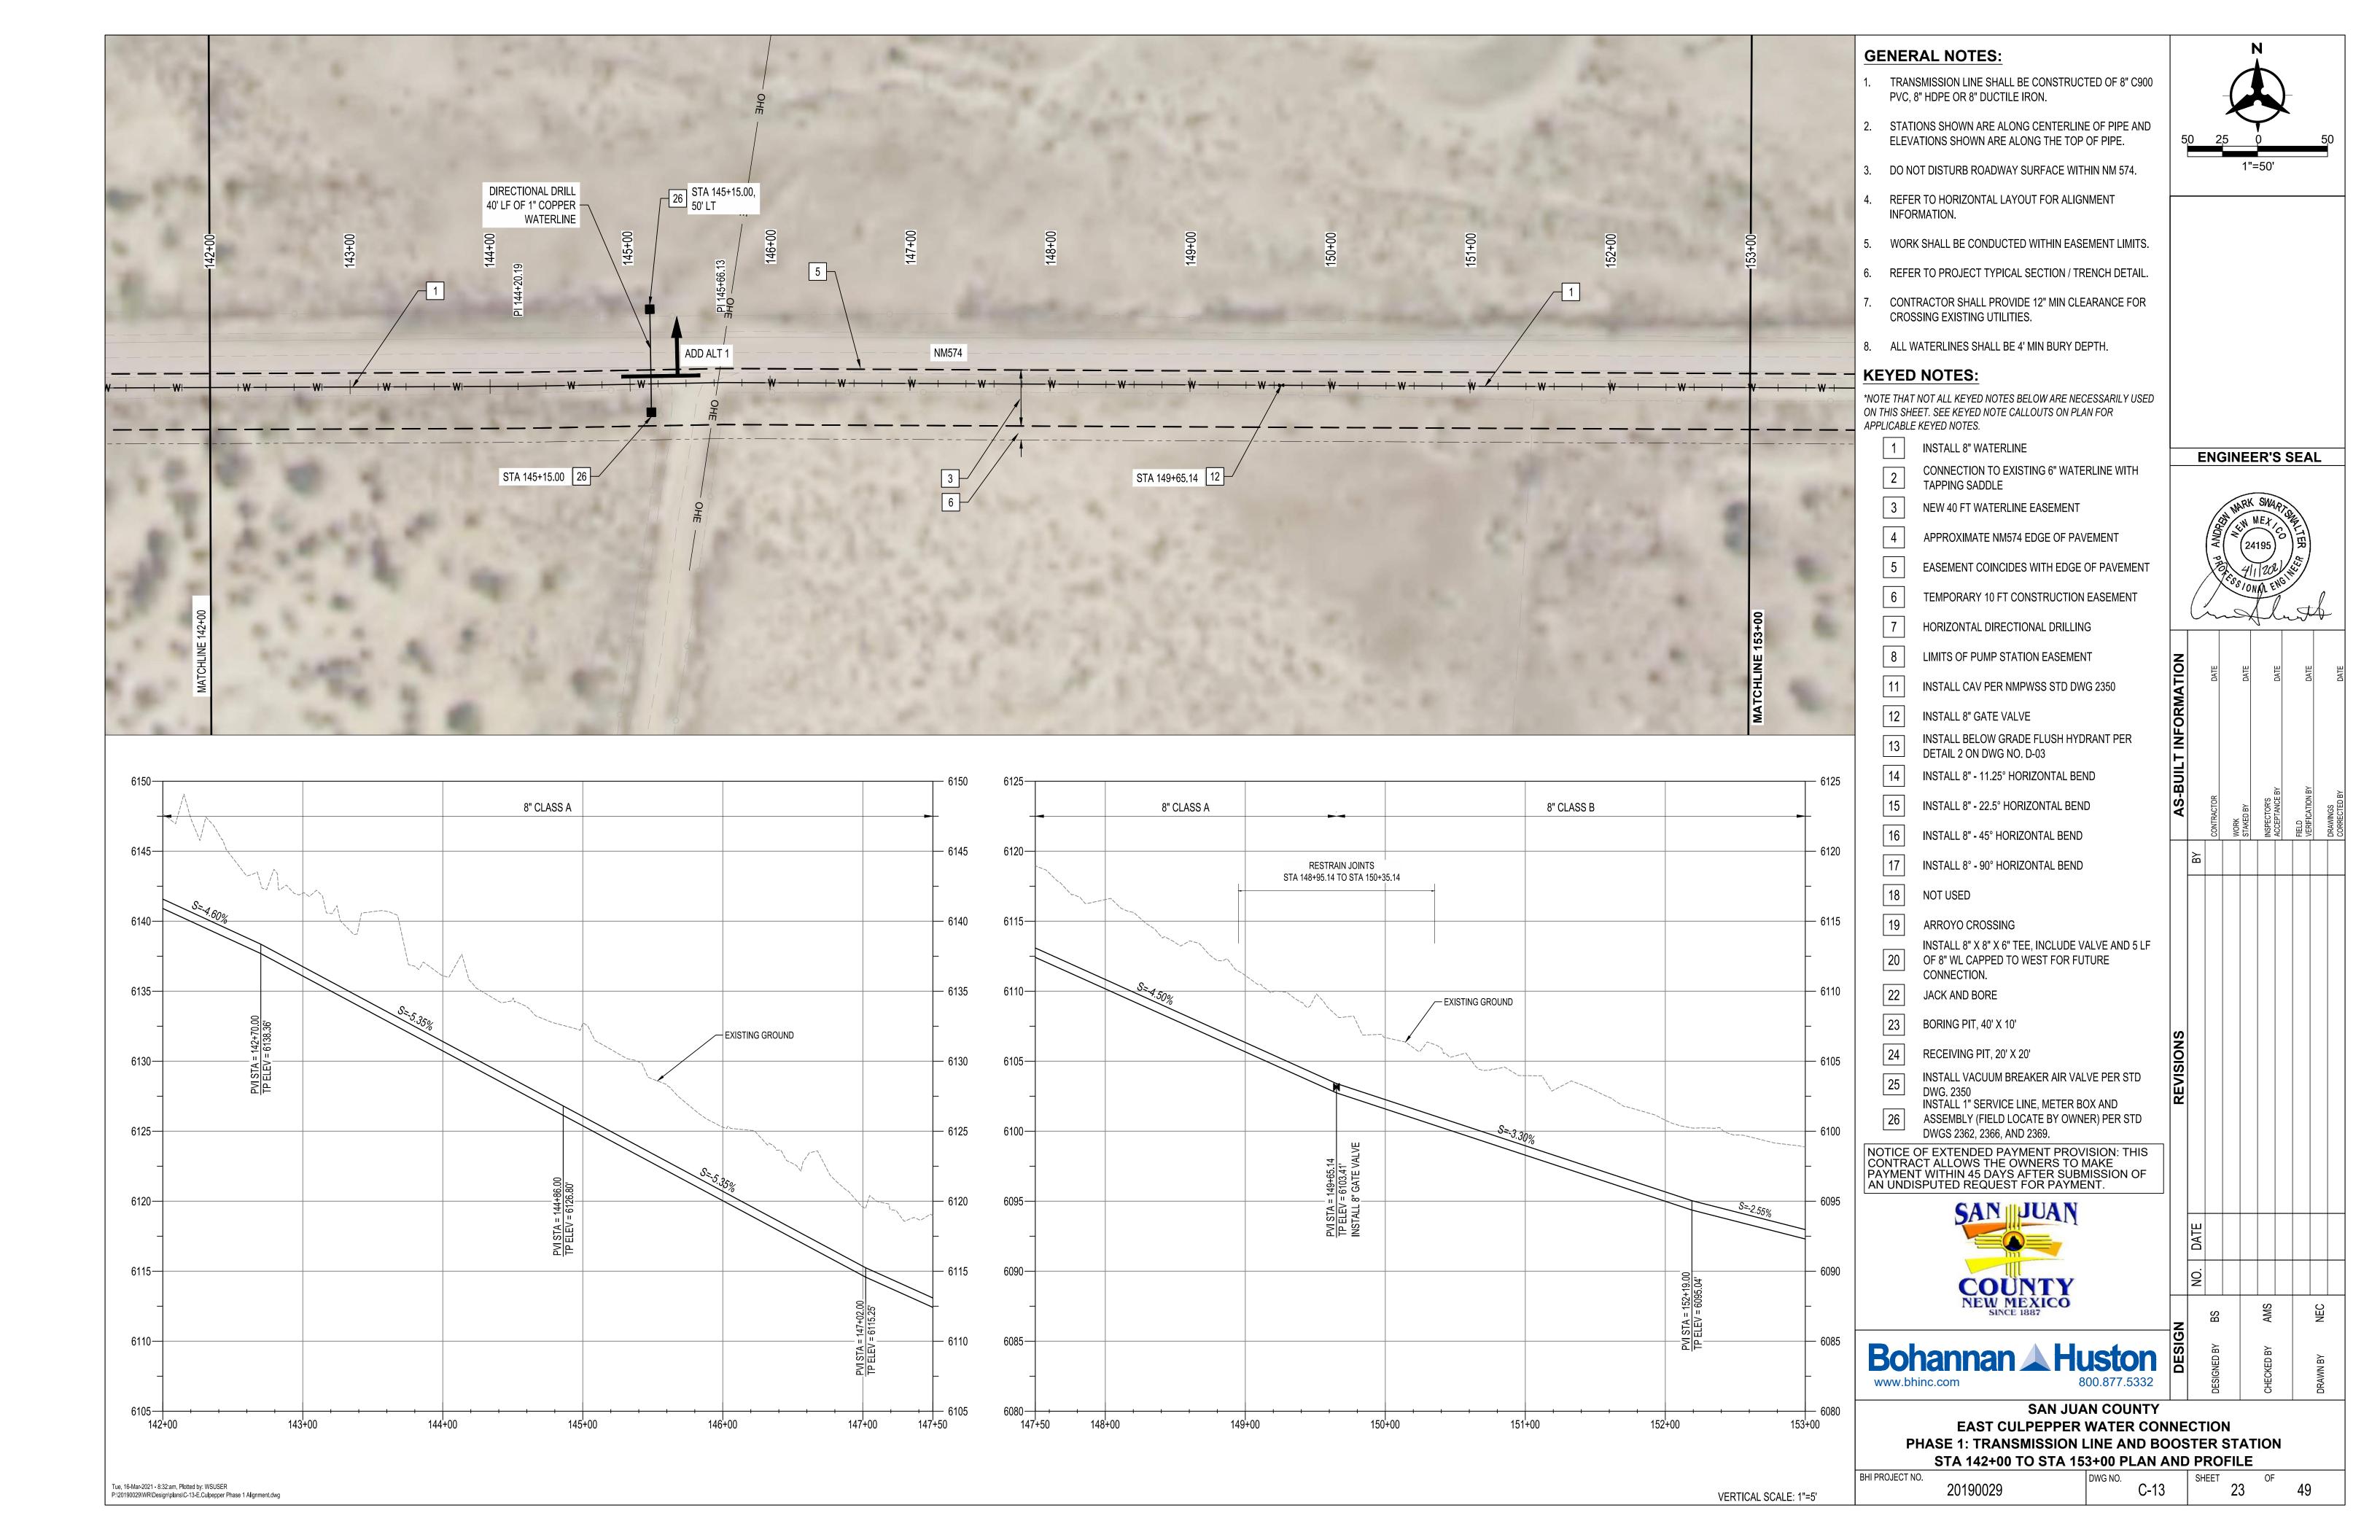

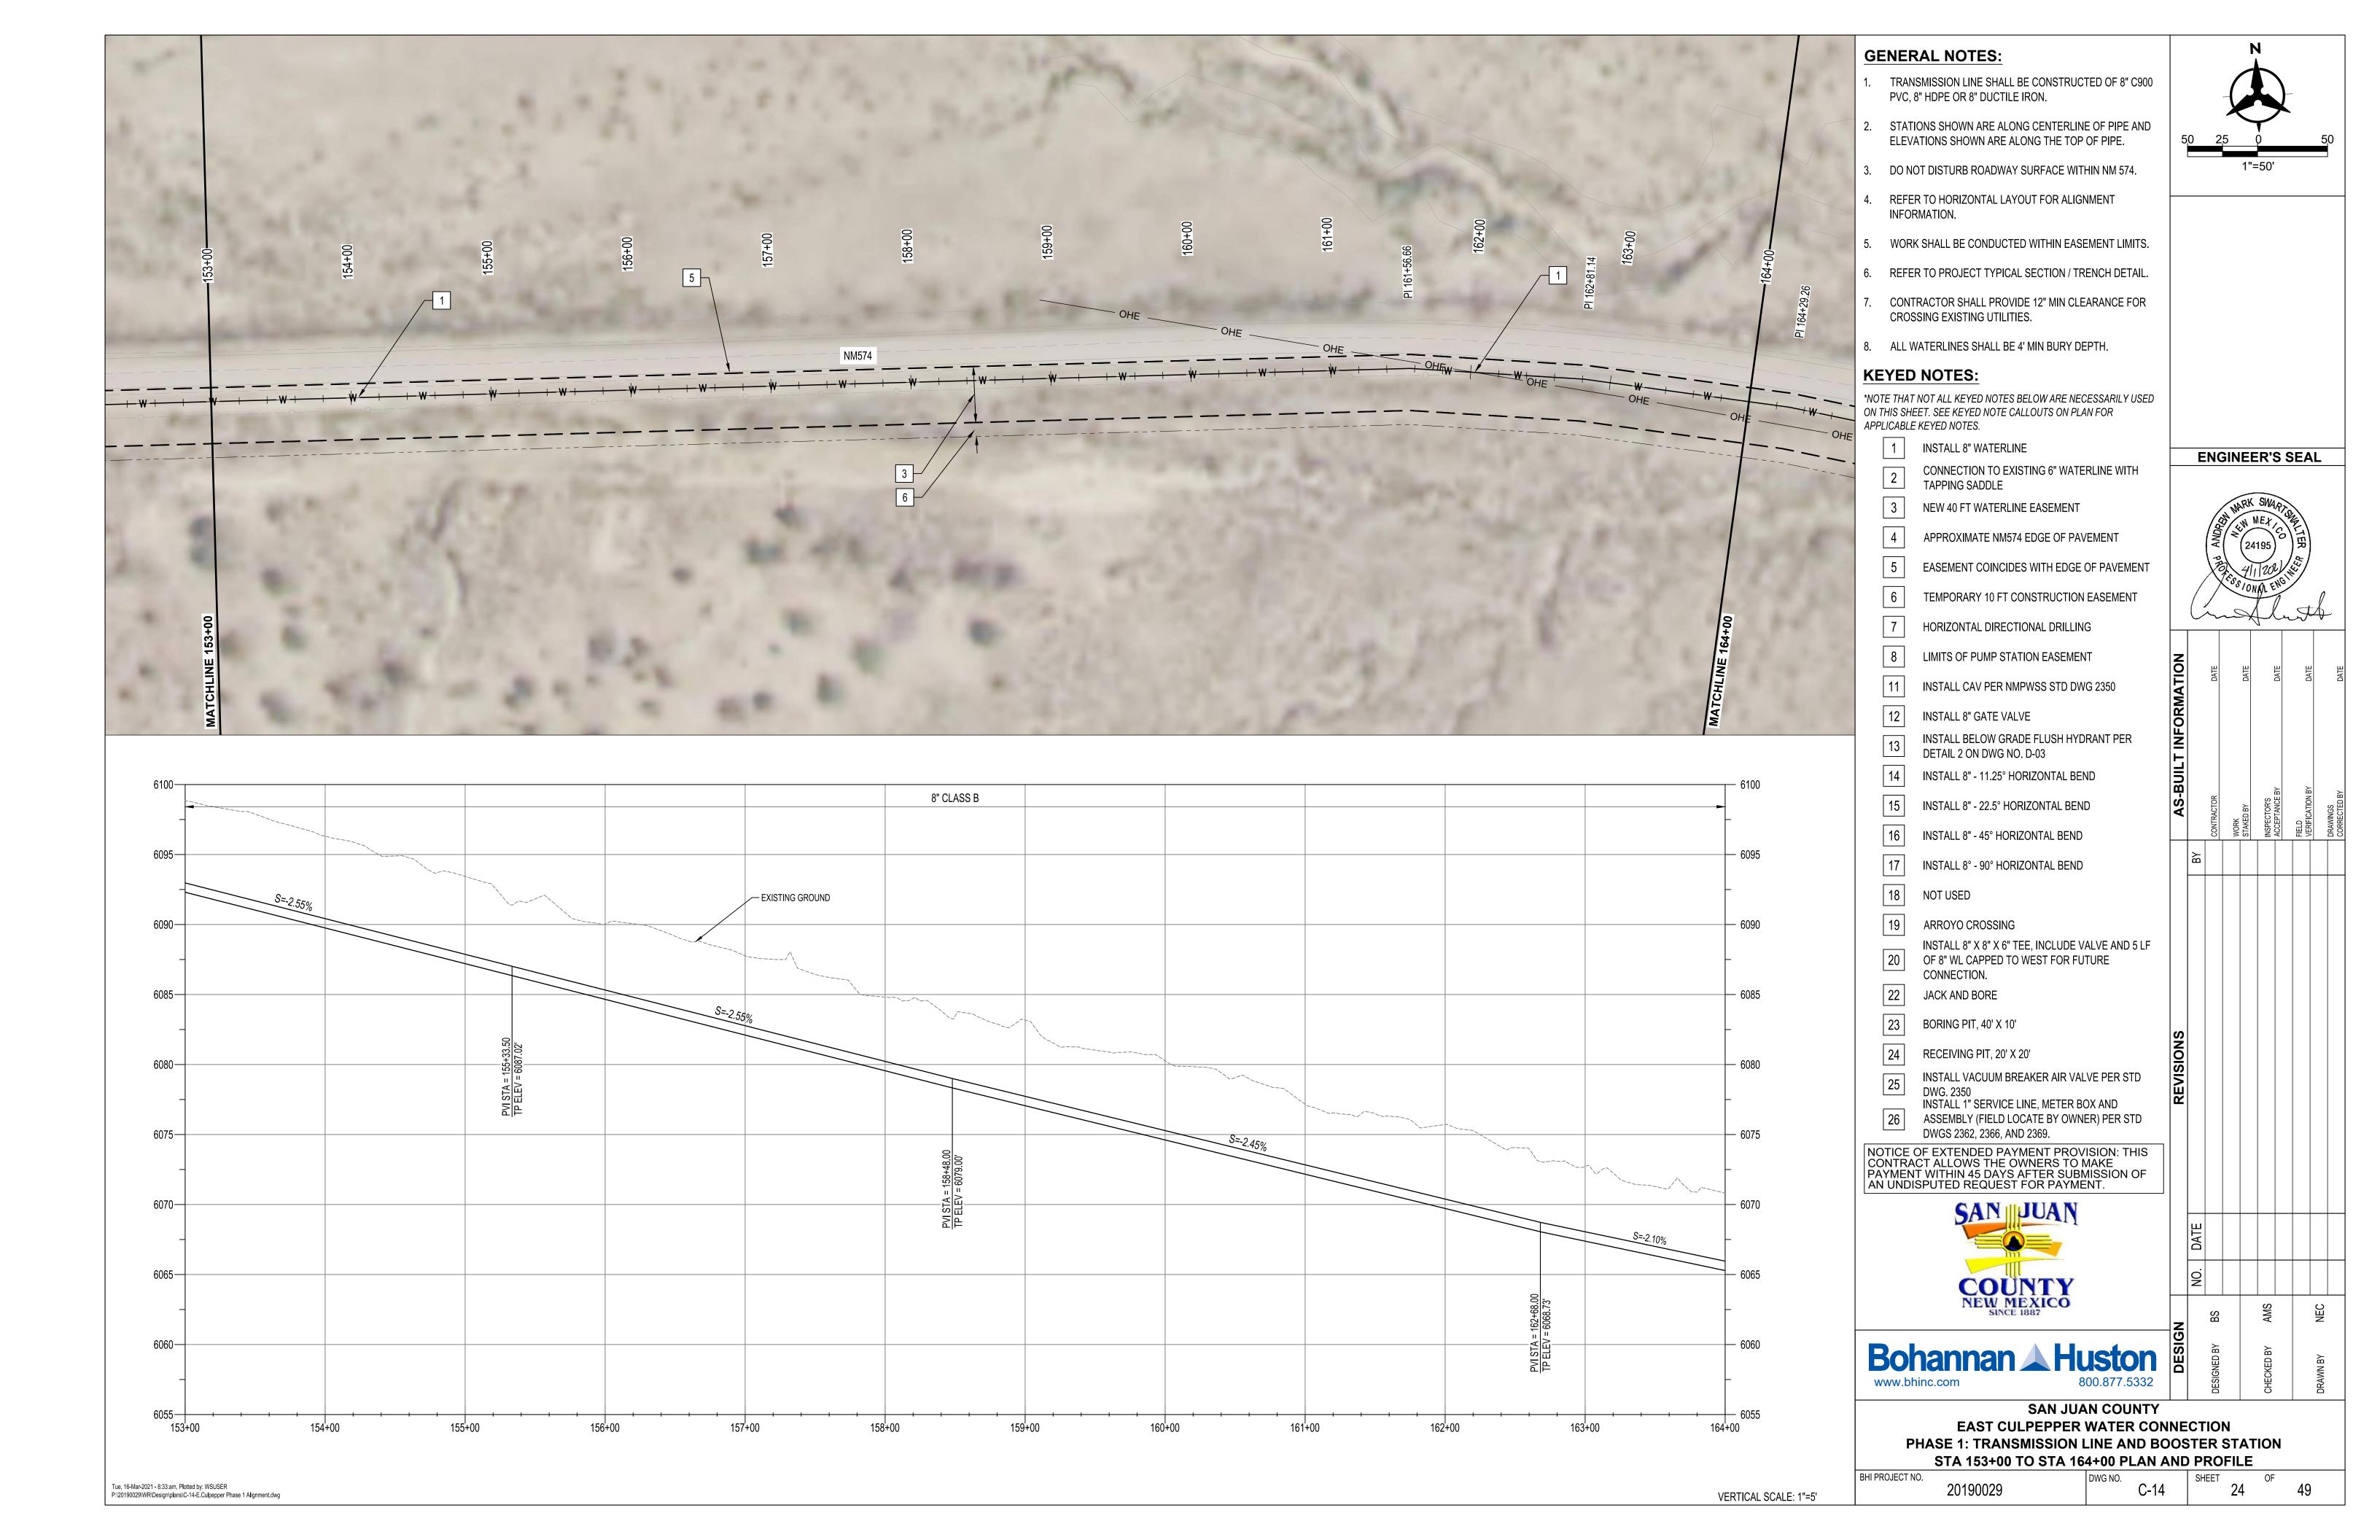

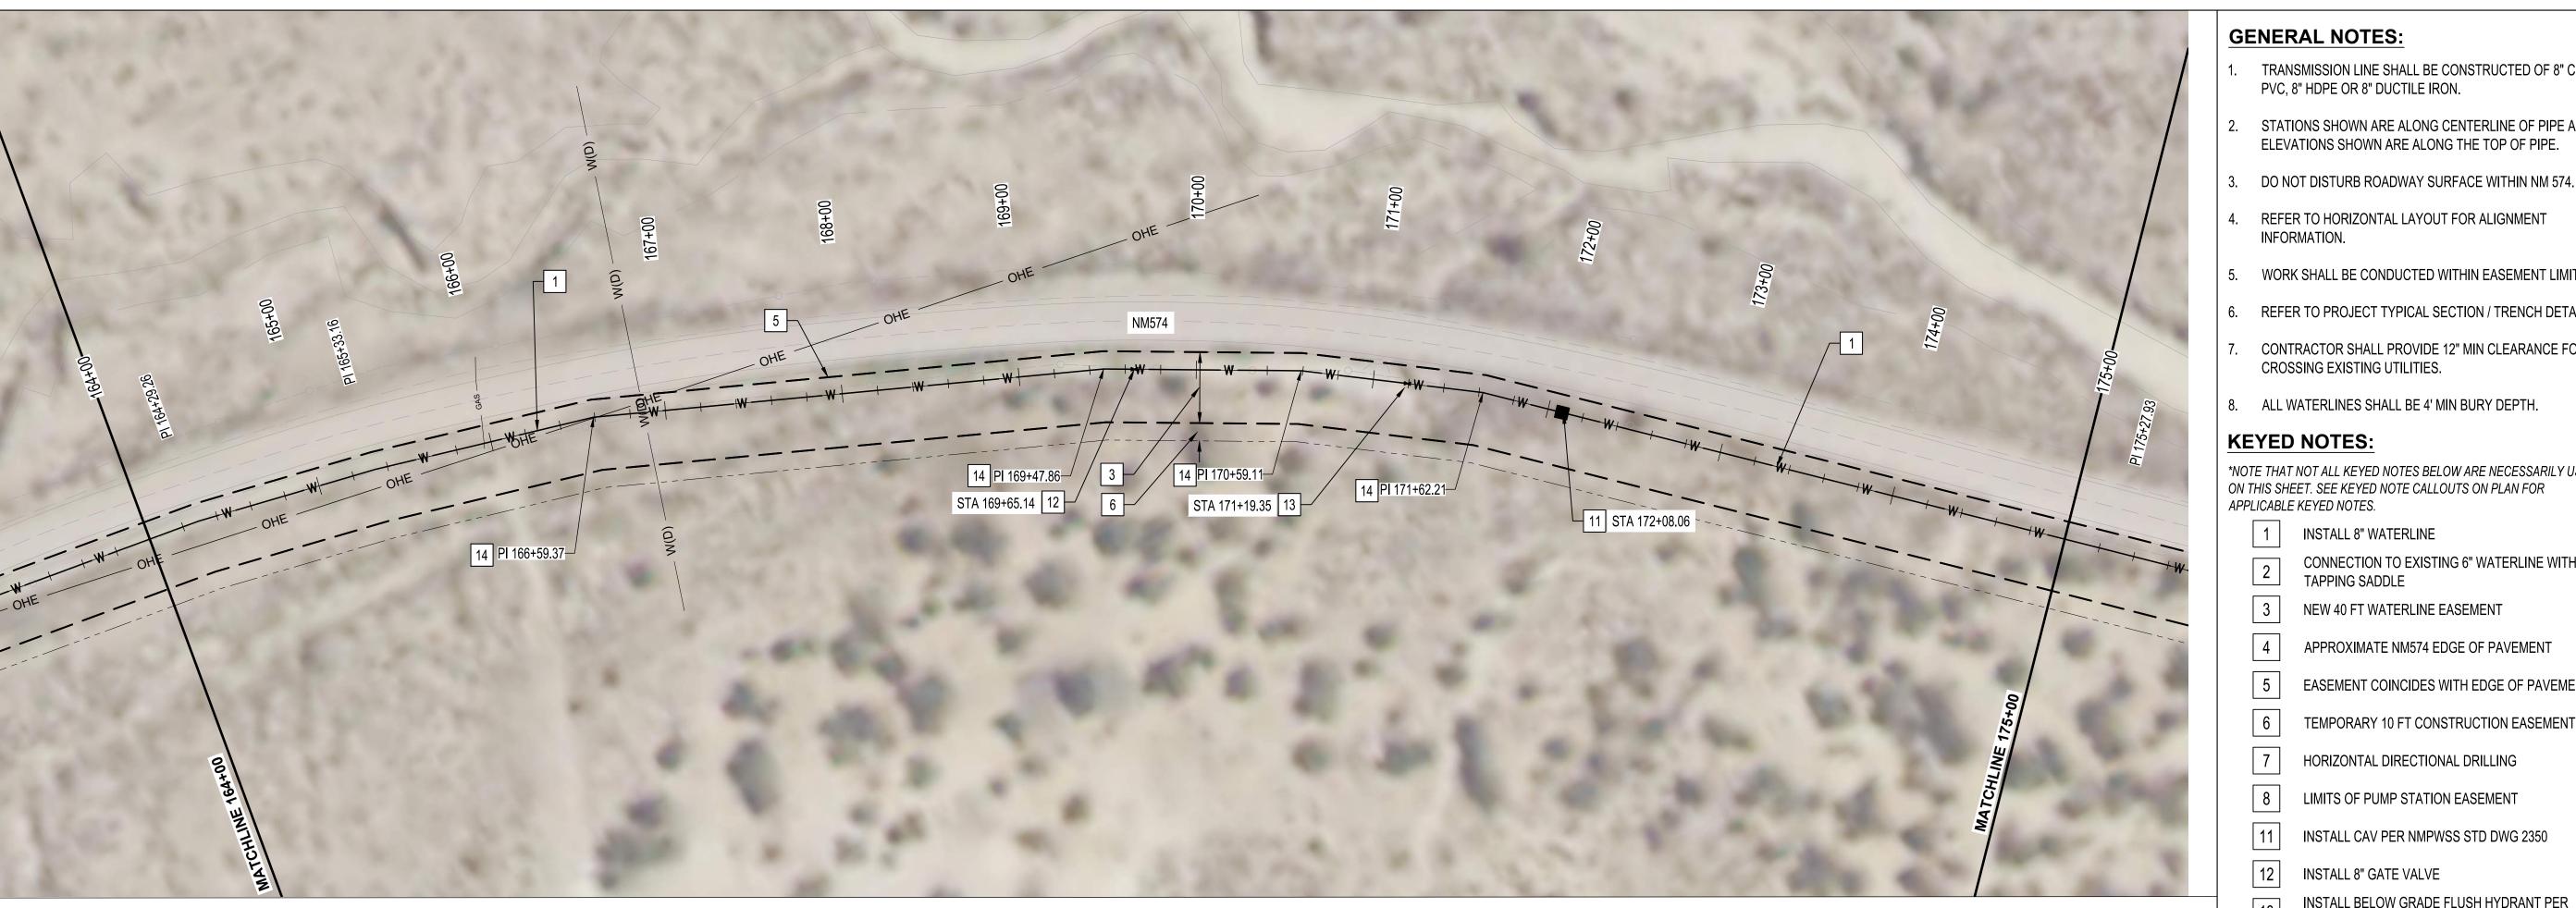

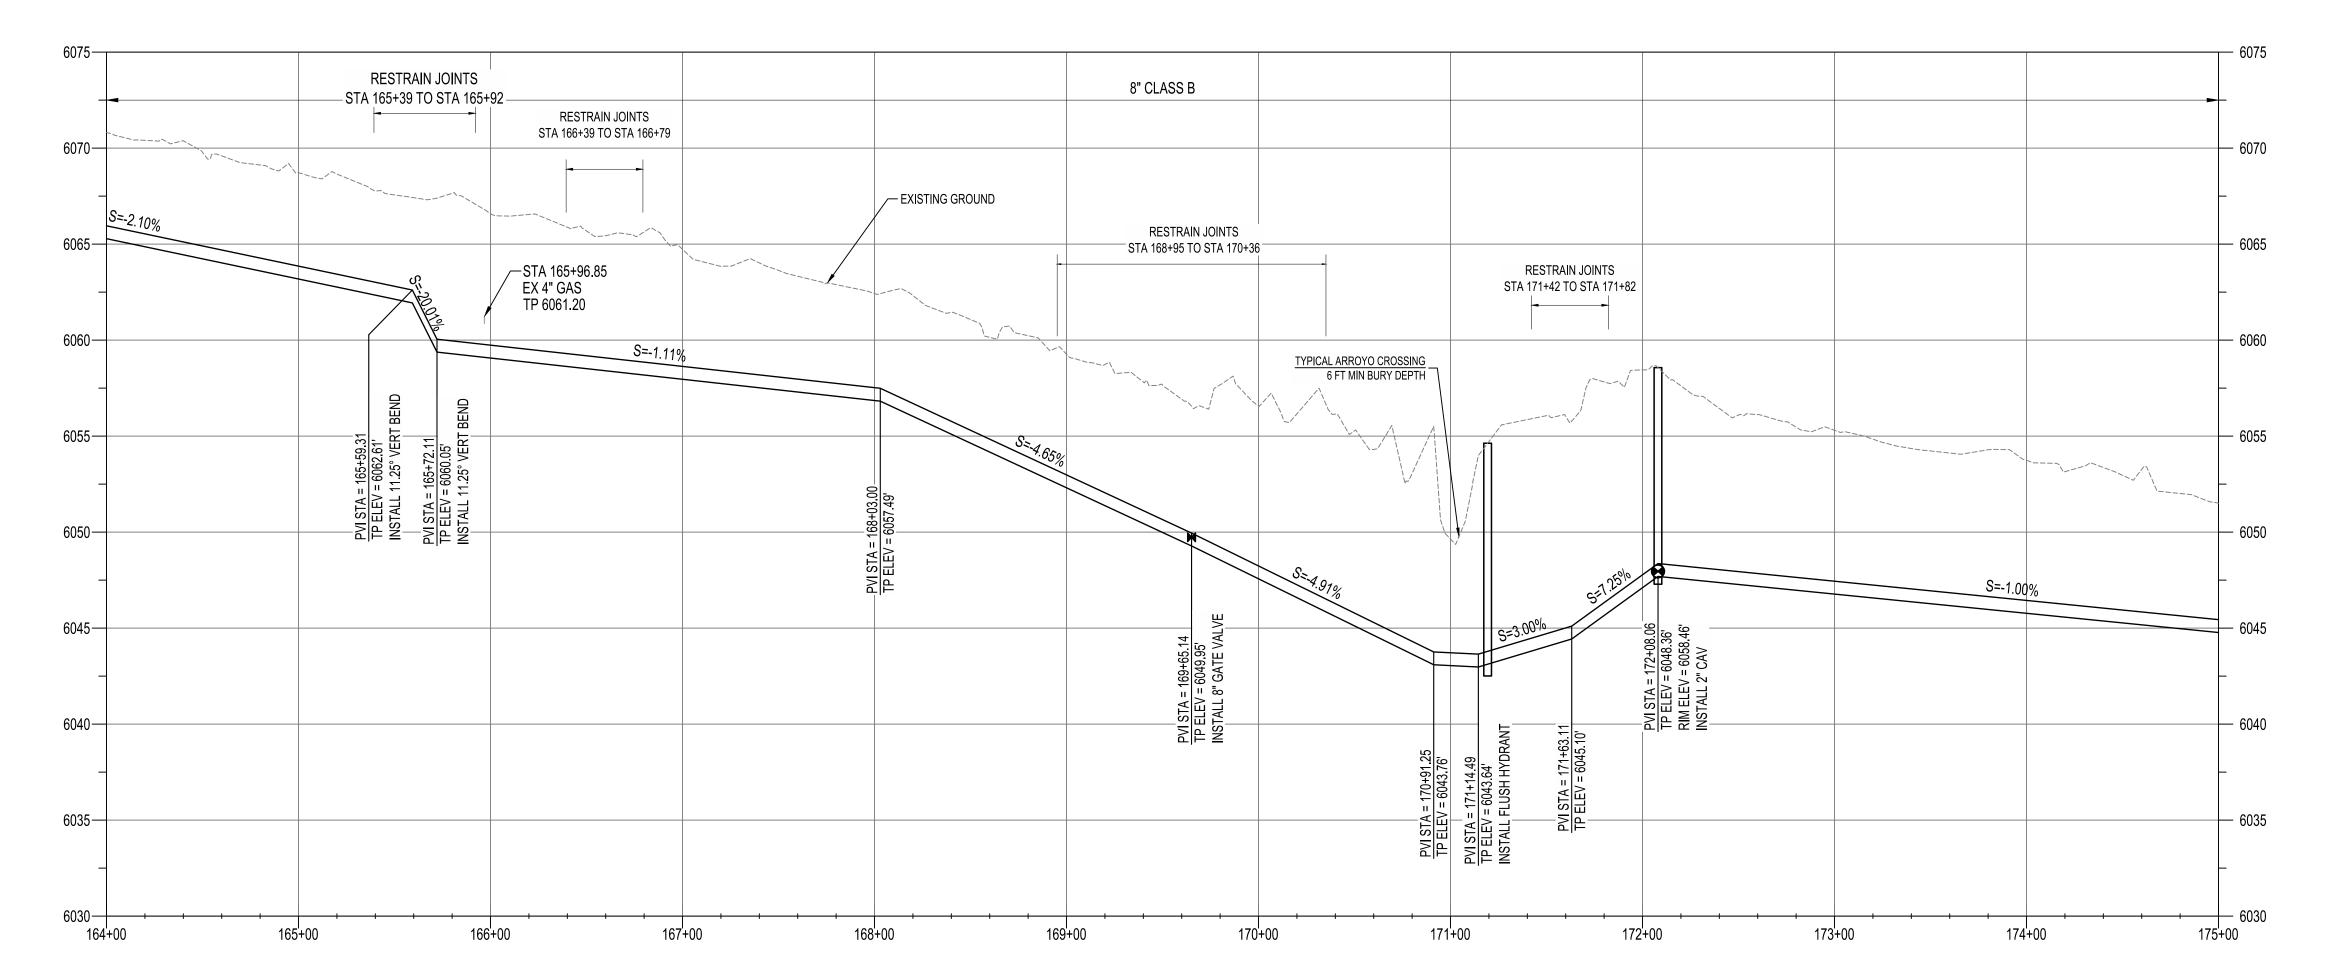

Tue, 16-Mar-2021 - 8:35:am, Plotted by: WSUSER

P:\20190029\WR\Design\plans\C-15-E.Culpepper Phase 1 Alignment.dwg

GENERAL NOTES:

- TRANSMISSION LINE SHALL BE CONSTRUCTED OF 8" C900 PVC, 8" HDPE OR 8" DUCTILE IRON.
 - STATIONS SHOWN ARE ALONG CENTERLINE OF PIPE AND
- ELEVATIONS SHOWN ARE ALONG THE TOP OF PIPE.
- REFER TO HORIZONTAL LAYOUT FOR ALIGNMENT INFORMATION.
- 5. WORK SHALL BE CONDUCTED WITHIN EASEMENT LIMITS.
- 6. REFER TO PROJECT TYPICAL SECTION / TRENCH DETAIL.
- CONTRACTOR SHALL PROVIDE 12" MIN CLEARANCE FOR CROSSING EXISTING UTILITIES.
- 8. ALL WATERLINES SHALL BE 4' MIN BURY DEPTH.

KEYED NOTES:

*NOTE THAT NOT ALL KEYED NOTES BELOW ARE NECESSARILY USED ON THIS SHEET. SEE KEYED NOTE CALLOUTS ON PLAN FOR APPLICABLE KEYED NOTES.

- **INSTALL 8" WATERLINE**
- CONNECTION TO EXISTING 6" WATERLINE WITH TAPPING SADDLE
- NEW 40 FT WATERLINE EASEMENT
- APPROXIMATE NM574 EDGE OF PAVEMENT
- EASEMENT COINCIDES WITH EDGE OF PAVEMENT
- TEMPORARY 10 FT CONSTRUCTION EASEMENT
- HORIZONTAL DIRECTIONAL DRILLING
- LIMITS OF PUMP STATION EASEMENT
- INSTALL CAV PER NMPWSS STD DWG 2350
- **INSTALL 8" GATE VALVE**
- INSTALL BELOW GRADE FLUSH HYDRANT PER
- DETAIL 2 ON DWG NO. D-03
- INSTALL 8" 11.25° HORIZONTAL BEND
- INSTALL 8" 22.5° HORIZONTAL BEND
- INSTALL 8" 45° HORIZONTAL BEND
- INSTALL 8° 90° HORIZONTAL BEND
- 18 NOT USED
- INSTALL 8" X 8" X 6" TEE, INCLUDE VALVE AND 5 LF OF 8" WL CAPPED TO WEST FOR FUTURE CONNECTION.
- JACK AND BORE
- 23 BORING PIT, 40' X 10'
- RECEIVING PIT, 20' X 20'
- INSTALL VACUUM BREAKER AIR VALVE PER STD DWG. 2350
- INSTALL 1" SERVICE LINE, METER BOX AND ASSEMBLY (FIELD LOCATE BY OWNER) PER STD
- DWGS 2362, 2366, AND 2369.

NOTICE OF EXTENDED PAYMENT PROVISION: THIS CONTRACT ALLOWS THE OWNERS TO MAKE PAYMENT WITHIN 45 DAYS AFTER SUBMISSION OF AN UNDISPUTED REQUEST FOR PAYMENT.





SAN JUAN COUNTY EAST CULPEPPER WATER CONNECTION PHASE 1: TRANSMISSION LINE AND BOOSTER STATION STA 164+00 TO STA 175+00 PLAN AND PROFILE

BHI PROJECT NO. 20190029

VERTICAL SCALE: 1"=5'

ENGINEER'S SEAL