SITE VICINITY MAP

INSIDE DIAMETER

INSULATION

INTERIOR

JOINT

JOIST

KITCHEN

LABORATORY

LAVATORY

MAXIMUM

MECHANICAL

MANUFACTURER

MISCELLANEOUS

MASONRY OPENING

NOT IN CONTRACT

OUTSIDE DIAMETER

NOT TO SCALE

ON CENTER

OVERHEAD

OPENING

OPPOSITE

PRE-CAST

PLASTER

PLYMOOD PAIR

RISER

QUARRY TILE

ROOF DRAIN

REINFORCED

SOLID CORE

SQUARE FOOT

SPRING POINT

SPECIFICATION

SEE STRUCTURAL DRAWINGS STAGGERED

SCHEDULE

SECTION

SHEET

SQUARE

STANDARD

STIFFENER

STRUCTURAL

SUSPENDED

TERRAZZO

TOP AND BOTTOM

TONGUE & GROOVE

UNLESS NOTED OTHERWISE

VINYL COMPOSTION TILE

TREAD

TOP OF TUBE STEEL

TYPICAL

VERTICAL

WATER CLOSET

CENTERLINE

MITH

MITHOUT

REFRIGERATOR

ROUGH OPENING

REFER TO .

REQUIRED

ROOM

PROPERTY LINE

PLASTIC LAMINATE

MEMBRANE

MANHOLE

MULLION

NORTH

INSUL. INT.

MAX.

MECH.

MEMB.

0.D.

PLAS.

REQ'D.

5Q. OR

STD.

STIFF

STRUC.

SUSP.

T & B

T & G

YCT

VER VERT.

ABBREVIATIONS

ANCHOR BOLT

AGGREGATE

ALUMINUM

BUILDING

BLOCKING

BOTTOM

BETWEEN

CEILING

CLEAR

CAULKING

CONCRETE

CONSTRUCTION

CENTER OF ARCH

DRINKING FOUNTAIN

CONTINUOUS

DEGREE

DIAGONAL

DOWNSPOUT

DIAMETER

DRAWING

EXISTING

EXPANSION JOINT

FINISH SYSTEM

ELEVATION ELECTRICAL

ELEVATION

EMERGENCY

ENCLOSURE

EQUIPMENT

EACH MAY

EXPANSION

EXTERIOR

FIRE ALARM

FOUNDATION

FINSH FLOOR

FLUORESCENT

FOUNDATION FACE OF BRICK

FULL SIZE FOOT OR FEET

FURRING

GAUGE

GRADE

GALVINIZED

GYPSUM BOARD

HOLLOW CORE

HANDICAPPED

HOLLOM METAL

AIR CONDITIONING

HEATING, VENTILATION AND

NOTE: Clarify with Architect any abbreviations not listed. Some abbreviations on list may not be used in project.

HARDWOOD

HORIZONTAL

HARDWARE

FLOW LINE FLOOR

FIRE EXTINGUISHER

FIRE HOSE CABINET

FACE OF CONCRETE

GENERAL CONTRACTOR

FLOOR DRAIN

EXTERIOR INSULATION AND

ELECTRIC WATER COOLER

FIRE DEPARTMENT CONNECTION

FIRE EXTINGUISHER CABINET

DETAIL

CONTROL JT.

BUILT UP ROOFING

CONCRETE MASONRY UNIT

BLOCK

APPROX

BLDG

B.U.R.

C.M.U. COL. CONC

DET./DTL.

EL./ELEV

EQUIP.

E.M.

E.M.C. EXP.

FDN.

F.E.C. F.F.

F.H.C.

F.O.B.

F.O.C.

FTG.

HDME.

HORIZ.

HVAC

H.M.

ALTERNATE

APPROXIMATE

ARCHITECTURAL

ACOUSTICAL CEILING TILE

ABOYE FINISHED FLOOR

PROJECT DATA

GENERAL NOTES:

APPLICABLE CODES:

2015 INTERNATIONAL BUILDING CODE

ICC/ANSI A117.1-2009 ACCESSIBILITY

2012 UNIFORM SOLAR ENERGY CODE

CONFLICTS BEFORE PROCEEDING WITH THE JOB.

MITHOUT MRITTEN AUTHORIZATION BY THE OWNER.

SHALL GOVERN SMALLER SCALE DRAWINGS.

CENTERLINE OF COLUMNS

FACE OF CONCRETE

FACE OF MASONRY

2021 UNIFORM MECHANICAL CODE

2021 UNIFORM PLUMBING CODE

2015 INTERNATIONAL FIRE CODE

2017 NATIONAL ELECTRIC CODE

2017 NM ELECTRICAL CODE

2017 NFPA 58

FOR FINAL PAYMENT.

DRAWINGS

2015 INTERNATIONAL RESIDENTIAL CODE

2015 INTERNATIONAL EXISTING BUILDING CODE

2021 NM PLUMBING AND MECHANICAL CODE

GENERAL REQUIREMENTS:

SHOWN ON DRAWINGS AT THE JOB SITE AND SHALL NOTIFY

SUBCONTRACTOR MUST COMPLY WITH ALL RULES AND

REGULATIONS OF AGENCIES HAVING JURISDICTION AND SHALL

SUBCONTRACTOR SHALL VERIFY ALL DIMENSIONS AND CONDITIONS

ARCHITECT/ENGINEER OF ANY DISCREPANCIES, OMISSIONS, AND/OR

B. ANY CHANGE WHICH RESULTS IN EXTRA COST SHALL NOT PROCEED

CONFORM TO ALL CITY, COUNTY, STATE AND FEDERAL CONSTRUCTION,

MORKMEN IN ACCORDANCE WITH THE BEST PRACTICES OF THE TRADES

INVOLVED. EACH TRADE WILL PROCEED IN A FASHION THAT WILL NOT

DELAY THE TRADES WORKING SIMULTANEOUSLY OR FOLLOWING THEM.

DEFECTS FOR A PERIOD OF AT LEAST ONE (1) YEAR FROM APPROVAL

. DO NOT SCALE DRAWINGS - DIMENSIONS GOVERN. LARGER SCALE

PROJECT LAYOUT REQUIREMENTS:

SAFETY, AND SANITARY LAWS, CODES, STATUTES AND ORDINANCES.

D. ALL WORK SHALL BE PERFORMED BY SKILLED AND QUALIFIED

. ALL WORK AND MATERIALS SHALL BE GUARANTEED AGAINST

B. DIMENSIONING IS AS FOLLOWS, UNLESS OTHERWISE NOTED

EXTERIOR FACE OF STUD AT EXTERIOR WALLS

FACE OF STUD AT INTERIOR STUD WALLS

2015 NM COMMERCIAL & RESIDENTIAL BUILDING CODE

2018 NEW MEXICO ENERGY CONSERVATION CODE / 2018 IECC

SITE AREA	190.48 ACRES
PARCEL NUMBER	2074188132132
GROSS FLOOR TOTAL	46,400 SF
MAIN FLOOR	35,900 SF
SECOND FLOOR	10,500 SF
OCCUPANCY GROUP:	B, F-2
CONSTRUCTION TYPE:	TYPE III-B

C. ALL FINISH FLOOR ELEVATIONS ARE TO TOP OF SLAB OR TOP

D. ALL STEPS SHALL HAVE 7" MAXIMUM RISERS AND 11" MINIMUM

TREADS U.N.O OR SPECIFIED DIFFERENTLY ON THE DRAWINGS.

E. ALL INTERIOR FEATURES SHOWN ARE CONCEPTUAL. VERIFY

IV. PROJECT WORKMANSHIP:

QUALITY IN EVERY RESPECT, UNLESS OTHERWISE NOTED.

EQUALITY BASED ON INFORMATION SUBMITTED BY THE

AND ARCHITECT AT CONSTRUCTION PHASE.

SQUARE, TRUE AND IN PROPER ALIGNMENT.

PATCHING REQUIRED FOR HIS WORK.

FREE OF ALL MATERIALS AND BROOM CLEAN.

TO THE INSTALLATION OF FLOORING OR CARPETING.

SHAPE, HEIGHT, AND DISTANCE OFF FINISH FLOOR WITH OWNER

A. ALL WORK SHALL BE ERECTED AND INSTALLED PLUMB, LEVEL,

B. ALL MATERIALS SHALL BE NEW, UNUSED AND OF THE HIGHEST

MANUFACTURED MATERIALS AND EQUIPMENT SHALL BE INSTALLED

PER MANUFACTURER'S RECOMMENDATIONS AND INSTRUCTIONS.

C. THERE SHALL BE NO SUBSTITUTION OF MATERIALS WHERE A

MANUFACTURER IS SPECIFIED. WHERE THE TERMS "EQUAL TO" OR

D. SUBCONTRACTOR SHALL BE RESPONSIBLE FOR CUTTING AND

E. SUBCONTRACTOR SHALL AT ALL TIMES KEEP THE PREMISES

PREMISES TO BE SMEPT CLEAN DAILY OF RELATED CONSTRUCTION

DEBRIS. AT THE COMPLETION OF THE WORK, LEAVE THE JOB SITE

F. PATCH ALL AREAS WHERE FLOOR IS NOT LEVEL OR TRUE PRIOR

FREE OF ACCUMULATION OF WASTE MATERIALS OR RUBBISH.

"APPROVED EQUAL" ARE USED, THE ARCHITECT SHALL DETERMINE

OF SHEATHING, U.N.O.

SAN JUAN COUNTY INDUSTRIAL PARK



ALTERNATES LIST:


REPLACE RTU WITH LARGER UNIT

REPLACE HIGH-BAY LIGHTING

AUTOMATIC DOOR OPENER

REPLACE WATER HEATERS

REPLACE RTU WITH DIFFERENT YOLTAGE UNIT

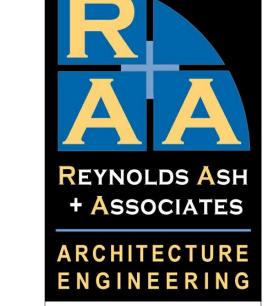

564 E. SECOND AVE, STE 201 DURANGO, CO 81301 (970) 259 - 7494 FAX (970) 259 - 7492 262 PAGOSA STREET, STE, 200 PAGOSA SPRINGS, CO 81147 RA-AE.COM

EXPRESSLY RESERVES THE COMMON LAW COPYRIGH AND OTHER PROPERTY RIGHTS IN THESE PLANS. THES
PLANS ARE NOT TO BE CHANGED OR COPIED IN ANY THE ARCHITECT OF RECORD.

THEY WERE PREPARED AND PUBLICATION TEHREOF IS PROHIBITS THE REPRODUCTION DISPLAY SALE OR EXPRESS WRITTEN CONSENT OF RA+A ARCHITECTS, P.C.



FIRST FLOOR REFLECTED CEILING PLAN UPPER FLOOR REFLECTED CEILING PLAN PLUMBING LEGEND NOTES AND DETAILS MECHANICAL LEGEND NOTES AND DETAILS ELECTRICAL LIGHTING DEMOLITION PLAN - 1ST FLOOR ELECTRICAL LIGHTING DEMOLITION PLAN - 2ND FLOOR ELECTRICAL LIGHTING PLAN - 1ST FLOOR ELECTRICAL LIGHTING PLAN - 2ND FLOOR ELECTRICAL CONNECTIONS PLAN - 1ST FLOOR ELECTRICAL CONNECTIONS PLAN - 2ND FLOOR ELECTRICAL LEGEND NOTES AND DETAILS

DRAWINGS INDEX:

SITE PLAN- OVERALL

EXTERIOR ELEVATIONS

EXTERIOR ELEVATIONS

INTERIOR ELEVATIONS

PLUMBING SITE PLAN

ELECTRICAL SITE PLAN

UPPER LEVEL FLOOR PLAN

DOOR & WINDOW SCHEDULES

PLUMBING PLAN 1ST FLOOR

PLUMBING PLAN 2ND FLOOR

MECHANICAL PLAN 1ST FLOOR

MECHANICAL PLAN 2ND FLOOR

MAIN FLOOR PLAN

COVER SHEET

CODE PLAN

ROOF PLAN

A-103

EL102

CENTER OF WINDOW AND DOOR OPENINGS ARCHITECTURAL SYMBOLS


SIM A101	SECTION: SECTION NUMBER SHEET NUMBER	A-101	EXTERIOR ELEVATION: SHEET NUMBER ELEVATION NUMBER	
1 A101 SIM	DETAIL: DETAIL NUMBER SHEET NUMBER	/	INTERIOR ELEVATION: SHEET NUMBER	
001	DOOR DESIGNATION	\ /	ELEVATION NUMBER	
⟨ A ⟩	MINDOM DESIGNATION	12 X	ROOF SLOPE INDICATION	
0	COLUMN GRID	Name Elevation	ELEVATION TAG	
ę.	COLUMN LINE CENTER LINE		NORTH ARROW	
4' -	7"	STEP	CHANGE IN ELEVATION	
		I LINE TO WALL OR OTHER	STOREFRONT TAG	

JOB. NO.: 2023-05-15 DRAWN BY: RA+A

ISSUE RECORD: 2023-02-17 100% SD 2023-05-15 CD

REVISIONS:


COVER SHEET

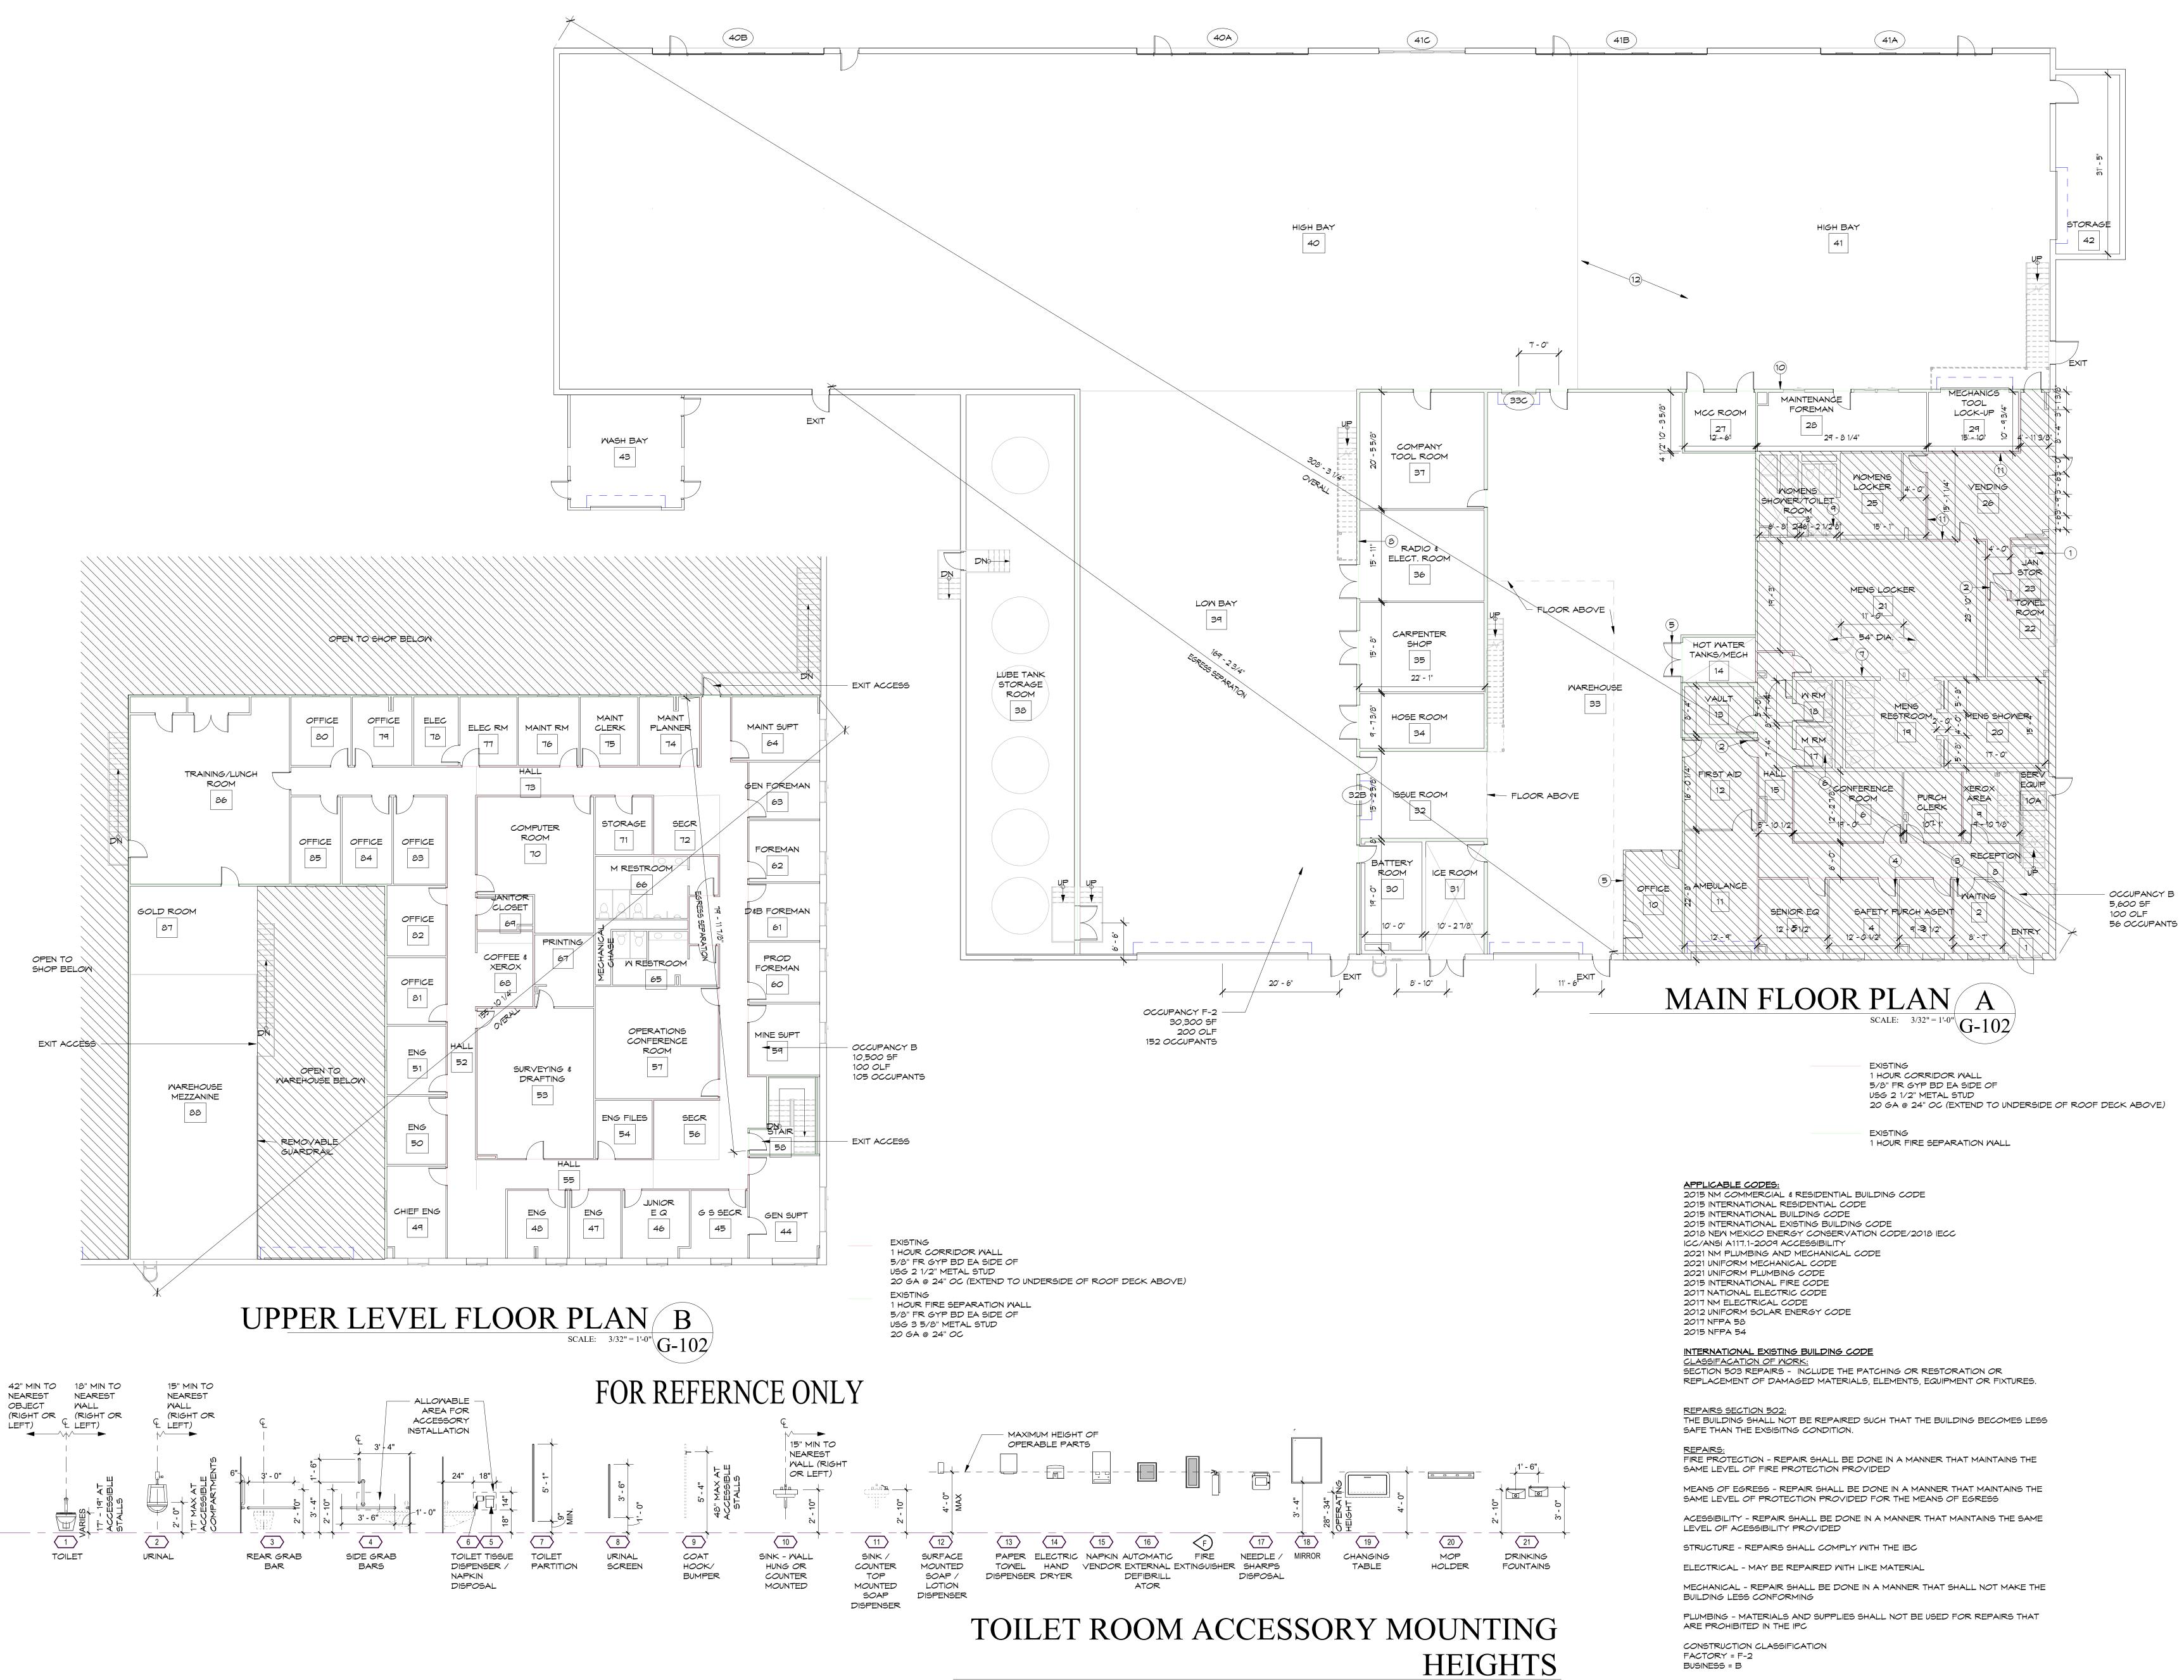

+ ASSOCIATES ENGINEERING

564 E. SECOND AVE, STE 201 DURANGO, CO 81301 (970) 259 - 7494 FAX (970) 259 - 7492 262 PAGOSA STREET, STE. 200 PAGOSA SPRINGS, CO 81147 RA-AE.COM

EXPRESSLY RESERVES THE COMMON LAW COPYRIGHT AND OTHER PROPERTY RIGHTS IN THESE PLANS. THESE
PLANS ARE NOT TO BE CHANGED OR COPIED IN ANY FORM OR MANNER WHATSOEVER NOR ARE THEY TO BE ASSIGNED TO ANY THIRD PARTY WITHOUT FIRST OBTAINING WRITTEN PERMISSION AND CONSENT OF THE ARCHITECT OF RECORD. THE USE OF THESE PLANS AND SPECIFICATIONS SHALL BE RESTRICTED TO THE ORIGINAL SITE FOR WHICH
THEY WERE PREPARED AND PUBLICATION TEHREOF IS EXPRESSLY LIMITED TO SUCH USE. FEDERAL LAW PROHIBITS THE REPRODUCTION, DISPLAY, SALE OR EXPRESS WRITTEN CONSENT OF RA+A ARCHITECTS, P.C.

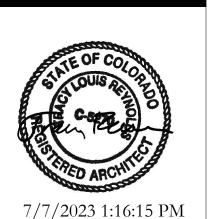

JOB. NO.: 2023-05-15

DRAWN BY: Author ISSUE RECORD: 2023-02-17 100% SD

2023-03-31 DD 2023-05-15 CD

REVISIONS:


FIRE SEPARATION DISTANCE IS GREATER THAN 30' ON ALL SIDES

IFC REQUIREMENTS

CONFIRM EXISTING LOCATIONS AND PROVIDE FIREHOSE CABINETS PER IBC AND

G-102

CODE PLAN

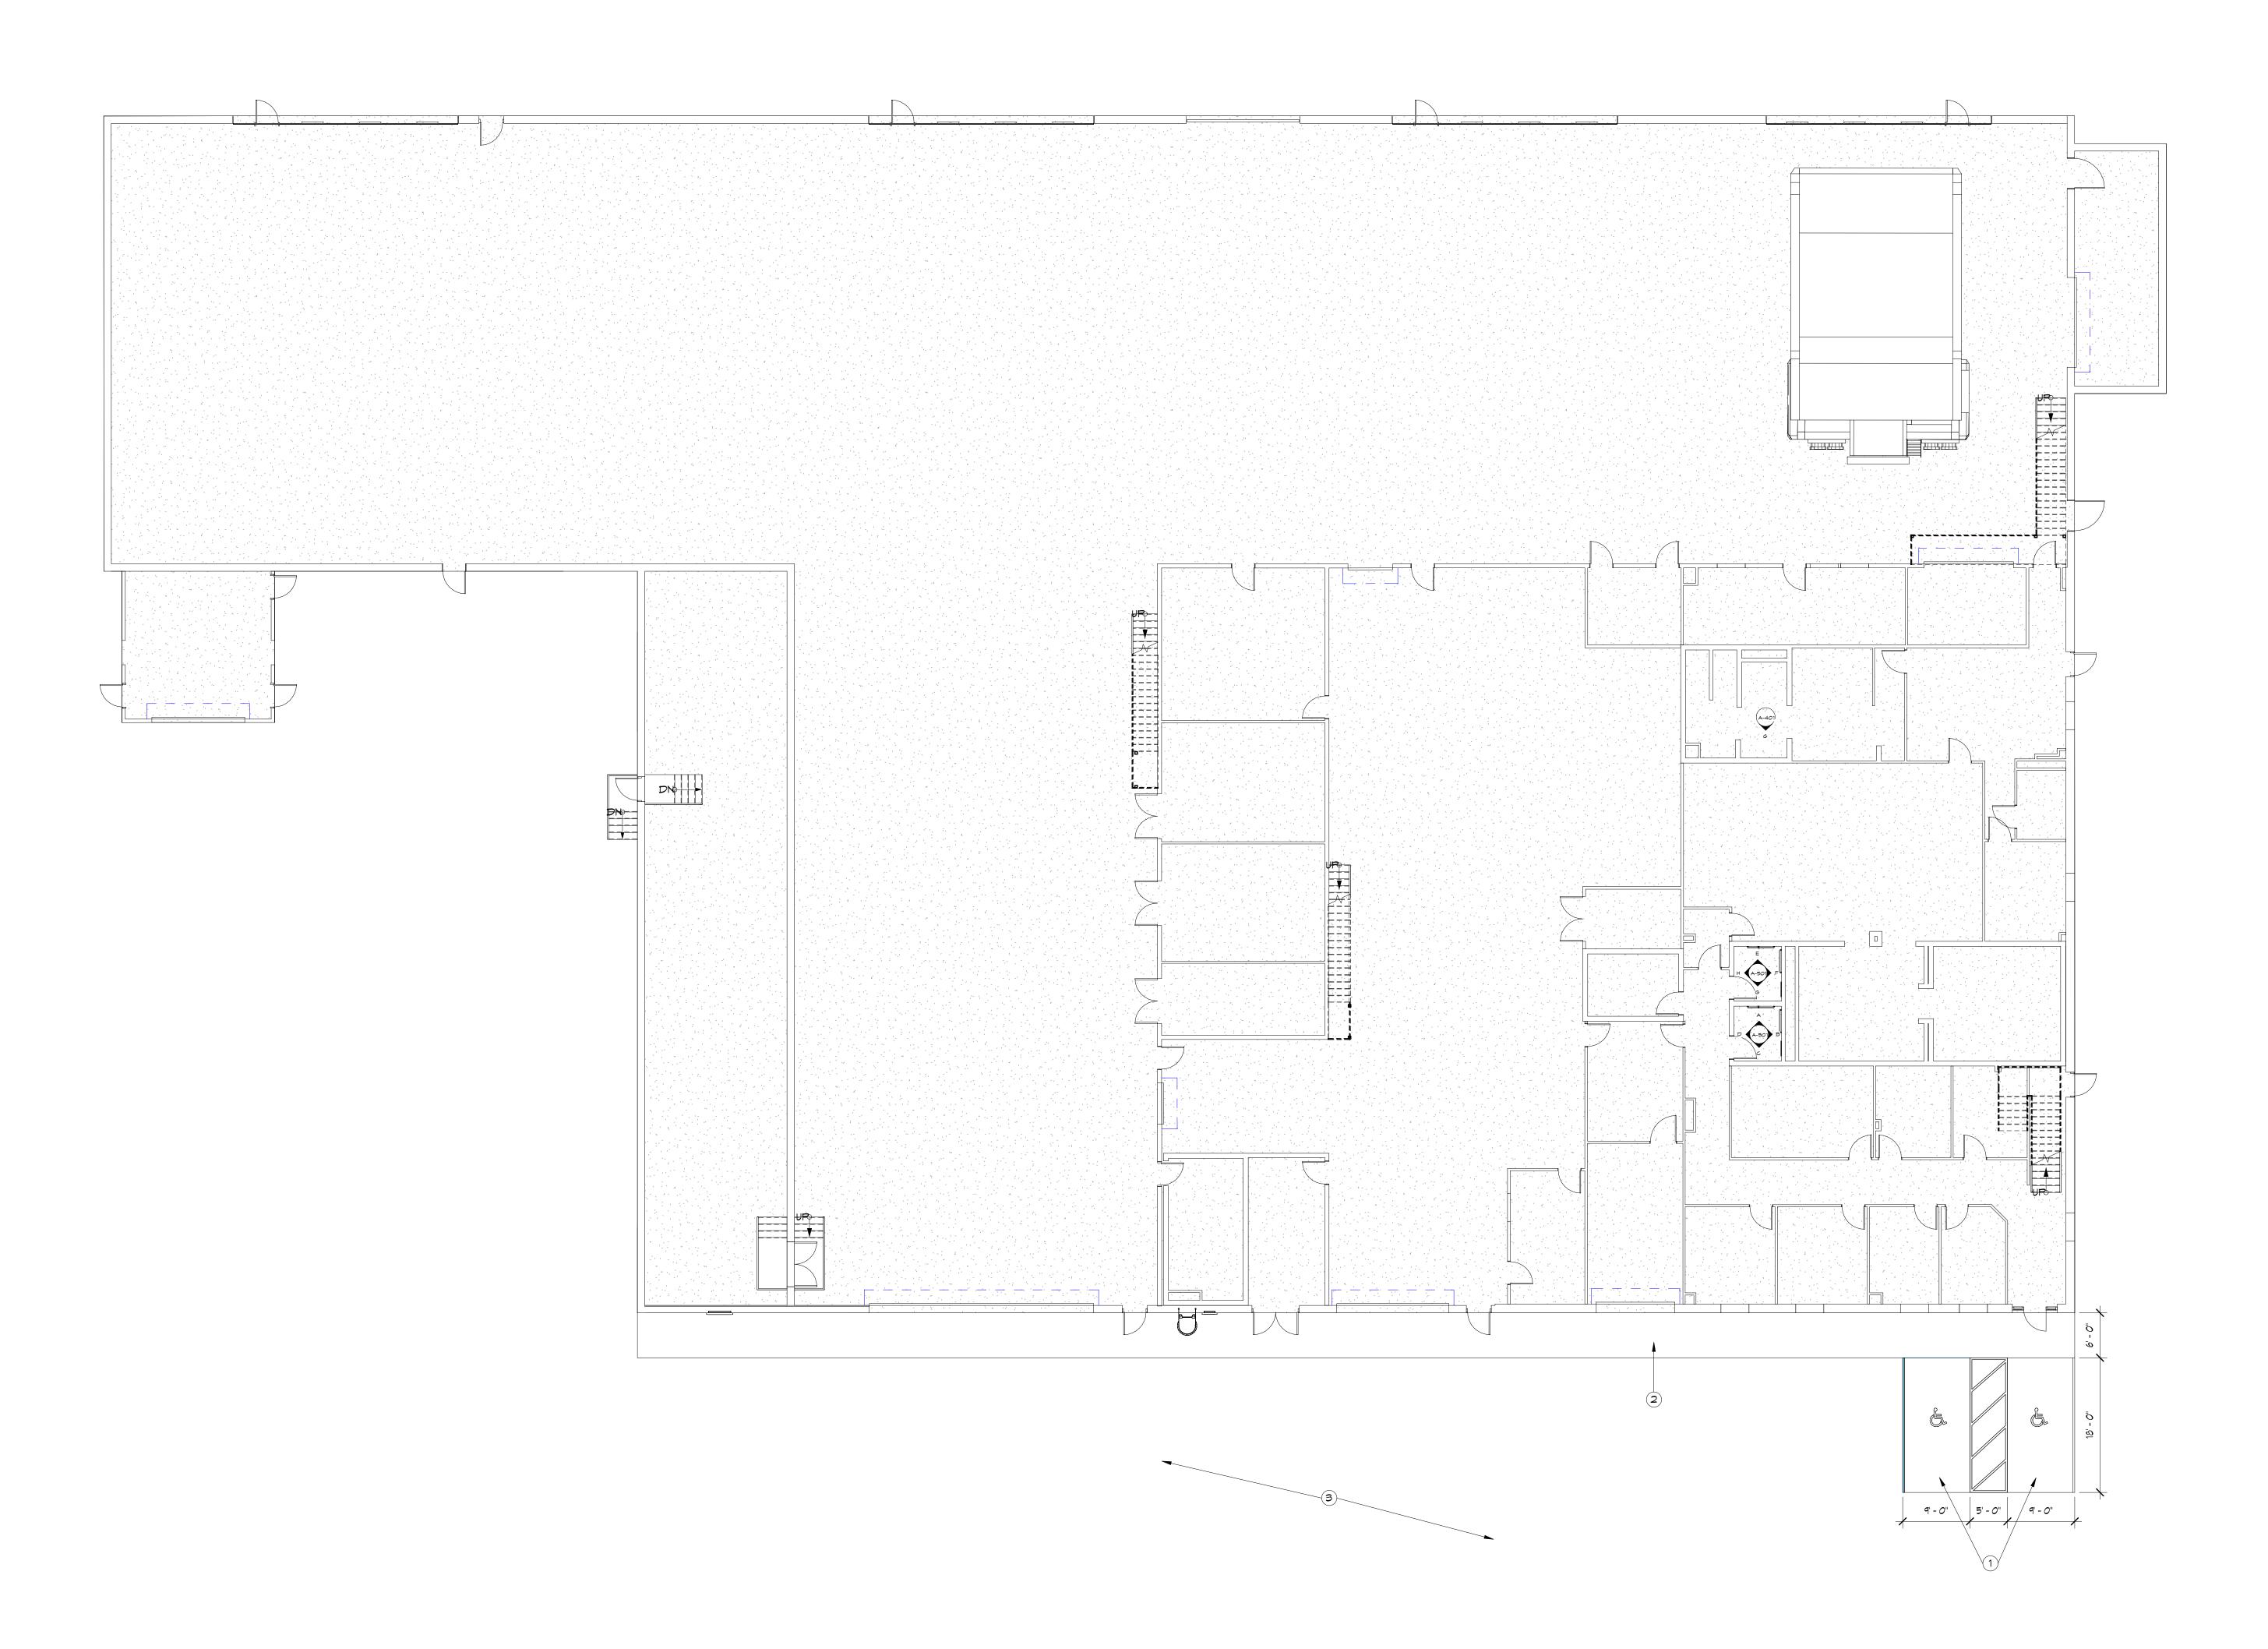



ARCHITECTURAL SITE PLAN SCALE: 1" = 10'-0"

SITE PLAN KEY NOTES

1 NEW CONCRETE ADA PARKING STALL
2 EXISTING CONCRETE WALK WAY
3 GRAVEL




564 E. SECOND AVE, STE 201 DURANGO, CO 81301 (970) 259 - 7494 FAX (970) 259 - 7492 262 PAGOSA STREET, STE. 200 P.O. BOX 96 PAGOSA SPRINGS, CO 81147

RA-AE.COM

REYNOLDS ASH + ASSOCIATES, P.C.
EXPRESSLY RESERVES THE COMMON LAW COPYRIGHT
AND OTHER PROPERTY RIGHTS IN THESE PLANS. THESE
PLANS ARE NOT TO BE CHANGED OR COPIED IN ANY
FORM OR MANNER WHATSOEVER NOR ARE THEY TO BE
ASSIGNED TO ANY THIRD PARTY WITHOUT FIRST
OBTAINING WRITTEN PERMISSION AND CONSENT OF
THE ARCHITECT OF RECORD.

THE USE OF THESE PLANS AND SPECIFICATIONS SHALL
BE RESTRICTED TO THE ORIGINAL SITE FOR WHICH
THEY WERE PREPARED AND PUBLICATION TEHREOF IS
EXPRESSLY LIMITED TO SUCH USE. FEDERAL LAW
PROHIBITS THE REPRODUCTION, DISPLAY, SALE OR
OTHER DISPOSITION OF THIS DOCUMENT WITHOUT THE
EXPRESS WRITTEN CONSENT OF
RA+A ARCHITECTS, P.C.

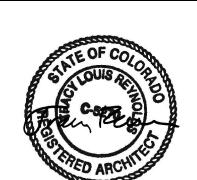

7/7/2023 1:16:15 PM

FAKK 161 RD 1130 PLATA, NEW MEXICO 87418

JOB. NO.: 22261 DATE: 2023-05-15 DRAWN BY: RA+A


ISSUE RECORD: 2023-02-17 100% SD 2023-03-31 DD 2023-05-15 CD

REVISIONS:

A Q 1 Q 1

AS-101


SITE PLANOVERALL

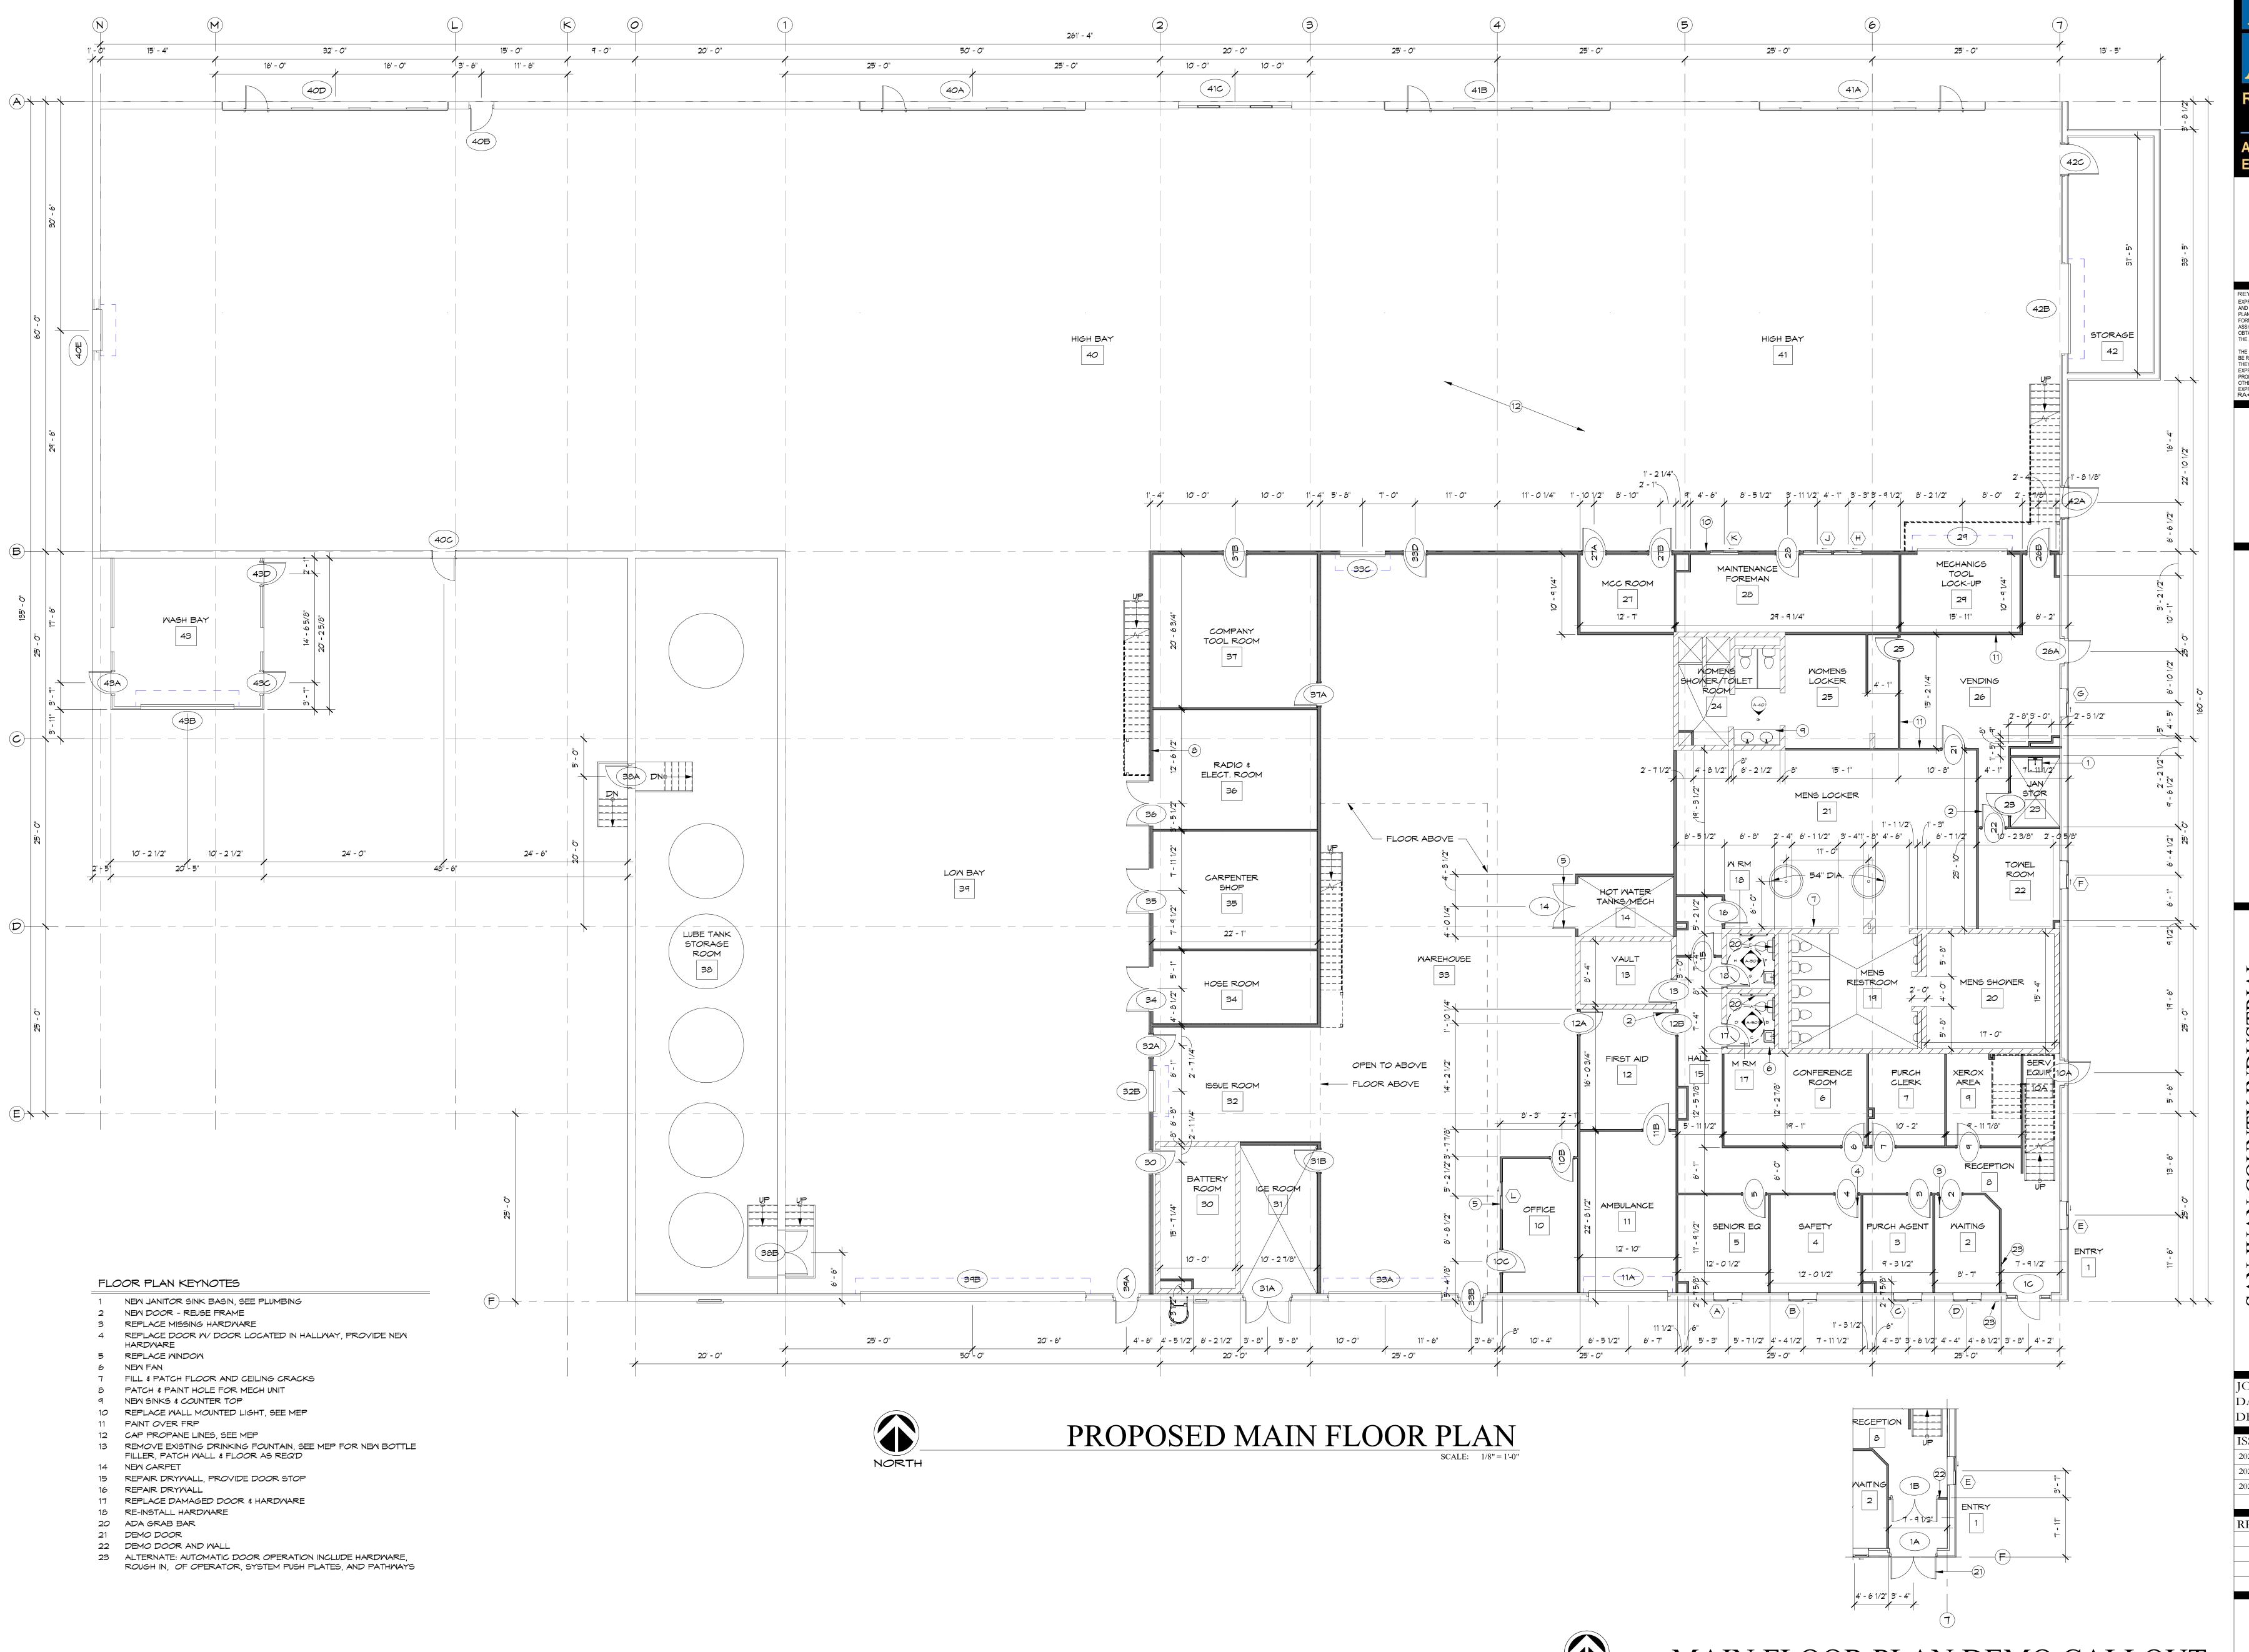

+ ASSOCIATES ENGINEERING

564 E. SECOND AVE, STE 201 DURANGO, CO 81301 (970) 259 - 7494 FAX (970) 259 - 7492 262 PAGOSA STREET, STE. 200 PAGOSA SPRINGS, CO 81147 RA-AE.COM

EXPRESSLY RESERVES THE COMMON LAW COPYRIGHT AND OTHER PROPERTY RIGHTS IN THESE PLANS. THESE
PLANS ARE NOT TO BE CHANGED OR COPIED IN ANY
FORM OR MANNER WHATSOEVER NOR ARE THEY TO BE
ASSIGNED TO ANY THIRD PARTY WITHOUT FIRST OBTAINING WRITTEN PERMISSION AND CONSENT OF THE ARCHITECT OF RECORD. THE USE OF THESE PLANS AND SPECIFICATIONS SHALL BE RESTRICTED TO THE ORIGINAL SITE FOR WHICH
THEY WERE PREPARED AND PUBLICATION TEHREOF IS EXPRESSLY LIMITED TO SUCH USE. FEDERAL LAW PROHIBITS THE REPRODUCTION, DISPLAY, SALE OR EXPRESS WRITTEN CONSENT OF RA+A ARCHITECTS, P.C.

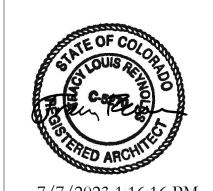

7/7/2023 1:16:16 PM

JOB. NO.: DATE: 2023-05-15 DRAWN BY: RA+A

ISSUE RECORD: 2023-02-17 100% SD 2023-03-31 DD 2023-05-15 CD

REVISIONS:

A-101 MAIN FLOOR PLAN

MAIN FLOOR PLAN DEMO CALLOUT

NORTH



23 ALTERNATE: AUTOMATIC DOOR OPERATION INCLUDE HARDWARE, ROUGH IN, OF OPERATOR, SYSTEM PUSH PLATES, AND PATHWAYS


REYNOLDS ASH + ASSOCIATES **ARCHITECTURE** ENGINEERING

> 564 E. SECOND AVE, STE 201 DURANGO, CO 81301 (970) 259 - 7494 FAX (970) 259 - 7492 262 PAGOSA STREET, STE. 200 PAGOSA SPRINGS, CO 81147

> > RA-AE.COM

REYNOLDS ASH + ASSOCIATES, P.C. EXPRESSLY RESERVES THE COMMON LAW COPYRIGHT AND OTHER PROPERTY RIGHTS IN THESE PLANS. THESE
PLANS ARE NOT TO BE CHANGED OR COPIED IN ANY
FORM OR MANNER WHATSOEVER NOR ARE THEY TO BE
ASSIGNED TO ANY THIRD PARTY WITHOUT FIRST OBTAINING WRITTEN PERMISSION AND CONSENT OF THE ARCHITECT OF RECORD.

THE USE OF THESE PLANS AND SPECIFICATIONS SHALL BE RESTRICTED TO THE ORIGINAL SITE FOR WHICH THEY WERE PREPARED AND PUBLICATION TEHREOF IS EXPRESSLY LIMITED TO SUCH USE. FEDERAL LAW PROHIBITS THE REPRODUCTION, DISPLAY, SALE OR OTHER DISPOSITION OF THIS DOCUMENT WITHOUT THE EXPRESS WRITTEN CONSENT OF RA+A ARCHITECTS, P.C.

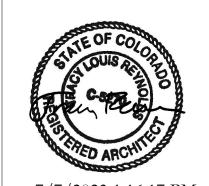

7/7/2023 1:16:17 PM

COUNTY PARK

161 RD 1130 FA, NEW MEXICO 8

JOB. NO.: DATE: 2023-05-15 DRAWN BY: RA+A

ISSUE RECORD: 2023-02-17 100% SD 2023-03-31 DD 2023-05-15 CD


REVISIONS:

UPPER LEVEL FLOOR PLAN

ROOF PLAN KEY NOTES

- 1 EVALUATE OVERALL ROOF CONDITION, PATCH LEAKS @ ROOF VENTS & TRANSITIONS.
- CONTRACTOR TO HOLD ALLOWANCE. 2 EXISTING PRE FINISHED INSULATE 24 GA METAL
- ROOF SYSTEM



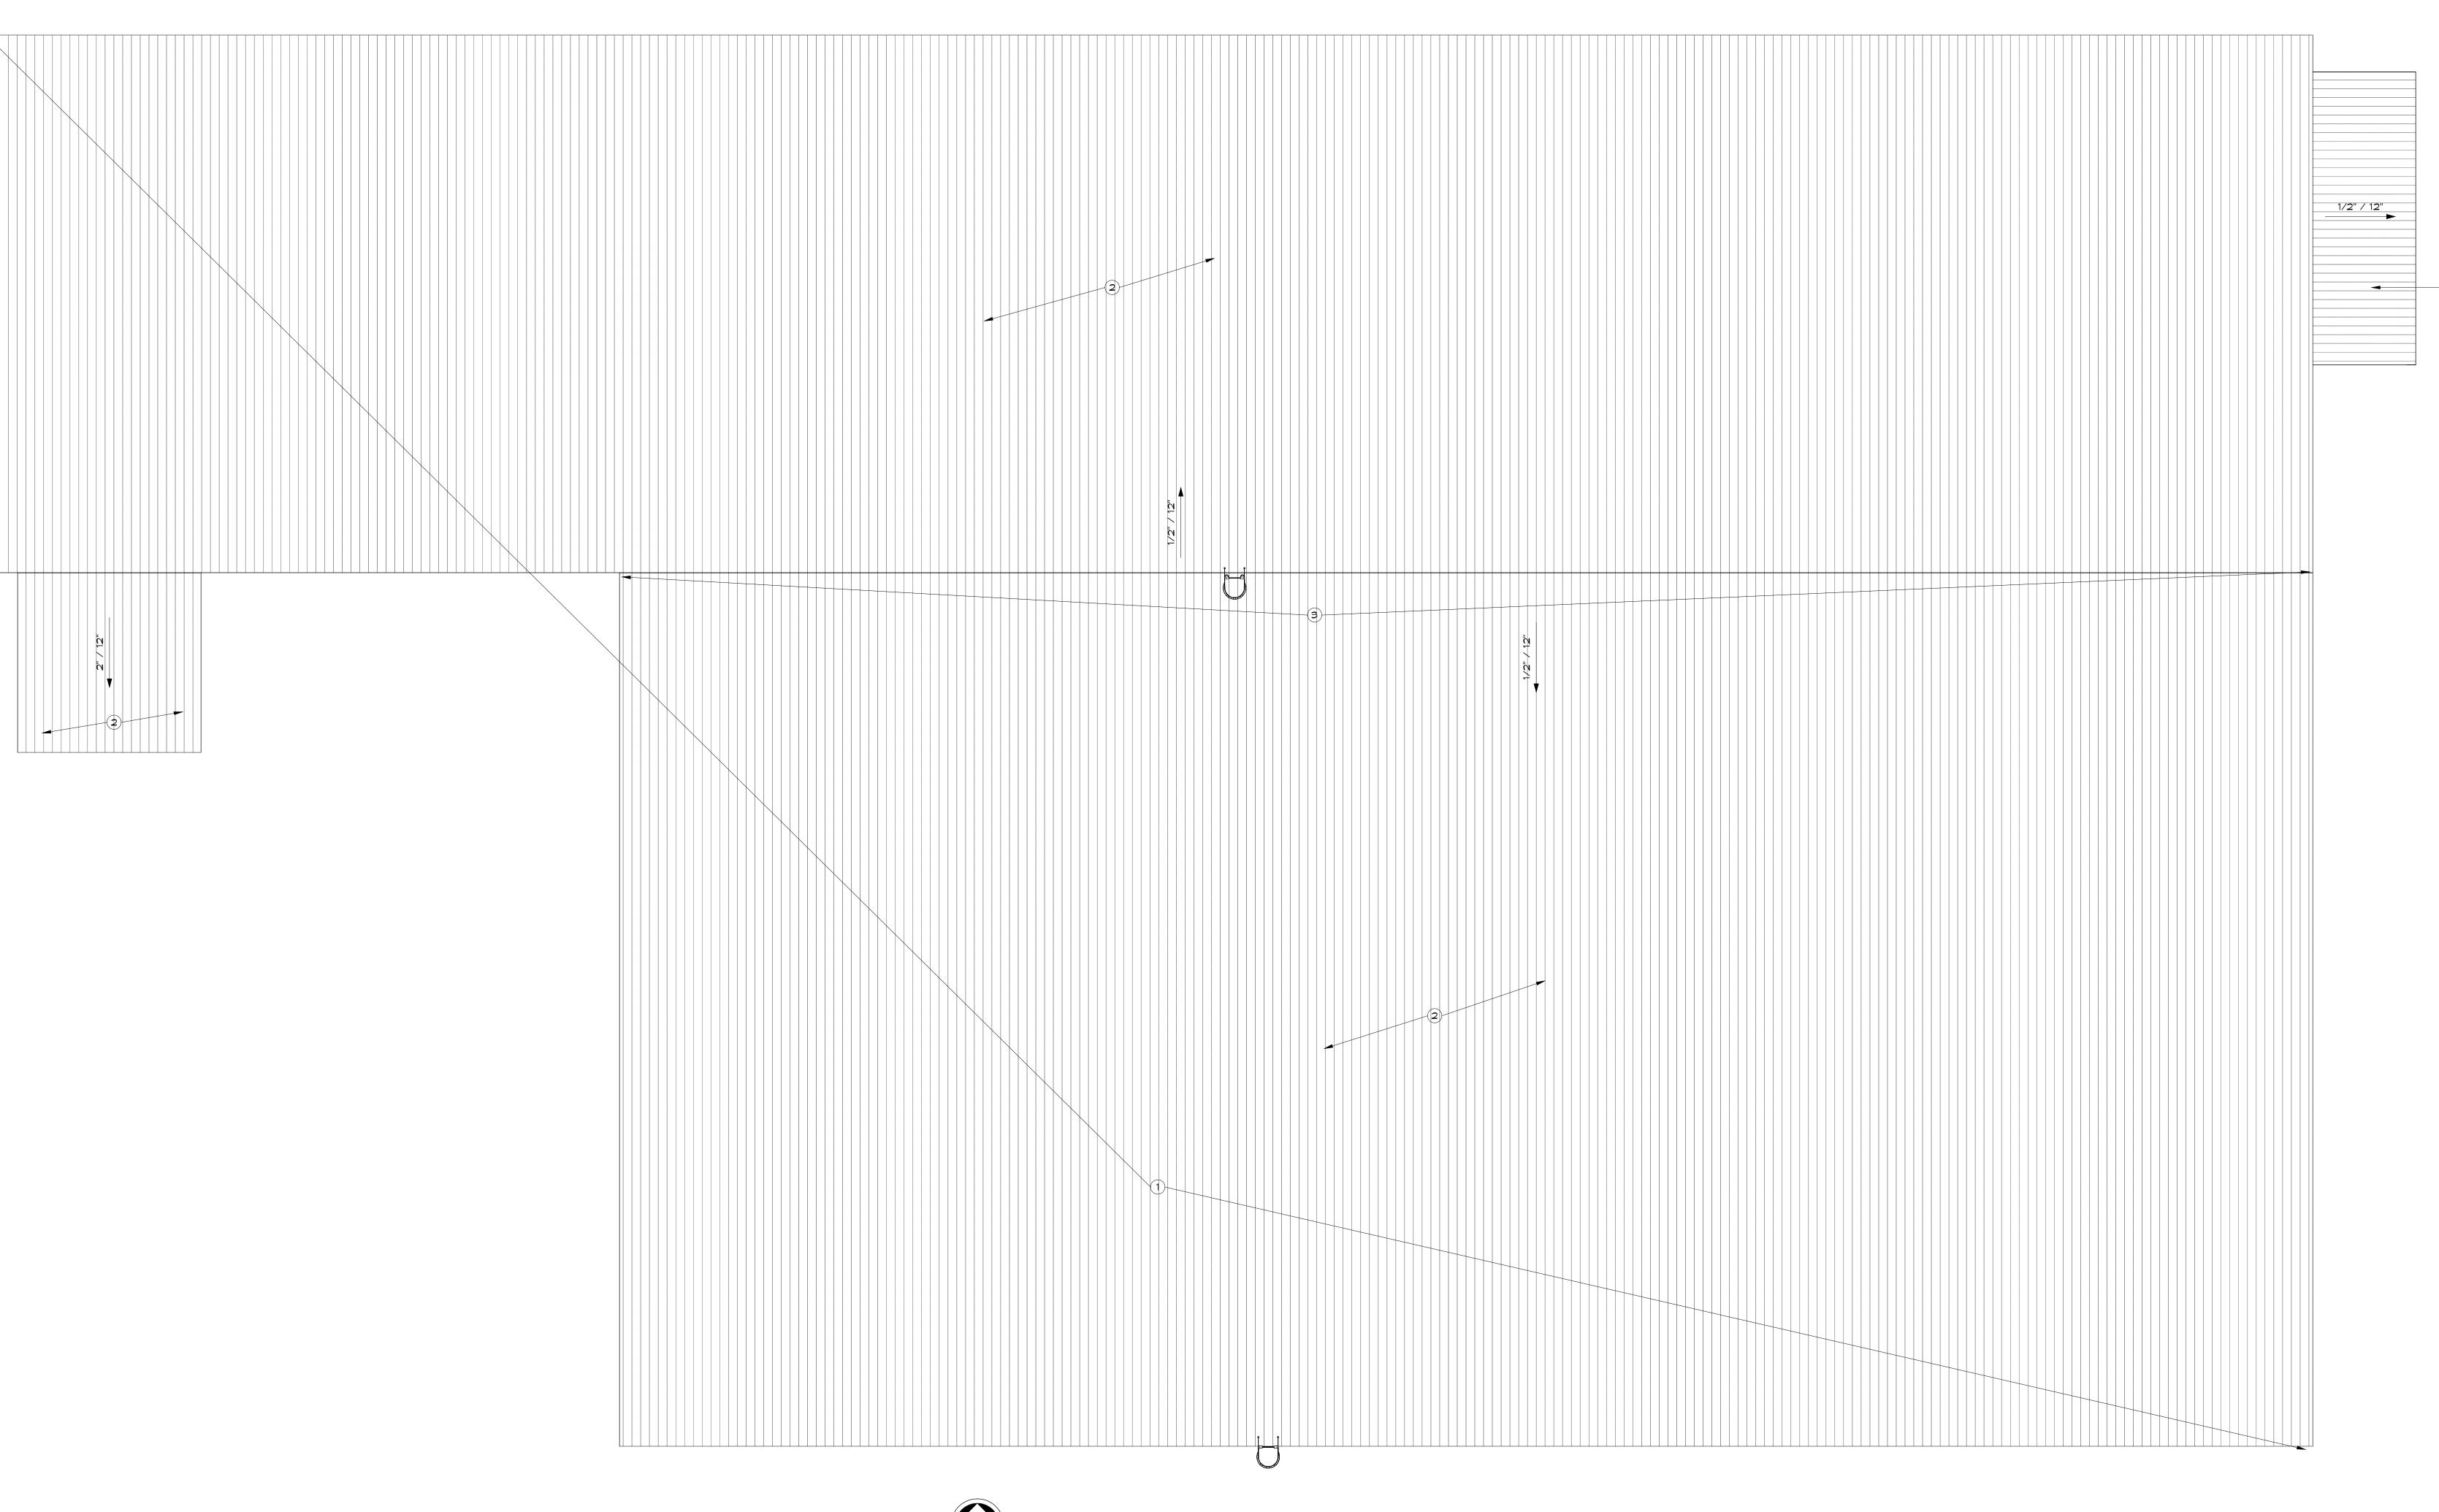



ROOF PLAN

SCALE: 1/8" = 1'-0"





564 E. SECOND AVE, STE 201 DURANGO, CO 81301 (970) 259 - 7494 FAX (970) 259 - 7492

262 PAGOSA STREET, STE. 200 P.O. BOX 96 PAGOSA SPRINGS, CO 81147 RA-AE.COM

REYNOLDS ASH + ASSOCIATES, P.C. REYNOLDS ASH + ASSOCIATES, P.C.

EXPRESSLY RESERVES THE COMMON LAW COPYRIGHT

AND OTHER PROPERTY RIGHTS IN THESE PLANS. THESE

PLANS ARE NOT TO BE CHANGED OR COPIED IN ANY

FORM OR MANNER WHATSOEVER NOR ARE THEY TO BE

ASSIGNED TO ANY THIRD PARTY WITHOUT FIRST

OBTAINING WRITTEN PERMISSION AND CONSENT OF

THE ARCHITECT OF RECORD. THE USE OF THESE PLANS AND SPECIFICATIONS SHALL BE RESTRICTED TO THE ORIGINAL SITE FOR WHICH THEY WERE PREPARED AND PUBLICATION TEHREOF IS EXPRESSLY LIMITED TO SUCH USE. FEDERAL LAW PROHIBITS THE REPRODUCTION, DISPLAY, SALE OR OTHER DISPOSITION OF THIS DOCUMENT WITHOUT THE EXPRESS WRITTEN CONSENT OF RA+A ARCHITECTS, P.C.



161 RD 1130 LA PLATA, NEW MEXICO 87418

 JOB. NO.:
 22261

 DATE:
 2023-05-15


 DRAWN BY:
 Author

 22261 2023-05-15

ISSUE RECORD: 2023-02-17 100% SD 2023-03-31 DD 2023-05-15 CD

REVISIONS:

A-103

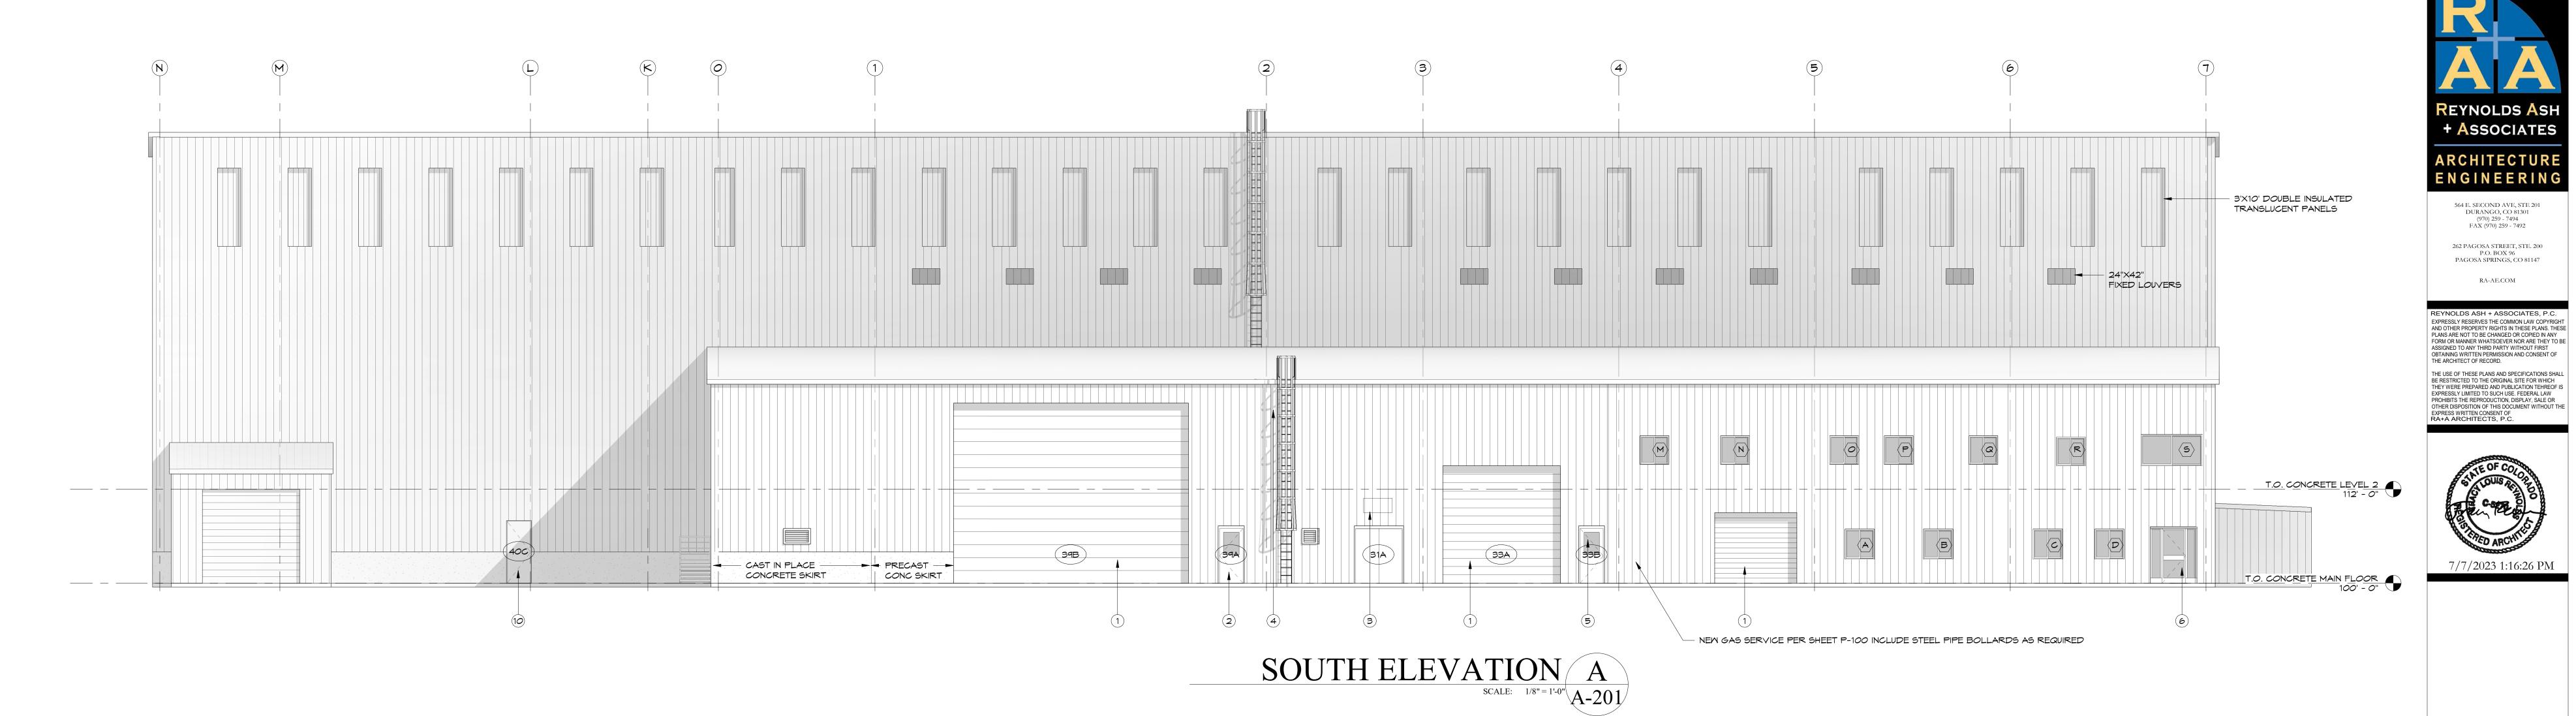

1 PAINT DOOR

- 2 REPLACE DOOR FRAME & GLASS 3 REMOVE THROUGH WALL UNIT & PATCH OPENING
- 4 REPLACE EXTERIOR LIGHTS, SEE MEP 5 REPLACE GLASS
- 6 NEW DOOR W/ SIDE LITES

ELEVATION KEYNOTES

- 7 PATCH & RE-INSULATE HOLES IN EXTERIOR WALLS 8 BASIS OF DESIGN: REPLACE GLASS. CONTRACTOR TO EVALUATE IF
- DOOR REPLACEMENT FEASIBLE. IF NOT PROVIDE NEW DOOR & FRAME
- 9 NEW DOWNSPOUT OR PORTION OF DOWNSPOUT 10 REPLACE DOOR & FRAME
- 11 REPLACE MAN DOOR, OVERHEAD DOOR TO REMAIN UN-CHANGED 12 INFILL DOOR

GENERAL ELEVATION NOTES

- A. PROVIDE SPLASH PADS @ ALL DOWNSPOUTS
 - B. WASH BAY NOT IN SCOPE OF WORK
 - C. EXTERIOR CLADDING PREFINISHED INSULATED 26 GA METAL WALL PANEL SIDING
 - D. ANY NEW PATCHWORK OR INFILL TO MATCH EXISTING BUILDING TYPE III-B CONSTRUCTION AND CLADDING

3'X10' DOUBLE INSULATED -TRANSLUCENT PANELS T.O. CONCRETE LEVEL 2 112' - 0" T.O. CONCRETE MAIN FLOOR 100' - 0"

EAST ELEVATION B
SCALE: 1/8" = 1'-0" A-201

COUNTY INDUSTRI PARK 161 RD 1130 FA, NEW MEXICO 8


JOB. NO.: 2023-05-15 DATE: DRAWN BY: RA+A

ISSUE RECORD: 2023-02-17 100% SD 2023-03-31 DD 2023-05-15 CD

REVISIONS:

A-201

EXTERIOR ELEVATIONS

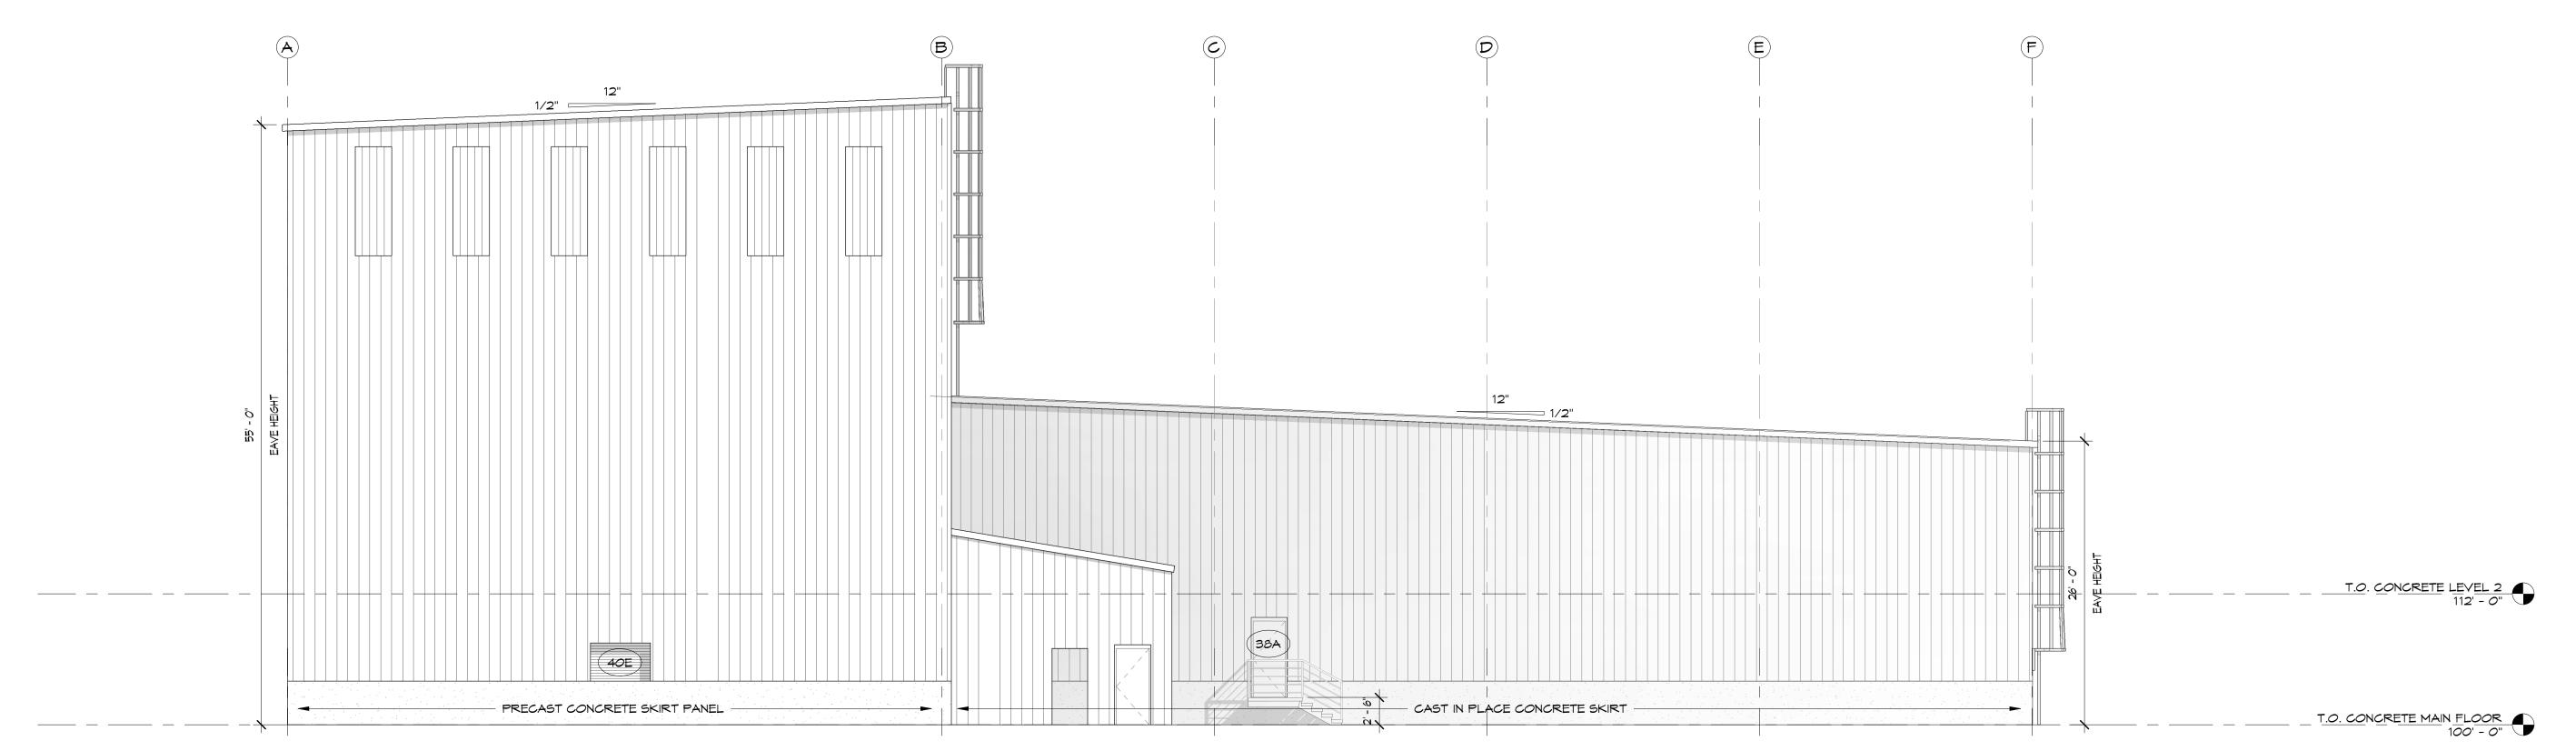

WEST ELEVATION A

7/7/2023 1:16:30 PM

REYNOLDS ASH

+ ASSOCIATES

ARCHITECTURE

ENGINEERING

564 E. SECOND AVE, STE 201 DURANGO, CO 81301 (970) 259 - 7494 FAX (970) 259 - 7492

262 PAGOSA STREET, STE. 200 P.O. BOX 96 PAGOSA SPRINGS, CO 81147

RA-AE.COM

REYNOLDS ASH + ASSOCIATES, P.C.

EXPRESSLY RESERVES THE COMMON LAW COPYRIGHT
AND OTHER PROPERTY RIGHTS IN THESE PLANS. THESE
PLANS ARE NOT TO BE CHANGED OR COPIED IN ANY
FORM OR MANNER WHATSOEVER NOR ARE THEY TO BE
ASSIGNED TO ANY THIRD PARTY WITHOUT FIRST
OBTAINING WRITTEN PERMISSION AND CONSENT OF
THE ARCHITECT OF RECORD.

THE USE OF THESE PLANS AND SPECIFICATIONS SHALL BE RESTRICTED TO THE ORIGINAL SITE FOR WHICH THEY WERE PREPARED AND PUBLICATION TEHREOF IS EXPRESSLY LIMITED TO SUCH USE. FEDERAL LAW PROHIBITS THE REPRODUCTION, DISPLAY, SALE OR OTHER DISPOSITION OF THIS DOCUMENT WITHOUT THE EXPRESS WRITTEN CONSENT OF RA+A ARCHITECTS, P.C.


ELEVATION KEYNOTES

1 PAINT DOOR

- 2 REPLACE DOOR FRAME & GLASS 3 REMOVE THROUGH WALL UNIT & PATCH OPENING
- 4 REPLACE EXTERIOR LIGHTS, SEE MEP
- 5 REPLACE GLASS
- 6 NEW DOOR W/ SIDE LITES
- 7 PATCH & RE-INSULATE HOLES IN EXTERIOR WALLS 8 BASIS OF DESIGN: REPLACE GLASS. CONTRACTOR TO EVALUATE IF DOOR REPLACEMENT FEASIBLE. IF NOT PROVIDE NEW DOOR & FRAME
- 9 NEW DOWNSPOUT OR PORTION OF DOWNSPOUT
- 10 REPLACE DOOR & FRAME 11 REPLACE MAN DOOR, OVERHEAD DOOR TO REMAIN UN-CHANGED 12 INFILL DOOR

GENERAL ELEVATION NOTES

- A. PROVIDE SPLASH PADS @ ALL DOWNSPOUTS
- B. WASH BAY NOT IN SCOPE OF WORK
- C. EXTERIOR CLADDING PREFINISHED INSULATED 26 GA METAL WALL
- D. ANY NEW PATCHWORK OR INFILL TO MATCH EXISTING BUILDING TYPE III-B CONSTRUCTION AND CLADDING

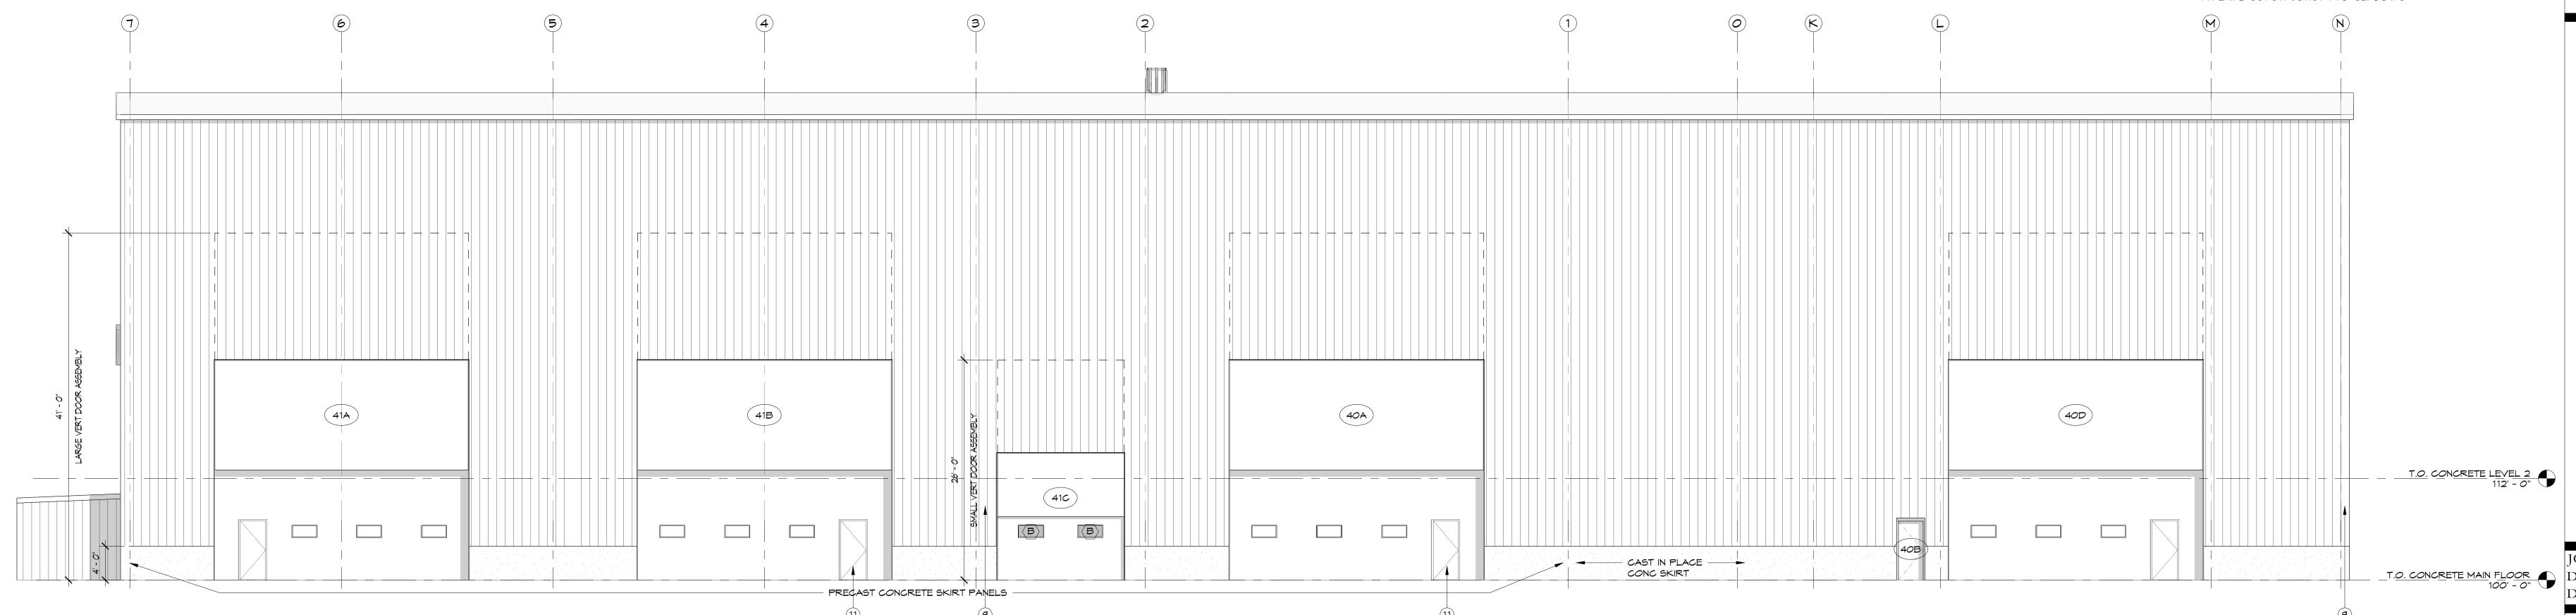

NORTH ELEVATION B
SCALE: 1/8" = 1'-0" A-202

ISSUE RECORD: 2023-02-17 100% SD 2023-03-31 DD

REVISIONS:

2023-05-15 CD

A-202

EXTERIOR ELEVATIONS



NORTH

FIRST FLOOR RCP SCALE: 1/8" = 1'-0"

REFLECTED CEILING PLAN KEY NOTES

- GYPSUM BOARD CEILING
- DROPPED ACCOUSTIC TILE CEILING, ARMSTRONG 769A
- OPEN TO STRUCTURE ABOVE

2023-03-31 DD

2023-05-15 CD

DATE:

REVISIONS:

DRAWN BY: RA+A

ISSUE RECORD:

2023-02-17 100% SD

564 E. SECOND AVE, STE 201 DURANGO, CO 81301 (970) 259 - 7494 FAX (970) 259 - 7492

262 PAGOSA STREET, STE. 200 PAGOSA SPRINGS, CO 81147

RA-AE.COM

7/7/2023 1:16:31 PM

FIRST FLOOR REFLECTED CEILING PLAN

161 RD 1130 ATA, NEW MEXICO 87418

2023-05-15





UPPER FLOOR RCP

REFLECTED CEILING PLAN KEY NOTES

GYPSUM BOARD CEILING

DROPPED ACCOUSTIC TILE CEILING, ARMSTRONG 769A 3 OPEN TO STRUCTURE ABOVE

REYNOLDS ASH + ASSOCIATES **ARCHITECTURE** ENGINEERING

564 E. SECOND AVE, STE 201 DURANGO, CO 81301 (970) 259 - 7494 FAX (970) 259 - 7492 262 PAGOSA STREET, STE. 200 PAGOSA SPRINGS, CO 81147 RA-AE.COM

REYNOLDS ASH + ASSOCIATES, P.C. REYNOLDS ASH + ASSOCIATES, P.C.

EXPRESSLY RESERVES THE COMMON LAW COPYRIGHT
AND OTHER PROPERTY RIGHTS IN THESE PLANS. THESE
PLANS ARE NOT TO BE CHANGED OR COPIED IN ANY
FORM OR MANNER WHATSOEVER NOR ARE THEY TO BE
ASSIGNED TO ANY THIRD PARTY WITHOUT FIRST
OBTAINING WRITTEN PERMISSION AND CONSENT OF
THE ARCHITECT OF RECORD. THE USE OF THESE PLANS AND SPECIFICATIONS SHALL BE RESTRICTED TO THE ORIGINAL SITE FOR WHICH THEY WERE PREPARED AND PUBLICATION TEHREOF IS EXPRESSLY LIMITED TO SUCH USE. FEDERAL LAW PROHIBITS THE REPRODUCTION, DISPLAY, SALE OR OTHER DISPOSITION OF THIS DOCUMENT WITHOUT THE EXPRESS WRITTEN CONSENT OF RA+A ARCHITECTS, P.C.




JOB. NO.: 2023-05-15 DRAWN BY: Author

ISSUE RECORD: 2023-02-17 100% SD 2023-03-31 DD 2023-05-15 CD

REVISIONS:


A-302

UPPER FLOOR REFLECTED CEILING PLAN

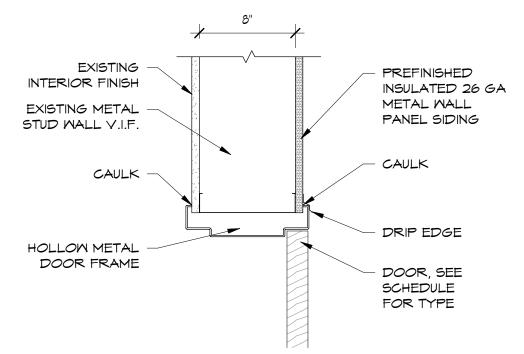

				WINDOW SCHEDULE
Type Mark	Midth	Height	Type Comments	Comments
A	3' - 9"	3' - 10"	SLIDER	
AA	3' - 8"	3' - 8"	SLIDER	
В	<varies></varies>	<varies></varies>		
BB	3' - 8"	3' - 8"	SLIDER	
C	3' - 9"	3' - 10"	SLIDER	
CC	3' - 8"	3' - 8"	SLIDER	
D	3' - 9"	3' - 10"	SLIDER	
DD	3' - 8"	3' - 8"	SLIDER	
E	3' - 9"	3' - 10"	SLIDER	
EE	3' - O"	3' - O"	SLIDER	
F	3' - 9"	3' - 10"	SLIDER	REPLACE MINDOM
FF	3' - O"	3' - O"	SLIDER	
G	3' - 9"	3' - 10"	SLIDER	REPLACE MINDOM
GG	3' - O"	3' - O"	SLIDER	
H	3' - 9"	3' - 10"	SLIDER	
HH	3' - O"	3' - O"	SLIDER	
J	3' - 9"	3' - 10"	SLIDER	
JJ	3' - 8"	3' - 8"	SLIDER	
K	3' - 9"	3' - 10"	SLIDER	
KK	3' - 8"	3' - 8"	SLIDER	
L	3' - 9"	3' - 10"	SLIDER	REPLACE MINDOM
LL	3' - 8"	3' - 8"	SLIDER	
М	3' - 8"	3' - 8"	SLIDER	
ММ	3' - 8"	3' - 8"	SLIDER	



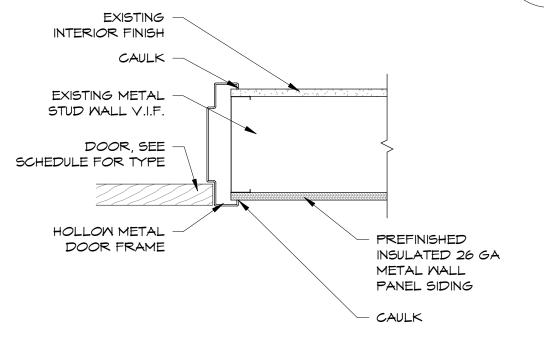

Y	3' - 8"	3' - 8"	SLIDER	REPLACE MINDOM
Z	3' - 8"	3' - 8"	SLIDER	REPLACE MINDOM
		•		

PROVIDE TEMPERED GLASS AS REQUIRED BY IBC CHAPTER 24

4' - 0"

SLIDER

SLIDER

SLIDER

SLIDER

SLIDER


SLIDER SLIDER


SLIDER SLIDER

SLIDER

SLIDER


SLIDER

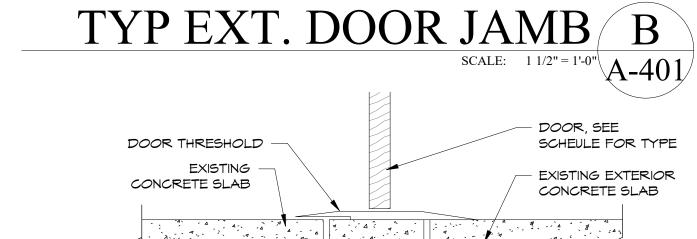

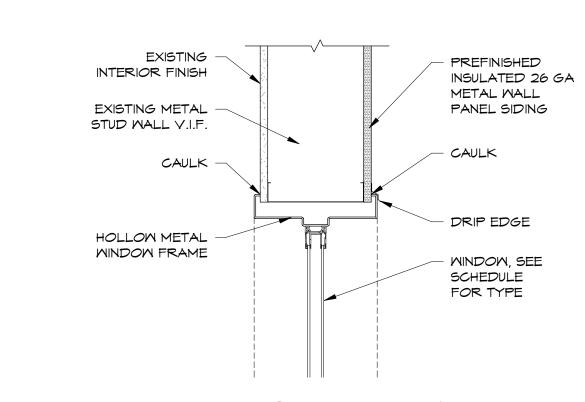

REPLACE MINDOM


TYP EXT. DOOR SILL C TYP EXT. WINDOW HEADER D SCALE: 1 1/2" = 1'-0" A-401

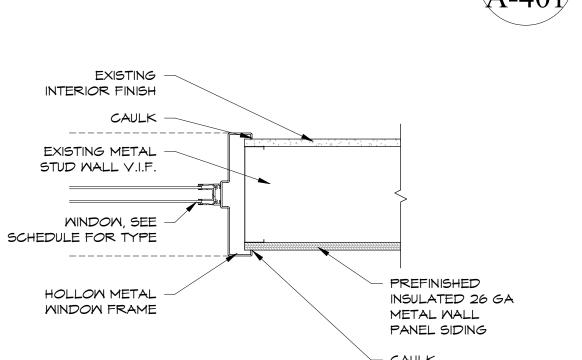

- MINDOM, SEE SCHEDULE FOR TYPE HOLLOW METAL MINDOM FRAME CAULK -EXISTING METAL STUD WALL V.I.F. PREFINISHED EXISTING -INSULATED 26 GA INTERIOR FINISH METAL WALL PANEL SIDING

TYP EXT. WINDOW JAMB E



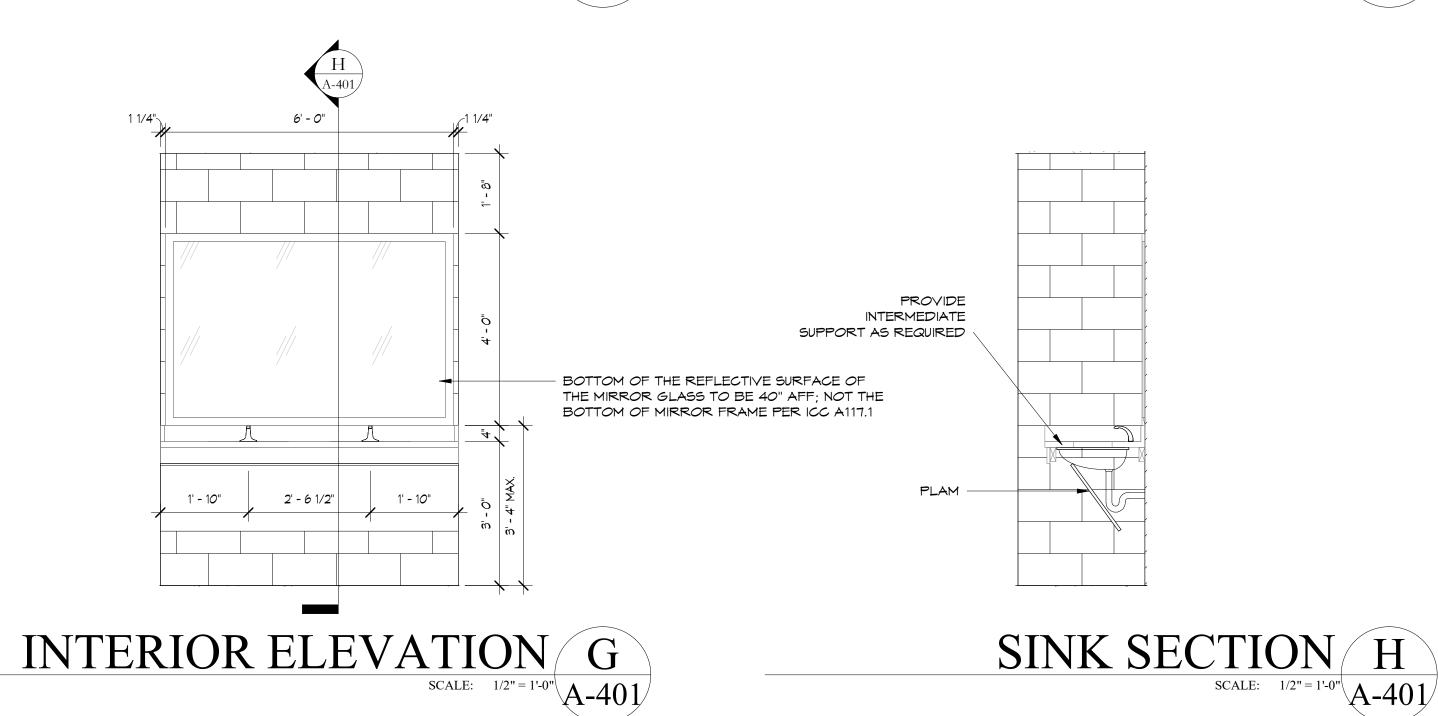

F	HARDWARE SETS
#	DESCRIPTION
1	SINGLE KNOB (TO MATCH EXISTING), KEYED, 3 HINGES, CLOSER, AND STOP. TO MATCH EXISTING, FINISH TO MATCH EXISTING
2	SINGLE EXTERIOR GRADE, PULL, 3 HINGES, CLOSER, MORTISE LOCK EXIT DEVICE, KICK PLATE


3	SINGLE EXTERIOR GRADE, PULL, 3 HINGES, CLOSER, MORTISE LOCK EXIT DEVICE, KICK PLATE, ALTERNATE: AUTOMATIC DOOR OPERATION
4	EXTERIOR GRADE, PULL, 3 HINGES, KICK PLATE, CLOSER,


					DOOK	CHEDULE			
MARK	MIDTH	HEIGHT	DOOR TYPE	DOOR FINISH	FRAME TYPE	HARDWARE FRAME FINISH SET	EXISTING	NEM	REMARKS
	6' - 0"			EXISTING		EXISTING	X	NLY	DEMO DOORS
В	6' - 0"	7' - 0"	EXT DBL SMING	EXISTING	HOLLOW METAL	EXISTING	X		DEMO DOORS
	3' - 0"					CLEAR ANODIZED 3	,	X	NEW DOOR W/ SIDE LITES
	3' - 0" 3' - 0"			EXISTING TO REMAIN		EXISTING TO REMAIN 1 EXISTING TO REMAIN	X		REPLACE MISSING HARDWARE
	3' - 0"			EXISTING TO REMAIN		EXISTING TO REMAIN 1	X		RE-USE EXISTING DOOR IN HALLMAY, PROVIDE NEW HARDWARE
•	3' - O"			EXISTING TO REMAIN		EXISTING TO REMAIN	X		•
	3' - 0"			EXISTING TO REMAIN		EXISTING TO REMAIN	X		
	3' - 0"			EXISTING TO REMAIN		EXISTING TO REMAIN	×		
	3' - 0" 3' - 0"			EXISTING TO REMAIN		EXISTING TO REMAIN EXISTING TO REMAIN	×		
	3' - 0"			EXISTING TO REMAIN		EXISTING TO REMAIN	X		
OC	3' - 0"	7' - 0"	INT SMING	EXISTING TO REMAIN	HOLLOW METAL	EXISTING TO REMAIN	X		
1A				PAINT		N/A	×		
	3' - 5" 3' - 0"			EXISTING TO REMAIN		EXISTING TO REMAIN EXISTING TO REMAIN	×		
	3' - 0"			EXISTING TO REMAIN WOOD DOOR TO MATCH EXISTING		EXISTING TO REMAIN	,	X	FRAME TO REMAIN
	3' - 0"			EXISTING TO REMAIN		EXISTING TO REMAIN	X		
4	6' - 0"	7' - 0"	INT DBL SMING	EXISTING TO REMAIN	HOLLOW METAL	EXISTING TO REMAIN	×		REPAIR BROKEN GLASS
	3' - 0"			EXISTING TO REMAIN		EXISTING TO REMAIN	X		
	3' - 0" 3' - 0"			EXISTING TO REMAIN EXISTING TO REMAIN		EXISTING TO REMAIN EXISTING TO REMAIN	×		
	3' - O"			EXISTING TO REMAIN		EXISTING TO REMAIN	X		
<u>?</u> 1	3' - 0"	7' - 0"	INT SMING	EXISTING TO REMAIN	HOLLOW METAL	EXISTING TO REMAIN	×		
	3' - 0"			WOOD DOOR TO MATCH EXISTING		EXISTING TO REMAIN	ľ	X	FRAME TO REMAIN
	3' - 0" 3' - 0"			EXISTING TO REMAIN		EXISTING TO REMAIN EXISTING TO REMAIN	X		
	3' - O"			EXISTING TO REMAIN		EXISTING TO REMAIN 2*	×		REPAIR BROKEN GLASS, EVALUATE DOOR FOR REPLACEMENT
26B	3' - O"			EXISTING TO REMAIN		EXISTING TO REMAIN	X		
:7A	3' - 0"			EXISTING TO REMAIN		EXISTING TO REMAIN	X		
:7B	3' - 0"			EXISTING TO REMAIN		EXISTING TO REMAIN	X		
. <u>. </u>	3' - 0" 12' - 0"			EXISTING TO REMAIN EXISTING TO REMAIN		EXISTING TO REMAIN N/A	×		
60				EXISTING TO REMAIN	<u> </u>	EXISTING TO REMAIN	X		
	6' - 0"			EXISTING TO REMAIN		EXISTING TO REMAIN	×		
· <u> </u>	3' - 0"			EXISTING TO REMAIN		EXISTING TO REMAIN	X		
	3' - 0" 5' - 6"			EXISTING TO REMAIN		EXISTING TO REMAIN N/A	×		
3A	15' <i>- 0</i> "		EXT GARAGE	PAINT TO REMAIN		N/A	X		
	3' - 0"	7' - 0"		EXISTING TO REMAIN		EXISTING TO REMAIN	X		REPAIR BROKEN GLASS
	6' - 0"			EXISTING TO REMAIN		N/A	X		
	3' - 0" 6' - 0"			EXISTING TO REMAIN		EXISTING TO REMAIN EXISTING TO REMAIN	×		
-	6' - 0"	<u> </u>		EXISTING TO REMAIN		EXISTING TO REMAIN	×		
	6' - 0"			EXISTING TO REMAIN		EXISTING TO REMAIN	X		
7A	3' - 0"			EXISTING TO REMAIN		EXISTING TO REMAIN	X		
7B 8A	3' - 0" 3' - 0"			EXISTING TO REMAIN		EXISTING TO REMAIN EXISTING TO REMAIN	×		
				EXISTING TO REMAIN		EXISTING TO REMAIN	X		
94	3' - O"	7' - 0"	EXT SMING	EXISTING TO REMAIN	HOLLOM METAL	TO MATCH EXISTING 2	× ;	X	REPACE DOOR FRAME AND GLASS
	30' - 0" 30' - 0"		EXT GARAGE EXT OVERHEAD STACKING	PAINT EXISTING TO REMAIN	METAL METAL	N/A 4	×		REPLACE MAN DOOR WITH NEW HM PAINT FINISH
0B				EXISTING TO REMAIN		N/A	X		THE PART OF THE PA
			EXT SMING	HOLLOW METAL		PAINT 2	,	×	NEW DOOR & FRAME
	30' - 0" 5' - 6"		EXT OVERHEAD STACKING EXT ROLLING	EXISTING TO REMAIN		N/A N/A	X		REMOVE DOOR AND INFILL
						137 / \			NEITO VE DOOR AND IN IEE
	30' - 0"	26' - 0"		EXISTING TO REMAIN	METAL	N/A	X		
-1A	30' - 0"	26' - 0"	EXT OVERHEAD STACKING	EXISTING TO REMAIN	METAL	N/A 4	×		REPLACE MAN DOOR WITH NEW HM PAINT FINISH
-1A -1B -1C	30' - 0" 15' - 0"	26' - 0" 15' - 0"	EXT OVERHEAD STACKING EXT OVERHEAD STACKING	EXISTING TO REMAIN EXISTING TO REMAIN	METAL METAL	N/A 4 N/A			
-1A -1B -1C -2A	30' - 0" 15' - 0" 4' - 0"	26' - 0" 15' - 0" 7' - 0"	EXT OVERHEAD STACKING EXT OVERHEAD STACKING EXT SWING	EXISTING TO REMAIN EXISTING TO REMAIN DEMO	METAL METAL DEMO	N/A 4 N/A DEMO	×		REPLACE MAN DOOR WITH NEW HM PAINT FINISH DOOR TO BE REMOVED, INFILL WALL
-1A -1B -1C	30' - 0" 15' - 0" 4' - 0" 12' - 0"	26' - 0" 15' - 0" 7' - 0" 8' - 0"	EXT OVERHEAD STACKING EXT OVERHEAD STACKING EXT SMING INT ROLLING	EXISTING TO REMAIN EXISTING TO REMAIN	METAL METAL DEMO METAL	N/A 4 N/A	X		
-1A -1B -1C -2A -2B -2C -3A	30' - 0" 15' - 0" 4' - 0" 12' - 0" 4' - 0" 3' - 0"	26' - 0" 15' - 0" 7' - 0" 8' - 0" 7' - 0"	EXT OVERHEAD STACKING EXT OVERHEAD STACKING EXT SMING INT ROLLING INT SMING EXT SMING	EXISTING TO REMAIN EXISTING TO REMAIN DEMO EXISTING TO REMAIN EXISTING TO REMAIN EXISTING TO REMAIN	METAL METAL DEMO METAL HOLLOW METAL HOLLOW METAL	N/A N/A DEMO N/A EXISTING TO REMAIN EXISTING TO REMAIN	X X X X		
1A 1B 1C 2A 2B 2C 3A	30' - 0" 15' - 0" 4' - 0" 12' - 0" 4' - 0" 3' - 0" 12' - 5"	26' - 0" 15' - 0" 7' - 0" 8' - 0" 7' - 0" 7' - 0" 12' - 0"	EXT OVERHEAD STACKING EXT OVERHEAD STACKING EXT SWING INT ROLLING INT SWING EXT SWING EXT SWING	EXISTING TO REMAIN EXISTING TO REMAIN DEMO EXISTING TO REMAIN EXISTING TO REMAIN EXISTING TO REMAIN EXISTING TO REMAIN	METAL METAL DEMO METAL HOLLOW METAL HOLLOW METAL METAL	N/A N/A DEMO N/A EXISTING TO REMAIN EXISTING TO REMAIN N/A	X X		
-1A -1B -1C -2A -2B -2C -3A	30' - 0" 15' - 0" 4' - 0" 12' - 0" 4' - 0" 3' - 0" 12' - 5"	26' - 0" 15' - 0" 7' - 0" 8' - 0" 7' - 0" 7' - 0" 12' - 0" 7' - 0"	EXT OVERHEAD STACKING EXT OVERHEAD STACKING EXT SWING INT ROLLING INT SWING EXT SWING EXT SWING EXT GARAGE EXT SWING	EXISTING TO REMAIN EXISTING TO REMAIN DEMO EXISTING TO REMAIN EXISTING TO REMAIN EXISTING TO REMAIN	METAL METAL DEMO METAL HOLLOW METAL HOLLOW METAL METAL HOLLOW METAL	N/A N/A DEMO N/A EXISTING TO REMAIN EXISTING TO REMAIN	X X X X		
11A 11B 11C 12A 12B 12C 13A 13B 13C 13D	30' - 0" 15' - 0" 4' - 0" 12' - 0" 4' - 0" 3' - 0" 12' - 5" 3' - 0" 3' - 0" 3' - 0"	26' - 0" 15' - 0" 7' - 0" 8' - 0" 7' - 0" 7' - 0" 12' - 0" 7' - 0" 7' - 0" 7' - 0"	EXT OVERHEAD STACKING EXT OVERHEAD STACKING EXT SWING INT ROLLING INT SWING EXT SWING EXT GARAGE EXT SWING EXT SWING EXT SWING INT SWING	EXISTING TO REMAIN EXISTING TO REMAIN DEMO EXISTING TO REMAIN	METAL METAL DEMO METAL HOLLOW METAL HOLLOW METAL HOLLOW METAL HOLLOW METAL HOLLOW METAL HOLLOW METAL	N/A N/A DEMO N/A EXISTING TO REMAIN EXISTING TO REMAIN N/A EXISTING TO REMAIN EXISTING TO REMAIN EXISTING TO REMAIN EXISTING TO REMAIN	X X X X X X X X X X X		
11A 11B 11C 12A 12B 12C 13A 13B 13C 13D 14A	30' - 0" 15' - 0" 4' - 0" 12' - 0" 4' - 0" 3' - 0" 12' - 5" 3' - 0" 3' - 0" 3' - 0" 3' - 0"	26' - 0" 15' - 0" 7' - 0" 8' - 0" 7' - 0" 12' - 0" 7' - 0" 7' - 0" 7' - 0" 7' - 0"	EXT OVERHEAD STACKING EXT OVERHEAD STACKING EXT SWING INT ROLLING INT SWING EXT SWING EXT GARAGE EXT SWING EXT SWING EXT SWING INT SWING INT SWING INT SWING	EXISTING TO REMAIN EXISTING TO REMAIN DEMO EXISTING TO REMAIN	METAL METAL DEMO METAL HOLLOW METAL HOLLOW METAL METAL HOLLOW METAL HOLLOW METAL HOLLOW METAL HOLLOW METAL HOLLOW METAL	N/A N/A DEMO N/A EXISTING TO REMAIN EXISTING TO REMAIN N/A EXISTING TO REMAIN	X		
11A 11B 11C 12A 12B 12C 13A 13B 13C 13D 14A	30' - 0" 15' - 0" 4' - 0" 12' - 0" 4' - 0" 3' - 0" 12' - 5" 3' - 0" 3' - 0" 3' - 0" 3' - 0" 3' - 0"	26' - 0" 15' - 0" 7' - 0" 8' - 0" 7' - 0" 12' - 0" 7' - 0" 7' - 0" 7' - 0" 7' - 0" 7' - 0" 7' - 0"	EXT OVERHEAD STACKING EXT OVERHEAD STACKING EXT SWING INT ROLLING INT SWING EXT SWING EXT SWING EXT SWING EXT SWING EXT SWING INT SWING INT SWING INT SWING INT SWING	EXISTING TO REMAIN EXISTING TO REMAIN DEMO EXISTING TO REMAIN	METAL METAL DEMO METAL HOLLOW METAL	N/A N/A DEMO N/A EXISTING TO REMAIN EXISTING TO REMAIN N/A EXISTING TO REMAIN	X		
1A 1B 1C 2A 2B 2C 3A 3B 3C 3D 4A 4B 5	30' - 0" 15' - 0" 4' - 0" 12' - 0" 4' - 0" 3' - 0" 12' - 5" 3' - 0" 3' - 0" 3' - 0" 3' - 0" 3' - 0"	26' - 0" 15' - 0" 7' - 0" 8' - 0" 7' - 0" 12' - 0" 7' - 0"	EXT OVERHEAD STACKING EXT OVERHEAD STACKING EXT SWING INT ROLLING INT SWING EXT SWING EXT SWING EXT SWING EXT SWING INT SWING INT SWING INT SWING INT SWING INT SWING INT SWING	EXISTING TO REMAIN EXISTING TO REMAIN DEMO EXISTING TO REMAIN	METAL METAL DEMO METAL HOLLOW METAL	N/A N/A DEMO N/A EXISTING TO REMAIN EXISTING TO REMAIN N/A EXISTING TO REMAIN	X		
11A 11B 11C 12A 12B 12C 13A 13B 13C 13D 14A 14B 15 16 17 18	30' - 0" 15' - 0" 4' - 0" 12' - 0" 4' - 0" 3' - 0" 12' - 5" 3' - 0" 3' - 0" 3' - 0" 3' - 0" 3' - 0" 3' - 0" 3' - 0" 3' - 0"	26' - 0" 15' - 0" 7' - 0" 8' - 0" 7' - 0" 12' - 0" 7' - 0" 7' - 0" 7' - 0" 7' - 0" 7' - 0" 7' - 0" 7' - 0" 7' - 0" 7' - 0" 7' - 0" 7' - 0" 7' - 0"	EXT OVERHEAD STACKING EXT OVERHEAD STACKING EXT SWING INT ROLLING INT SWING EXT SWING EXT GARAGE EXT SWING EXT SWING INT SWING	EXISTING TO REMAIN EXISTING TO REMAIN DEMO EXISTING TO REMAIN	METAL METAL DEMO METAL HOLLOW METAL	N/A N/A DEMO N/A EXISTING TO REMAIN EXISTING TO REMAIN N/A EXISTING TO REMAIN	X X X X X X X X X X X X X X X X X X X		
1A 1B 1C 2A 2B 2C 3A 3B 3C 3D 4A 4B 5 6	30' - 0" 15' - 0" 4' - 0" 12' - 0" 3' - 0" 12' - 5" 3' - 0" 3' - 0" 3' - 0" 3' - 0" 3' - 0" 3' - 0" 3' - 0" 3' - 0" 3' - 0" 3' - 0" 3' - 0" 3' - 0"	26' - 0" 15' - 0" 7' - 0" 8' - 0" 7' - 0" 12' - 0" 7' - 0" 7' - 0" 7' - 0" 7' - 0" 7' - 0" 7' - 0" 7' - 0" 7' - 0" 7' - 0" 7' - 0" 7' - 0" 7' - 0" 7' - 0"	EXT OVERHEAD STACKING EXT OVERHEAD STACKING EXT SWING INT ROLLING INT SWING EXT SWING EXT SWING EXT SWING EXT SWING INT SWING	EXISTING TO REMAIN EXISTING TO REMAIN DEMO EXISTING TO REMAIN	METAL METAL DEMO METAL HOLLOW METAL	N/A N/A DEMO N/A EXISTING TO REMAIN EXISTING TO REMAIN N/A EXISTING TO REMAIN	X X X X X X X X X X X X X X X X X X X		
1A 1B 1C 2A 2B 2C 3A 3B 3C 3D 4A 4B 5 6	30' - 0" 15' - 0" 4' - 0" 12' - 0" 4' - 0" 3' - 0" 12' - 5" 3' - 0" 3' - 0" 3' - 0" 3' - 0" 3' - 0" 3' - 0" 3' - 0" 3' - 0"	26' - 0" 15' - 0" 7' - 0" 8' - 0" 7' - 0" 12' - 0" 7' - 0" 7' - 0" 7' - 0" 7' - 0" 7' - 0" 7' - 0" 7' - 0" 7' - 0" 7' - 0" 7' - 0" 7' - 0" 7' - 0" 7' - 0" 7' - 0" 7' - 0" 7' - 0"	EXT OVERHEAD STACKING EXT OVERHEAD STACKING EXT SWING INT ROLLING INT SWING EXT SWING EXT GARAGE EXT SWING EXT SWING INT SWING	EXISTING TO REMAIN EXISTING TO REMAIN DEMO EXISTING TO REMAIN	METAL METAL DEMO METAL HOLLOW METAL	N/A N/A DEMO N/A EXISTING TO REMAIN EXISTING TO REMAIN N/A EXISTING TO REMAIN	X X X X X X X X X X X X X X X X X X X		
11A 11B 11C 12A 12B 12C 13A 13B 13C 13D 14A 14B 15 16 17 18 18 18 18 18 18 18 18 18 18 18 18 18	30' - 0" 15' - 0" 4' - 0" 12' - 0" 12' - 5" 3' - 0" 3' - 0" 3' - 0" 3' - 0" 3' - 0" 3' - 0" 3' - 0" 3' - 0" 3' - 0" 3' - 0" 3' - 0" 3' - 0" 3' - 0" 3' - 0" 3' - 0" 3' - 0" 3' - 0"	26' - 0" 15' - 0" 7' - 0" 8' - 0" 7' - 0" 12' - 0" 7' - 0" 7' - 0" 7' - 0" 7' - 0" 7' - 0" 7' - 0" 7' - 0" 7' - 0" 7' - 0" 7' - 0" 7' - 0" 7' - 0" 7' - 0" 7' - 0" 7' - 0" 7' - 0" 7' - 0" 7' - 0" 7' - 0"	EXT OVERHEAD STACKING EXT OVERHEAD STACKING EXT SWING INT ROLLING INT SWING EXT SWING EXT SWING EXT SWING EXT SWING INT SWING	EXISTING TO REMAIN EXISTING TO REMAIN DEMO EXISTING TO REMAIN	METAL METAL DEMO METAL HOLLOW METAL	N/A N/A DEMO N/A EXISTING TO REMAIN EXISTING TO REMAIN N/A EXISTING TO REMAIN	X X X X X X X X X X X X X X X X X X X		
11A 11B 11C 12A 12B 12C 13A 13B 13C 13D 14A 14B 15 16 17 18 18 19 19 19 19 19 19 19 19 19 19	30' - 0" 15' - 0" 4' - 0" 12' - 0" 12' - 5" 3' - 0"	26' - 0" 15' - 0" 7' - 0" 8' - 0" 7' - 0" 12' - 0" 7' - 0"	EXT OVERHEAD STACKING EXT OVERHEAD STACKING EXT SWING INT ROLLING INT SWING EXT SWING EXT GARAGE EXT SWING EXT SWING INT SWING	EXISTING TO REMAIN EXISTING TO REMAIN DEMO EXISTING TO REMAIN	METAL METAL DEMO METAL HOLLOW METAL	N/A N/A DEMO N/A EXISTING TO REMAIN EXISTING TO REMAIN N/A EXISTING TO REMAIN	X X X X X X X X X X X X X X X X X X X		
1A 1B 1C 2A 2B 2C 3A 3B 3C 3D 4A 4B 5 6 7 8 9 9 9 9 1 1 1 3A 3B	30' - 0" 15' - 0" 4' - 0" 12' - 0" 4' - 0" 12' - 5" 3' - 0"	26' - 0" 15' - 0" 7' - 0" 8' - 0" 7' - 0" 12' - 0" 7' - 0"	EXT OVERHEAD STACKING EXT OVERHEAD STACKING EXT SWING INT ROLLING INT SWING EXT SWING EXT SWING EXT SWING EXT SWING INT SWING	EXISTING TO REMAIN EXISTING TO REMAIN DEMO EXISTING TO REMAIN	METAL METAL DEMO METAL HOLLOW METAL	N/A N/A DEMO N/A EXISTING TO REMAIN EXISTING TO REMAIN N/A EXISTING TO REMAIN	X X X X X X X X X X X X X X X X X X X		
1A 1B 1C 2A 2B 2C 3A 3B 3C 3D 4A 4B 55 66 7 8 8 9 8 6 6 15 3A 3B 3	30' - 0" 15' - 0" 4' - 0" 12' - 0" 12' - 5" 3' - 0"	26' - 0" 15' - 0" 7' - 0" 8' - 0" 7' - 0" 12' - 0" 7' - 0"	EXT OVERHEAD STACKING EXT OVERHEAD STACKING EXT SWING INT ROLLING INT SWING EXT SWING EXT SWING EXT SWING EXT SWING INT SWING	EXISTING TO REMAIN EXISTING TO REMAIN DEMO EXISTING TO REMAIN	METAL METAL DEMO METAL HOLLOW METAL	N/A N/A DEMO N/A EXISTING TO REMAIN EXISTING TO REMAIN N/A EXISTING TO REMAIN	X X X X X X X X X X X X X X X X X X X		
11A	30' - 0" 15' - 0" 4' - 0" 12' - 0" 12' - 5" 3' - 0"	26' - 0" 15' - 0" 7' - 0" 8' - 0" 7' - 0" 12' - 0" 7' - 0"	EXT OVERHEAD STACKING EXT OVERHEAD STACKING EXT SWING INT ROLLING INT SWING EXT SWING EXT SWING EXT SWING EXT SWING INT SWING	EXISTING TO REMAIN EXISTING TO REMAIN DEMO EXISTING TO REMAIN	METAL METAL DEMO METAL HOLLOW METAL	N/A N/A DEMO N/A EXISTING TO REMAIN EXISTING TO REMAIN N/A EXISTING TO REMAIN	X X X X X X X X X X X X X X X X X X X		
1A 1B 1C 2A 2B 2C 3A 3B 3C 3D 4A 4B 55 6 7 8 9 9 9 9 9 9 9 9 9 9 9 9 9 9 9 9 9 9	30' - 0" 15' - 0" 4' - 0" 12' - 0" 4' - 0" 12' - 5" 3' - 0"	26' - 0" 15' - 0" 7' - 0" 8' - 0" 7' - 0" 12' - 0" 7' - 0"	EXT OVERHEAD STACKING EXT OVERHEAD STACKING EXT SWING INT ROLLING INT SWING EXT SWING EXT SWING EXT SWING EXT SWING INT SWING	EXISTING TO REMAIN EXISTING TO REMAIN DEMO EXISTING TO REMAIN	METAL METAL DEMO METAL HOLLOW METAL	N/A N/A DEMO N/A EXISTING TO REMAIN EXISTING TO REMAIN N/A EXISTING TO REMAIN	X X X X X X X X X X X X X X X X X X X		
11A	30' - 0" 15' - 0" 4' - 0" 12' - 0" 12' - 5" 3' - 0"	26' - 0" 15' - 0" 7' - 0" 8' - 0" 7' - 0" 12' - 0" 7' - 0"	EXT OVERHEAD STACKING EXT OVERHEAD STACKING EXT SWING INT ROLLING INT SWING EXT SWING EXT SWING EXT SWING EXT SWING INT SWING	EXISTING TO REMAIN EXISTING TO REMAIN DEMO EXISTING TO REMAIN	METAL METAL DEMO METAL HOLLOW METAL	N/A N/A DEMO N/A EXISTING TO REMAIN EXISTING TO REMAIN N/A EXISTING TO REMAIN	X X X X X X X X X X X X X X X X X X X		
1A 1B 1C 2A 2B 2C 3A 3B 3C 3D 4A 4B 55 6 7 8 9 9 9 9 9 9 9 9 1	30' - 0" 15' - 0" 4' - 0" 12' - 0" 12' - 5" 3' - 0"	26' - 0" 15' - 0" 7' - 0" 8' - 0" 7' - 0" 12' - 0" 7' - 0"	EXT OVERHEAD STACKING EXT OVERHEAD STACKING EXT SWING INT ROLLING INT SWING EXT SWING EXT SWING EXT SWING EXT SWING INT SWING	EXISTING TO REMAIN EXISTING TO REMAIN DEMO EXISTING TO REMAIN	METAL METAL DEMO METAL HOLLOW METAL	N/A N/A DEMO N/A EXISTING TO REMAIN	X X X X X X X X X X X X X X X X X X X		
1A 1B 1C 2A 2B 2C 3A 3B 3C 3D 4A 4B 5 6 7 8 9 9 9 9 9 9 9 9 9 9 9 9 9 9 9 9 9 9	30' - 0" 15' - 0" 4' - 0" 12' - 0" 12' - 5" 3' - 0"	26' - 0" 15' - 0" 7' - 0" 8' - 0" 7' - 0" 12' - 0" 7' - 0"	EXT OVERHEAD STACKING EXT OVERHEAD STACKING EXT SWING INT ROLLING INT SWING EXT SWING EXT SWING EXT SWING EXT SWING INT SWING	EXISTING TO REMAIN EXISTING TO REMAIN DEMO EXISTING TO REMAIN	METAL METAL DEMO METAL HOLLOW METAL	N/A N/A DEMO N/A EXISTING TO REMAIN EXISTING TO REMAIN N/A EXISTING TO REMAIN	X X X X X X X X X X X X X X X X X X X		
1A	30' - 0" 15' - 0" 4' - 0" 12' - 0" 12' - 5" 3' - 0"	26' - 0" 15' - 0" 7' - 0" 8' - 0" 7' - 0" 12' - 0" 7' - 0"	EXT OVERHEAD STACKING EXT OVERHEAD STACKING EXT SWING INT ROLLING INT SWING EXT SWING EXT SWING EXT SWING EXT SWING INT SWING	EXISTING TO REMAIN EXISTING TO REMAIN DEMO EXISTING TO REMAIN	METAL METAL DEMO METAL HOLLOW METAL	N/A DEMO N/A EXISTING TO REMAIN	X X X X X X X X X X X X X X X X X X X		
1A	30' - 0" 15' - 0" 4' - 0" 12' - 0" 12' - 5" 3' - 0"	26' - 0" 15' - 0" 7' - 0" 8' - 0" 7' - 0" 12' - 0" 7' - 0"	EXT OVERHEAD STACKING EXT OVERHEAD STACKING EXT SWING INT ROLLING INT SWING EXT SWING EXT SWING EXT SWING EXT SWING INT SWING	EXISTING TO REMAIN EXISTING TO REMAIN DEMO EXISTING TO REMAIN	METAL METAL DEMO METAL HOLLOW METAL	N/A N/A DEMO N/A EXISTING TO REMAIN EXISTING TO REMAIN N/A EXISTING TO REMAIN	X X X X X X X X X X X X X X X X X X X		
1A	30' - 0" 15' - 0" 4' - 0" 12' - 0" 12' - 5" 3' - 0"	26' - 0" 15' - 0" 7' - 0" 8' - 0" 7' - 0" 12' - 0" 7' - 0"	EXT OVERHEAD STACKING EXT OVERHEAD STACKING EXT SWING INT ROLLING INT SWING EXT SWING EXT SWING EXT SWING EXT SWING INT SWING	EXISTING TO REMAIN EXISTING TO REMAIN DEMO EXISTING TO REMAIN	METAL METAL DEMO METAL HOLLOW METAL	N/A N/A DEMO N/A EXISTING TO REMAIN	X X X X X X X X X X X X X X X X X X X		
1A	30' - 0" 15' - 0" 4' - 0" 12' - 0" 12' - 5" 3' - 0" 12' - 5" 3' - 0"	26' - 0" 15' - 0" 7' - 0" 8' - 0" 7' - 0" 12' - 0" 7' - 0"	EXT OVERHEAD STACKING EXT OVERHEAD STACKING EXT SWING INT ROLLING INT SWING EXT SWING EXT SWING EXT SWING EXT SWING INT SWING	EXISTING TO REMAIN	METAL METAL DEMO METAL HOLLOW METAL	N/A N/A DEMO N/A EXISTING TO REMAIN	X X X X X X X X X X X X X X X X X X X		
1A 1B 1C 2A 2B 2C 3A 3B 3C 3D 4A B 5 6 7 8 9 9 9 9 1 1 1 1 1 1 1 1 1 1 1 1 1 1 1	30' - 0" 15' - 0" 4' - 0" 12' - 0" 12' - 5" 3' - 0"	26' - 0" 15' - 0" 7' - 0" 8' - 0" 7' - 0" 12' - 0" 7' - 0"	EXT OVERHEAD STACKING EXT OVERHEAD STACKING EXT SWING INT ROLLING INT SWING EXT SWING EXT SWING EXT SWING EXT SWING INT SWING	EXISTING TO REMAIN EXISTING TO REMAIN DEMO EXISTING TO REMAIN	METAL METAL DEMO METAL HOLLOW METAL	N/A N/A DEMO N/A EXISTING TO REMAIN	X X X X X X X X X X X X X X X X X X X		
1A	30' - 0" 15' - 0" 4' - 0" 12' - 0" 12' - 5" 3' - 0" 12' - 5" 3' - 0"	26' - 0" 15' - 0" 7' - 0" 8' - 0" 7' - 0" 12' - 0" 7' - 0"	EXT OVERHEAD STACKING EXT OVERHEAD STACKING EXT SWING INT ROLLING INT SWING EXT SWING EXT SWING EXT SWING EXT SWING EXT SWING INT SWING	EXISTING TO REMAIN EXISTING TO REMAIN DEMO EXISTING TO REMAIN	METAL METAL DEMO METAL HOLLOW METAL	N/A DEMO N/A EXISTING TO REMAIN	X X X X X X X X X X X X X X X X X X X		DOOR TO BE REMOVED, INFILL WALL
1A	30' - 0" 15' - 0" 4' - 0" 12' - 0" 12' - 5" 3' - 0" 12' - 5" 3' - 0"	26' - 0" 15' - 0" 7' - 0" 8' - 0" 7' - 0" 12' - 0" 7' - 0"	EXT OVERHEAD STACKING EXT OVERHEAD STACKING EXT SWING INT ROLLING INT SWING EXT SWING EXT SWING EXT SWING EXT SWING EXT SWING INT SWING	EXISTING TO REMAIN EXISTING TO REMAIN DEMO EXISTING TO REMAIN	METAL METAL DEMO METAL HOLLOW METAL	N/A DEMO N/A EXISTING TO REMAIN	X X X X X X X X X X X X X X X X X X X		
1A	30' - 0" 15' - 0" 4' - 0" 12' - 0" 12' - 5" 3' - 0"	26' - 0" 15' - 0" 7' - 0" 8' - 0" 7' - 0" 12' - 0" 7' - 0"	EXT OVERHEAD STACKING EXT OVERHEAD STACKING EXT SWING INT ROLLING INT SWING EXT SWING EXT SWING EXT SWING EXT SWING EXT SWING INT SWING	EXISTING TO REMAIN EXISTING TO REMAIN DEMO EXISTING TO REMAIN	METAL METAL DEMO METAL HOLLOW METAL	N/A DEMO N/A EXISTING TO REMAIN	X X X X X X X X X X X X X X X X X X X		DOOR TO BE REMOVED, INFILL WALL
1A 1B 1C 2A 2B 2C 3A 3B 3C 3A 3D 4A 4B 5 6 7 8 9 0 0 1 2 2 3 4 5 6 6 7 9 0 0 B 1 2 4 5 5 6 6 7 9 0 0 B 1 2 2 4 5 5 6 6 7 9 0 0 C 1 2 2 4 5 5 6 6 7 9 0 0 C 1 2 2 4 5 5 6 6 7 9 0 0 C 1 2 2 4 5 5 6 6 7 9 0 0 C 1 2 2 4 5 5 6 6 7 9 0 0 C 1 2 2 4 5 5 6 6 7 9 0 0 C 1 2 2 4 5 5 6 6 7 9 0 C 1 2 2 4 5 5 6 6 7 9 0 C 1 2 2 4 5 5 6 6 7 9 0 C 1 2 2 4 5 5 6 6 7 9 0 C 1 2 2 4 5 5 6 6 7 9 0 C 1 2 2 4 5 5 6 6 7 9 0 C 1 2 2 4 5 5 6 6 7 9 0 C 1 2 2 4 5 5 6 6 7 9 0 C 1 2 2 4 5 5 6 6 7 9 0 C 1 2 2 4 5 5 6 6 7 9 0 C 1 2 2 4 5 5 6 6 6 7 9 0 C 1 2 2 4 5 5 6 6 6 7 9 0 C 1 2 2 4 5 5 6 6 6 7 9 0 C 1 2 2 4 5 5 6 6 6 7 9 0 C 1 2 2 4 5 5 6 6 6 7 9 0 C 1 2 2 4 5 5 6 6 6 7 9 0 C 1 2 2 4 5 5 6 6 6 7 9 0 C 1 2 2 4 5 5 6 6 6 7 9 0 C 1 2 2 4 5 5 6 6 6 7 9 0 C 1 2 2 4 5 5 6 6 6 7 9 0 C 1 2 2 4 5 5 6 6 6 7 9 0 C 1 2 2 4 5 5 6 6 6 7 9 0 C 1 2 2 4 5 5 6 6 6 7 9 0 C 1 2 2 4 5 5 6 6 6 7 9 0 C 1 2 2 4 5 5 6 6 6 7 9 0 C 1 2 2 4 5 5 6 6 6 6 7 9 0 C 1 2 2 4 5 6 6 6 6 7 9 0 C 1 2 2 4 5 6 6 6 7 9 0 C 1 2 2 4 5 6 6 6 6 7 9 0 C 1 2 2 4 5 6 6 6 6 7 9 0 C 1 2 2 4 5 6 6 6 6 7 9 0 C 1 2 2 4 5 6 6 6 6 7 9 0 C 1 2 2 4 5 6 6 6 7 0 C 1 2 2 4 5 6 6 6 6 7 0 C 1 2 2 4 6	30' - 0" 15' - 0" 4' - 0" 12' - 0" 12' - 5" 3' - 0" 12' - 5" 3' - 0"	26' - 0" 15' - 0" 7' - 0" 8' - 0" 7' - 0" 12' - 0" 7' - 0"	EXT OVERHEAD STACKING EXT OVERHEAD STACKING EXT SWING INT ROLLING INT SWING EXT SWING EXT SWING EXT SWING EXT SWING EXT SWING EXT SWING INT SWING	EXISTING TO REMAIN EXISTING TO REMAIN DEMO EXISTING TO REMAIN	METAL METAL DEMO METAL HOLLOW METAL	N/A DEMO N/A EXISTING TO REMAIN	X X X X X X X X X X X X X X X X X X X		DOOR TO BE REMOVED, INFILL WALL
1A 1B 1C 2A 2B 2C 3A 3B 3C 3D 4A 4B 5 6 7 8 9 0 0 1 3A 3B 3C 3D 4A 5 6 7 8 9 0 0 1 2 4 5 6 6 7 8 9 0 0 0 1 2 4 5 6 6 7	30' - 0" 15' - 0" 12' - 0" 12' - 0" 12' - 5" 3' - 0" 12' - 5" 3' - 0"	26' - 0" 15' - 0" 7' - 0" 8' - 0" 7' - 0" 12' - 0" 7' - 0"	EXT OVERHEAD STACKING EXT OVERHEAD STACKING EXT SWING INT ROLLING INT SWING EXT SWING EXT SWING EXT SWING EXT SWING EXT SWING EXT SWING INT SWING	EXISTING TO REMAIN	METAL METAL DEMO METAL HOLLOW METAL	N/A DEMO N/A EXISTING TO REMAIN	X X X X X X X X X X X X X X X X X X X		DOOR TO BE REMOVED, INFILL WALL REPAIR BROKEN GLASS
1A 1B 1C 2A 2B 2C 3A 3B 3C 3A 3D 4A 4B 5 6 7 8 9 0 0 1 1 8 9 0 0 1 9 2 8 9 1 9 0 0 1 9 2 9 1 9 0 0 0 1 9 2 9 1 9 0 0 0 1 9 2 9 1 9 0 0 0 1 9 2 9 1 9 1 9 1 9 1 9 1 9 1 9 1 9 1 9	30' - 0" 15' - 0" 12' - 0" 12' - 0" 12' - 5" 3' - 0" 12' - 5" 3' - 0"	26' - 0" 15' - 0" 7' - 0" 8' - 0" 7' - 0" 12' - 0" 7' - 0"	EXT OVERHEAD STACKING EXT OVERHEAD STACKING EXT SWING INT ROLLING INT SWING EXT SWING EXT SWING EXT SWING EXT SWING EXT SWING EXT SWING INT SWING	EXISTING TO REMAIN EXISTING TO REMAIN DEMO EXISTING TO REMAIN	METAL METAL DEMO METAL HOLLOW METAL	N/A DEMO N/A EXISTING TO REMAIN	X X X X X X X X X X X X X X X X X X X		DOOR TO BE REMOVED, INFILL WALL
1A	30' - 0" 15' - 0" 4' - 0" 12' - 0" 12' - 5" 3' - 0"	26' - 0" 15' - 0" 7' - 0" 8' - 0" 7' - 0" 12' - 0" 7' - 0"	EXT OVERHEAD STACKING EXT OVERHEAD STACKING EXT SMING INT ROLLING INT SMING EXT SMING EXT SMING EXT SMING EXT SMING EXT SMING EXT SMING INT SMING	EXISTING TO REMAIN EXISTING TO REMAIN DEMO EXISTING TO REMAIN EXISTING	METAL METAL DEMO METAL HOLLOW METAL	N/A DEMO N/A DEMO N/A EXISTING TO REMAIN	X X X X X X X X X X X X X X X X X X X	×	DOOR TO BE REMOVED, INFILL WALL REPAIR BROKEN GLASS
1A 1B 1C 2A 2B 2C 3A 3B 3C 3A	30' - 0" 15' - 0" 4' - 0" 12' - 0" 12' - 5" 3' - 0"	26' - 0" 15' - 0" 7' - 0" 8' - 0" 7' - 0" 12' - 0" 7' - 0"	EXT OVERHEAD STACKING EXT OVERHEAD STACKING EXT SWING INT ROLLING INT SWING EXT SWING EXT SWING EXT SWING EXT SWING EXT SWING INT SWING	EXISTING TO REMAIN EXISTING TO REMAIN DEMO EXISTING TO REMAIN	METAL METAL DEMO METAL HOLLOW METAL	N/A DEMO N/A DEMO N/A EXISTING TO REMAIN	X X X X X X X X X X X X X X X X X X X	×	DOOR TO BE REMOVED, INFILL WALL REPAIR BROKEN GLASS RE-INSTALL HARDWARE
1A 1B 1C 2A 3B 3C 3A 3B 3C	30' - 0" 15' - 0" 12' - 0" 12' - 0" 12' - 0" 12' - 5" 3' - 0"	26' - 0" 15' - 0" 7' - 0" 8' - 0" 7' - 0" 12' - 0" 7' - 0"	EXT OVERHEAD STACKING EXT OVERHEAD STACKING EXT SWING INT ROLLING INT SWING EXT SWING EXT SWING EXT SWING EXT SWING EXT SWING INT SWING	EXISTING TO REMAIN EXISTING TO REMAIN DEMO EXISTING TO REMAIN EXISTING	METAL METAL DEMO METAL HOLLOW METAL	N/A N/A DEMO N/A EXISTING TO REMAIN EXIST	X X X X X X X X X X X X X X X X X X X	×	DOOR TO BE REMOVED, INFILL WALL REPAIR BROKEN GLASS RE-INSTALL HARDWARE
1A	30' - 0" 15' - 0" 4' - 0" 12' - 0" 12' - 5" 3' - 0" 12' - 5" 3' - 0"	26' - 0" 15' - 0" 7' - 0" 8' - 0" 7' - 0" 12' - 0" 7' - 0"	EXT OVERHEAD STACKING EXT OVERHEAD STACKING EXT SWING INT ROLLING INT SWING EXT SWING EXT SWING EXT SWING EXT SWING EXT SWING INT SWING	EXISTING TO REMAIN EXISTING TO REMAIN DEMO EXISTING TO REMAIN EXISTING	METAL METAL DEMO METAL HOLLOW METAL	N/A DEMO N/A DEMO N/A EXISTING TO REMAIN	X X X X X X X X X X X X X X X X X X X	×	DOOR TO BE REMOVED, INFILL WALL REPAIR BROKEN GLASS RE-INSTALL HARDWARE
1A	30' - 0" 15' - 0" 12' - 0" 12' - 0" 12' - 5" 3' - 0" 12' - 5" 3' - 0"	26' - 0" 15' - 0" 7' - 0" 8' - 0" 7' - 0" 12' - 0" 7' - 0"	EXT OVERHEAD STACKING EXT OVERHEAD STACKING EXT SWING INT ROLLING INT SWING EXT SWING EXT SWING EXT SWING EXT SWING EXT SWING INT SWING	EXISTING TO REMAIN EXISTING TO REMAIN DEMO EXISTING TO REMAIN	METAL METAL DEMO METAL HOLLOW METAL	N/A DEMO N/A EXISTING TO REMAIN EXISTING T	X X X X X X X X X X X X X X X X X X X	×	DOOR TO BE REMOVED, INFILL WALL REPAIR BROKEN GLASS RE-INSTALL HARDWARE
1A	30' - 0" 15' - 0" 4' - 0" 12' - 0" 12' - 5" 3' - 0" 12' - 5" 3' - 0"	26' - 0" 15' - 0" 7' - 0" 8' - 0" 7' - 0" 12' - 0" 7' - 0"	EXT OVERHEAD STACKING EXT OVERHEAD STACKING EXT SWING INT ROLLING INT SWING EXT SWING EXT SWING EXT SWING EXT SWING EXT SWING EXT SWING INT SWING	EXISTING TO REMAIN EXISTING TO REMAIN DEMO EXISTING TO REMAIN	METAL METAL DEMO METAL HOLLOW METAL	N/A N/A DEMO N/A EXISTING TO REMAIN EXIST	X X X X X X X X X X X X X X X X X X X	×	DOOR TO BE REMOVED, INFILL WALL REPAIR BROKEN GLASS RE-INSTALL HARDWARE REPLACE DOOR & HARDWARE, EXISTING FRAME TO REMAIN
1A 1B 1C 2A 3B 3C 3A	30' - 0" 15' - 0" 4' - 0" 12' - 0" 12' - 0" 12' - 5" 3' - 0" 12' - 5" 3' - 0"	26' - 0" 15' - 0" 7' - 0" 8' - 0" 7' - 0" 12' - 0" 7' - 0"	EXT OVERHEAD STACKING EXT OVERHEAD STACKING EXT SWING INT ROLLING INT SWING EXT SWING EXT SWING EXT SWING EXT SWING EXT SWING EXT SWING INT SWING	EXISTING TO REMAIN EXISTING TO REMAIN DEMO EXISTING TO REMAIN	METAL METAL DEMO METAL HOLLOW METAL	N/A DEMO N/A EXISTING TO REMAIN EXISTING T	X X X X X X X X X X X X X X X X X X X	×	DOOR TO BE REMOVED, INFILL WALL REPAIR BROKEN GLASS RE-INSTALL HARDWARE REPLACE DOOR & HARDWARE, EXISTING FRAME TO REMAIN
1A 1B 1C 2A 3B 3C 3A	30' - 0" 15' - 0" 12' - 0" 12' - 0" 12' - 0" 12' - 5" 3' - 0"	26' - 0" 15' - 0" 7' - 0" 8' - 0" 7' - 0" 12' - 0" 7' - 0"	EXT OVERHEAD STACKING EXT OVERHEAD STACKING EXT SWING INT ROLLING INT SWING EXT SWING EXT SWING EXT SWING EXT SWING EXT SWING INT SWING	EXISTING TO REMAIN EXISTING TO REMAIN DEMO EXISTING TO REMAIN	METAL METAL DEMO METAL HOLLOW METAL	N/A N/A DEMO N/A EXISTING TO REMAIN EXIST	X X X X X X X X X X X X X X X X X X X	×	DOOR TO BE REMOVED, INFILL WALL REPAIR BROKEN GLASS RE-INSTALL HARDWARE REPLACE DOOR & HARDWARE, EXISTING FRAME TO REMAIN


DOOR SCHEDULE

* IF REPLACED PROVIDE TEMPERED GLASS AS REQUIRED BY IBC CHAPTER 24

STOP, MORTISE LOCK EXIT DEVICE

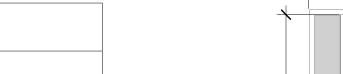

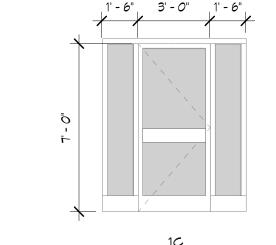

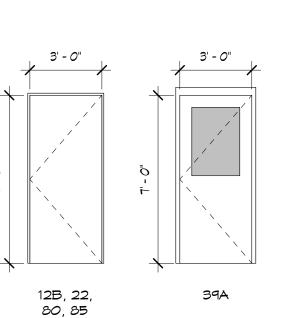


+ ASSOCIATES ENGINEERING

564 E. SECOND AVE, STE 201 DURANGO, CO 81301 (970) 259 - 7494 FAX (970) 259 - 7492 262 PAGOSA STREET, STE. 200 PAGOSA SPRINGS, CO 81147 RA-AE.COM

EXPRESSLY RESERVES THE COMMON LAW COPYRIGHT AND OTHER PROPERTY RIGHTS IN THESE PLANS. THESE PLANS ARE NOT TO BE CHANGED OR COPIED IN ANY FORM OR MANNER WHATSOEVER NOR ARE THEY TO BE ASSIGNED TO ANY THIRD PARTY WITHOUT FIRST OBTAINING WRITTEN PERMISSION AND CONSENT OF THE ARCHITECT OF RECORD.

THE USE OF THESE PLANS AND SPECIFICATIONS SHALL BE RESTRICTED TO THE ORIGINAL SITE FOR WHICH
THEY WERE PREPARED AND PUBLICATION TEHREOF IS EXPRESSLY LIMITED TO SUCH USE. FEDERAL LAW PROHIBITS THE REPRODUCTION, DISPLAY, SALE OR EXPRESS WRITTEN CONSENT OF RA+A ARCHITECTS, P.C.

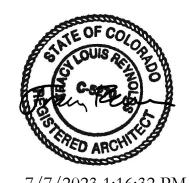

7/7/2023 1:16:32 PM


2023-05-15 DRAWN BY: Author


ISSUE RECORD: 2023-02-17 100% SD 2023-03-31 DD 2023-05-15 CD


REVISIONS:

DOOR & WINDOW

SCHEDULES

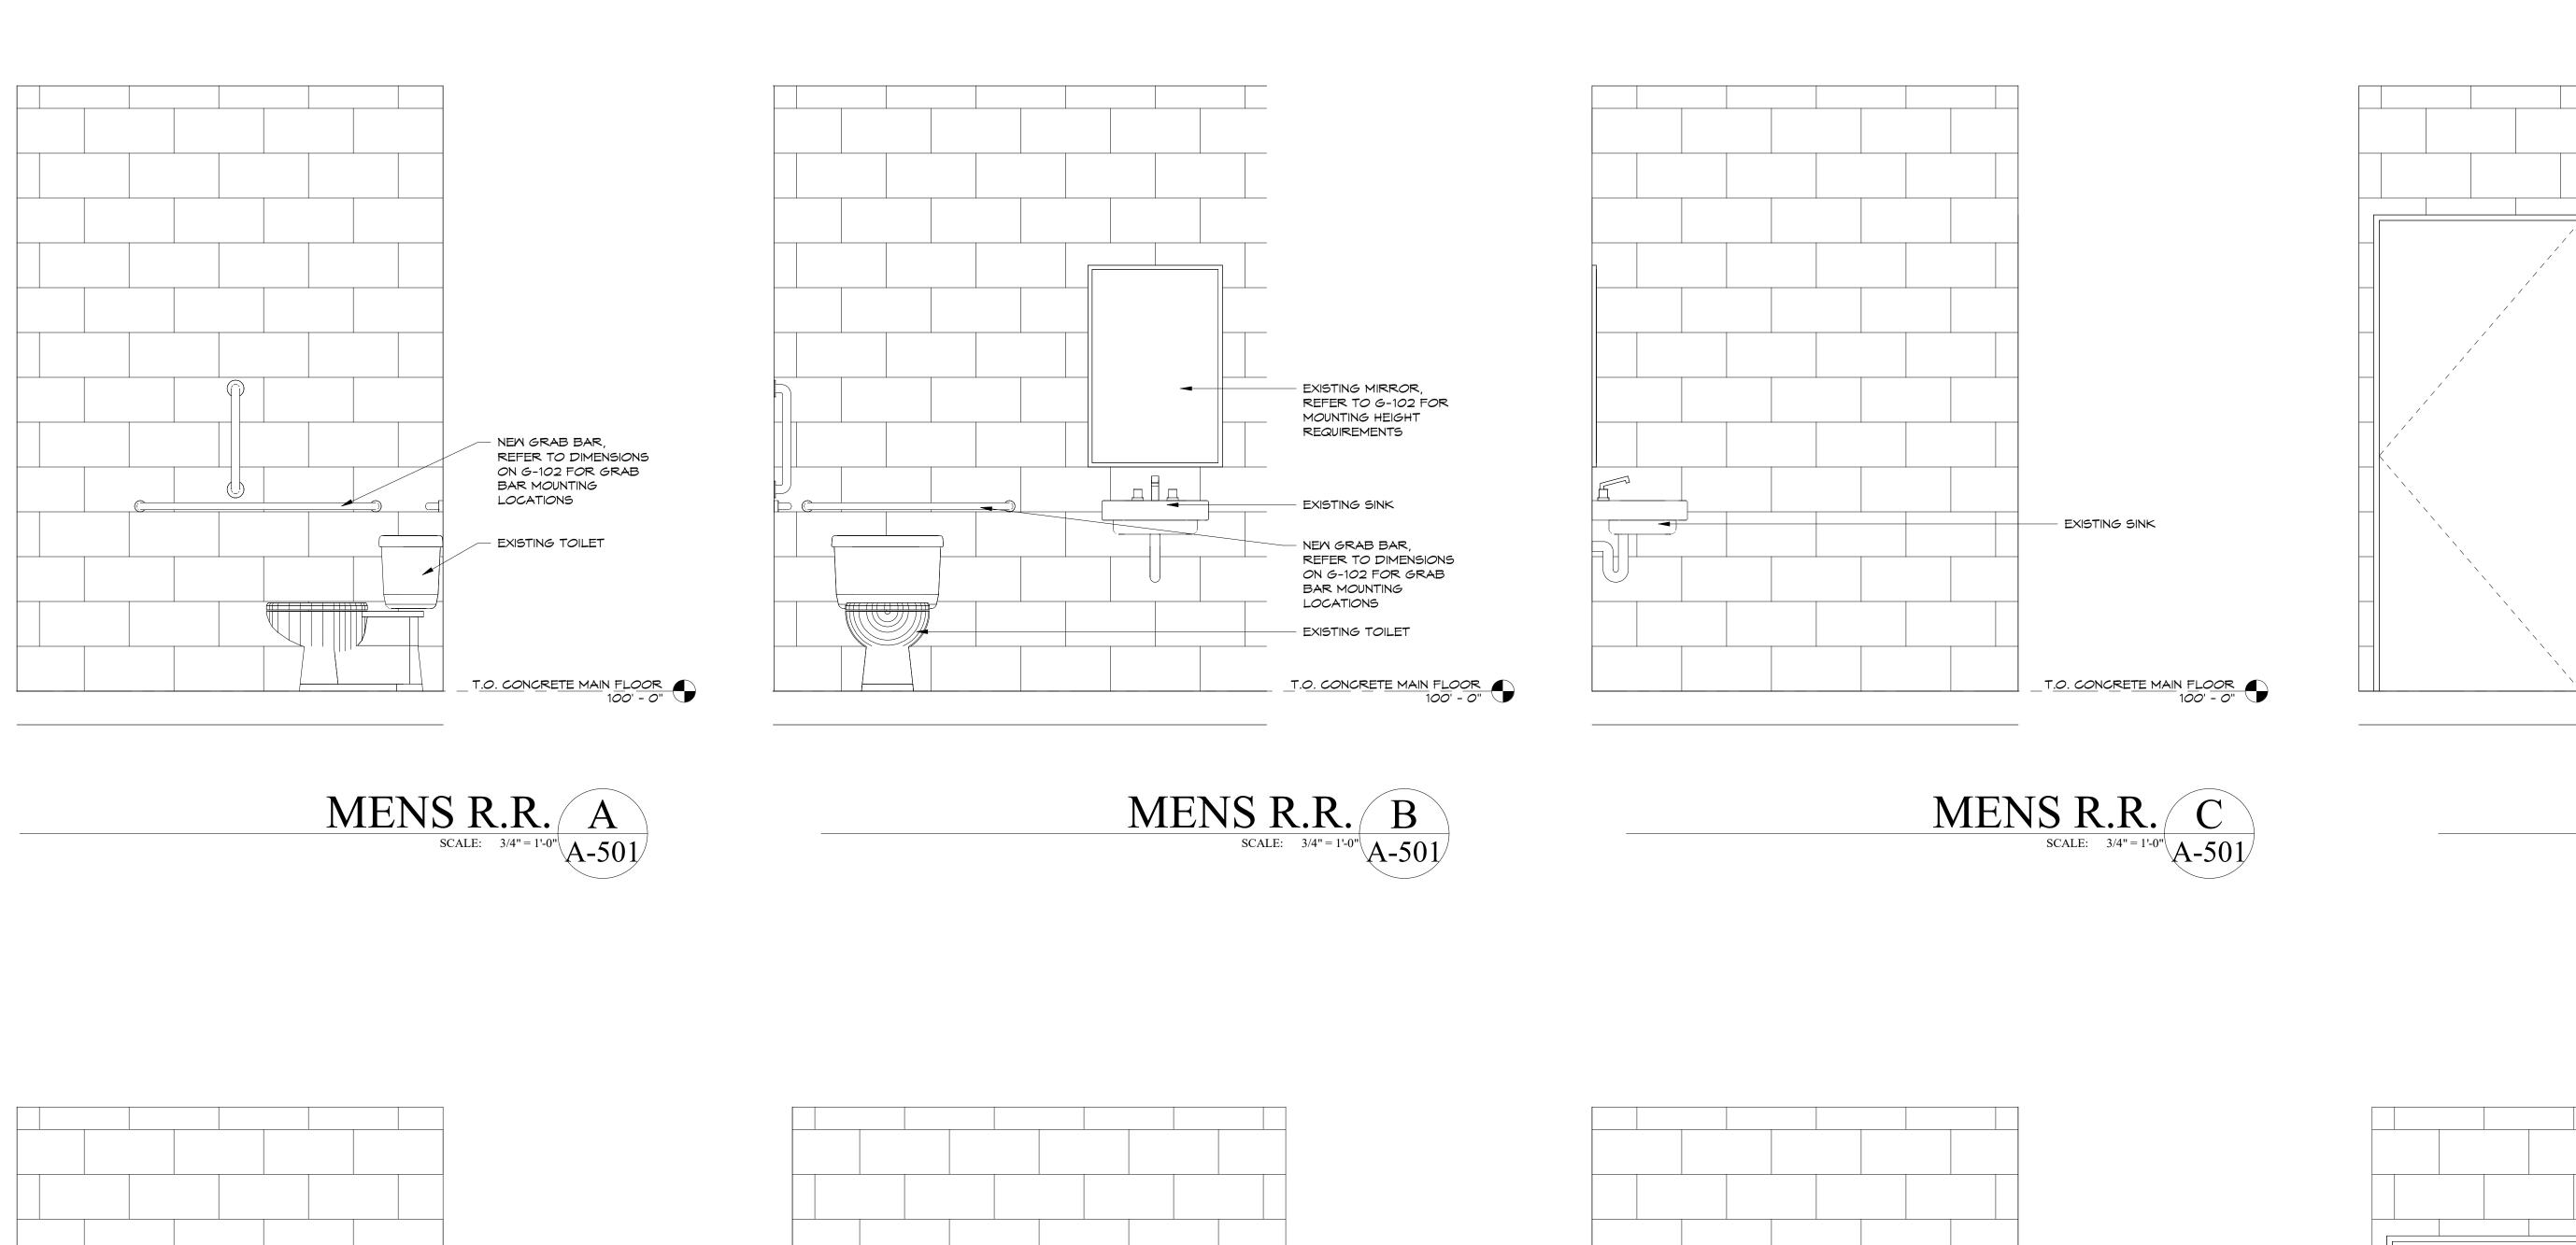

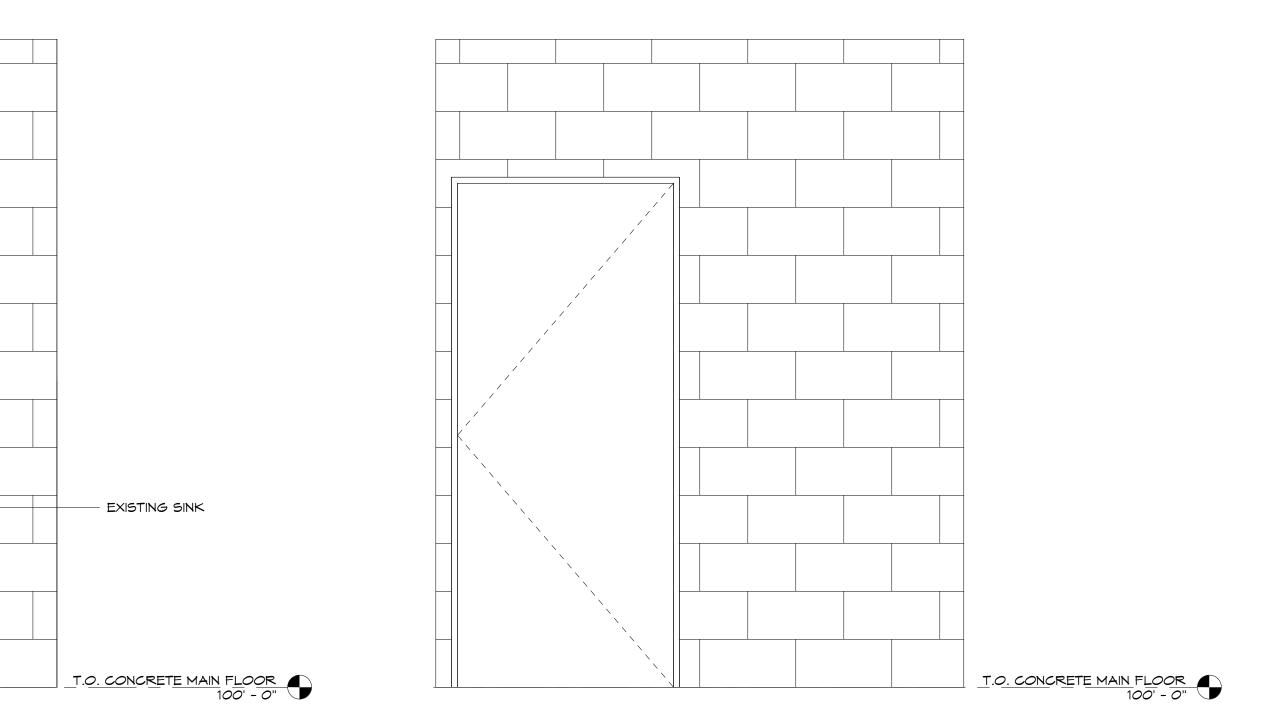

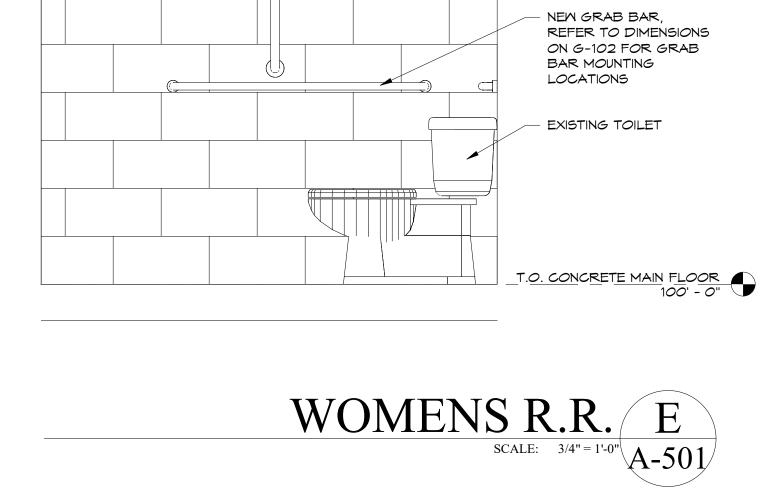



- EXISTING MIRROR, REFER TO G-102 FOR MOUNTING HEIGHT REQUIREMENTS

- NEW GRAB BAR, REFER TO DIMENSIONS ON G-102 FOR GRAB BAR MOUNTING LOCATIONS

T.O. CONCRETE MAIN FLOOR 100' - 0"

- EXISTING TOILET

EXISTING SINK





JOB. NO.: DATE: 2023-05-15 DRAWN BY: Author

SAN JUAN COUNTY INDUSTRIAI PARK

161 RD 1130 PLATA, NEW MEXICO 87418

REYNOLDS ASH

+ ASSOCIATES

ARCHITECTURE

ENGINEERING

564 E. SECOND AVE, STE 201 DURANGO, CO 81301 (970) 259 - 7494 FAX (970) 259 - 7492

262 PAGOSA STREET, STE. 200 P.O. BOX 96 PAGOSA SPRINGS, CO 81147

RA-AE.COM

REYNOLDS ASH + ASSOCIATES, P.C.

REYNOLDS ASH + ASSOCIATES, P.C.

EXPRESSLY RESERVES THE COMMON LAW COPYRIGHT
AND OTHER PROPERTY RIGHTS IN THESE PLANS. THESE
PLANS ARE NOT TO BE CHANGED OR COPIED IN ANY
FORM OR MANNER WHATSOEVER NOR ARE THEY TO BE
ASSIGNED TO ANY THIRD PARTY WITHOUT FIRST
OBTAINING WRITTEN PERMISSION AND CONSENT OF
THE ARCHITECT OF RECORD.

THE USE OF THESE PLANS AND SPECIFICATIONS SHALL BE RESTRICTED TO THE ORIGINAL SITE FOR WHICH THEY WERE PREPARED AND PUBLICATION TEHREOF IS EXPRESSLY LIMITED TO SUCH USE. FEDERAL LAW PROHIBITS THE REPRODUCTION, DISPLAY, SALE OR OTHER DISPOSITION OF THIS DOCUMENT WITHOUT THE EXPRESS WRITTEN CONSENT OF RA+A ARCHITECTS, P.C.

7/7/2023 1:16:33 PM

T.O. CONCRETE MAIN FLOOR 100' - 0"


MENS R.R. D
SCALE: 3/4" = 1'-0" A-501

ISSUE RECORD: 2023-02-17 100% SD 2023-03-31 DD 2023-05-15 CD

REVISIONS:

INTERIOR ELEVATIONS

ROAD 1120

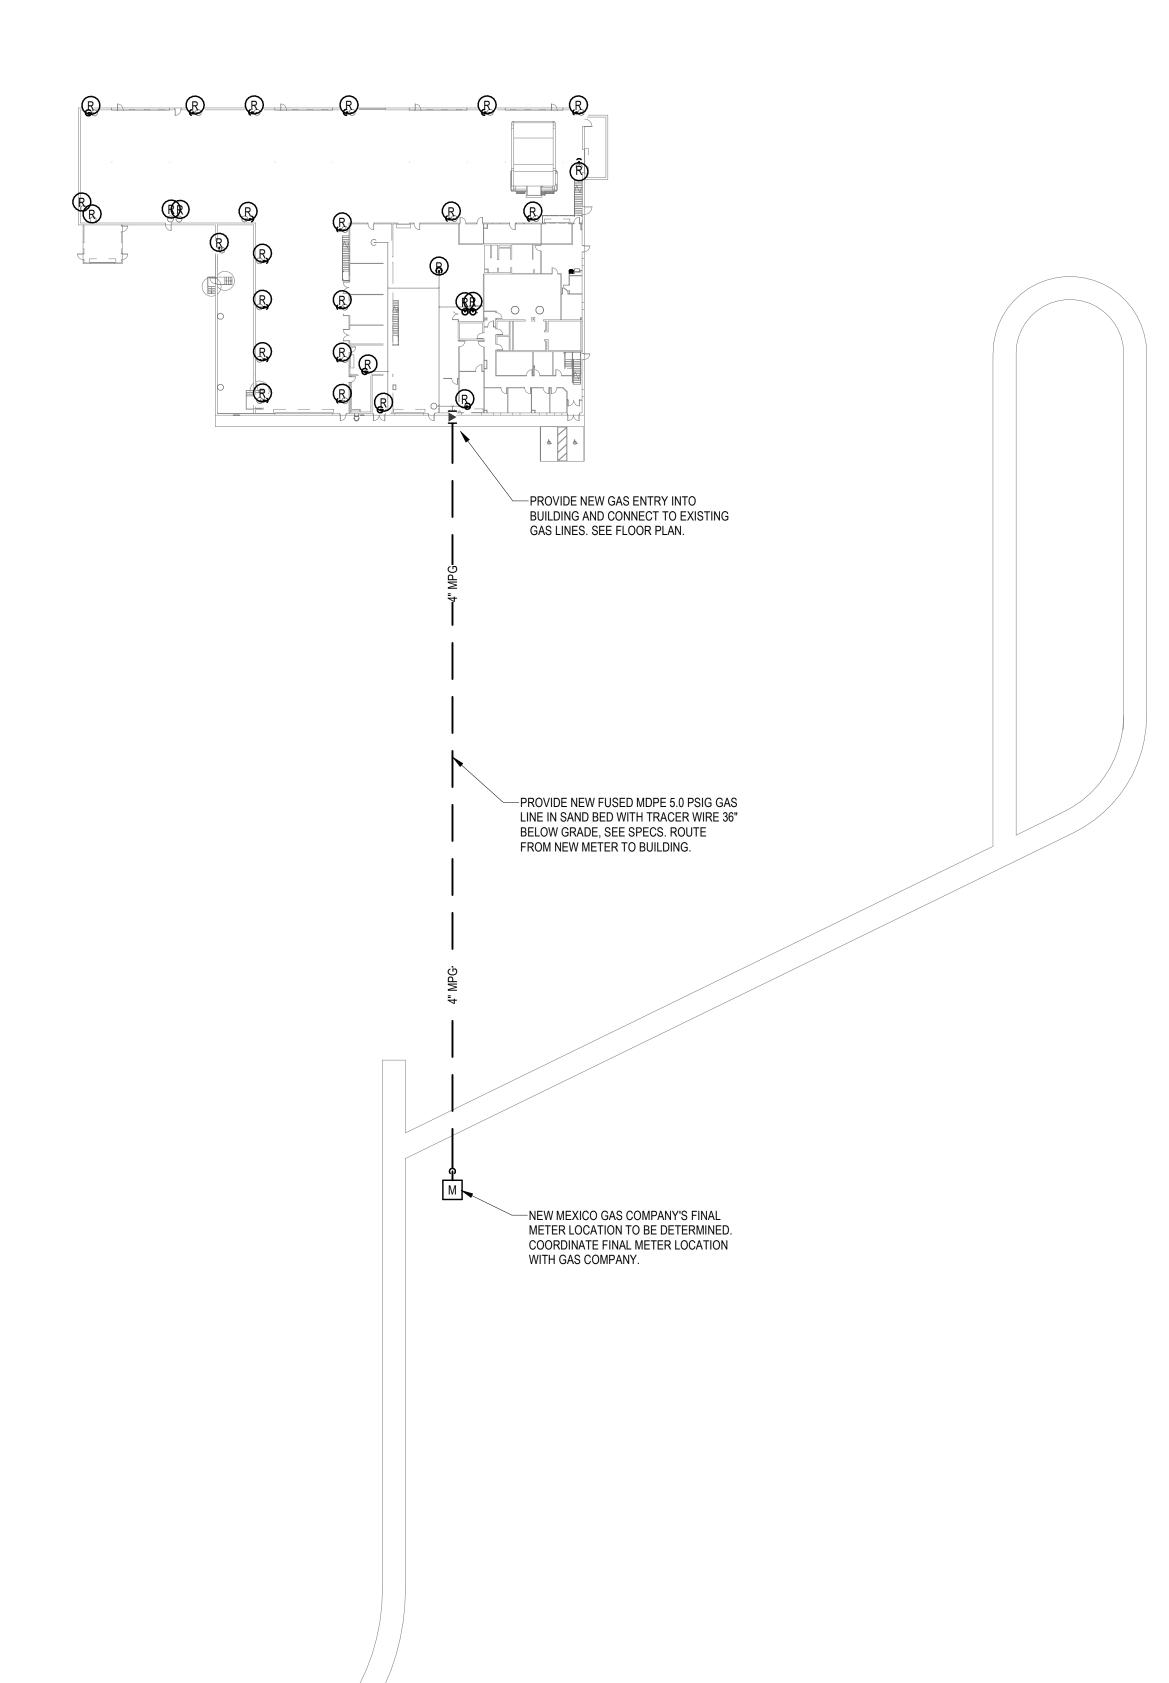

ROAD 1130



REYNOLDS ASH + ASSOCIATES ARCHITECTURE ENGINEERING

> 1140 MAIN AVE, STE. B DURANGO, CO 81301 (970) 259 - 7494 FAX (970) 259 - 7492 262 PAGOSA STREET, STE. 200 P.O. BOX 96 PAGOSA SPRINGS, CO 81147


RA-AE.COM

REYNOLDS ASH + ASSOCIATES, P.C.

EXPRESSLY RESERVES THE COMMON LAW COPYRIGHT AND OTHER PROPERTY RIGHTS IN THESE PLANS. THESE PLANS ARE NOT TO BE CHANGED OR COPIED IN ANY FORM OR MANNER WHATSOEVER NOR ARE THEY TO BE ASSIGNED TO ANY THIRD PARTY WITHOUT FIRST OBTAINING WRITTEN PERMISSION AND CONSENT OF THE ARCHITECT OF RECORD.

OBTAINING WRITTEN PERMISSION AND CONSENT OF THE ARCHITECT OF RECORD.

THE USE OF THESE PLANS AND SPECIFICATIONS SHALL BE RESTRICTED TO THE ORIGINAL SITE FOR WHICH THEY WERE PREPARED AND PUBLICATION TEHREOF IS EXPRESSLY LIMITED TO SUCH USE. FEDERAL LAW PROHIBITS THE REPRODUCTION, DISPLAY, SALE OR OTHER DISPOSITION OF THIS DOCUMENT WITHOUT THE EXPRESS WRITTEN CONSENT OF RA+A ARCHITECTS, P.C.

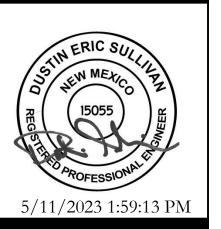

JAN COUNTY INDUSTRIAL
PARK

JOB. NO.: 2229
DATE: 2023-05-15
DRAWN BY: DS

ISSUE RECORD: 2023-02-17 100% SD 2023-03-31 DD

> 2023-05-15 CD REVISIONS:

> > D100

PLUMBING SITE PLAN

KEYED NOTES 21.01 REPLACE 50-YEAR OLD FIRE HOSE REEL ASSEMBLY. REUSE THE EXISTING 97 GALLON, 197 MBH INPUT, A.O. SMITH BT-197-880 SERIAL# MC90-0164299-880 WATER HEATERS. VERIFY ORIFICES ARE INDEED NATURAL GAS, REPLACE IF THEY ARE FOR PROPANE. DISINFECT THE ENTIRE COLD AND HOT WATER PIPING SYSTEM. SET HOT WATER TEMPERATURE TO 140°F. ALTERNATE BID #P1: REPLACE WATER HEATERS, SEE PLUMBING SCHEDULE ITEM "WH" FOR DETAILS. UNDER BOTH BASE AND ALTERNATE BIDS PROVIDE A NEW GAS PRESSURE REGULATOR WITH 5.0 PSI INLET AND 11" W.C. OUTLET AND PROVIDE A NEW GAS CONNECTION TO THE UNITS. SEE DETAIL FOR REQUIREMENTS. 22.02 REPLACE THE BATTERIES IN THE FLUSH VALVE. CLEAN AND RESTORE FIXTURE TO WORKING ORDER. CLEAN AND RESTORE FIXTURE TO WORKING ORDER. THE MANUAL FLUSH VALVE TO CLEAN AND RESTORE FIXTURE TO WORKING ORDER. THE MANUAL FAUCET TO REMAIN. PROVIDE NEW THERMOSTATIC MIXING VALVE (TMV). CLEAN AND RESTORE FIXTURE TO WORKING ORDER. 22.06 CLEAN AND RESTORE FIXTURE TO WORKING ORDER. THE SHOWER HEAD AND VALVE TO REMAIN.

KEYED NOTES

- 22.07 PROVIDE A NEW ELECTRIC WATER COOLER AT THIS LOCATION. CONNECT TO THE EXISTI WATER AND WASTE LINES. UTILIZE THE EXISTING RECEPTACLE. REPLACE LAVATORIES. REUSE WASTE, VENT, AND WATER PIPING. PROVIDE NEW
- THERMOSTATIC MIXING VALVE (TMV). REPLACE UTILITY SINK. CONNECT TO THE EXISTING WASTE, VENT, AND WATER PIPING.
- 4"MPG RISE TO ABOVE GRADE. PROVIDE NEW NATURAL GAS ENTRY ASSEMBLY AT 4,060 MBH AT 5.0 PSIG. ROUTE INTO BUILDING ABOVE GRADE AND CONNECT TO EXISTING GAS
- DISCONNECT EXISTING GAS LINE FROM HEATER TO BE REMOVED. REMOVE PIPE AS REQUIRED TO ALLOW FOR NEW CONNECTION ASSEMBLY TO NEW UNIT. PROVIDE NEW GA PRESSURE REGULATOR WITH 5.0 PSIG INLET PRESSURE AND 11" W.C. OUTLET PRESSURE PROVIDE NEW GAS CONNECTION TO UNIT, SEE DETAIL FOR REQUIREMENTS. DISCONNECT EXISTING GAS LINE FROM UNIT TO BE REMOVED. REMOVE GAS PIPING BACK

+ ASSOCIATES **ARCHITECTURE** ENGINEERING

> 1140 MAIN AVE, STE. B DURANGO, CO 81301 (970) 259 - 7494 FAX (970) 259 - 7492 262 PAGOSA STREET, STE. 200 PAGOSA SPRINGS, CO 81147

> > RA-AE.COM

EXPRESSLY RESERVES THE COMMON LAW COPYRIGHT AND OTHER PROPERTY RIGHTS IN THESE PLANS. THESE PLANS ARE NOT TO BE CHANGED OR COPIED IN ANY FORM OR MANNER WHATSOEVER NOR ARE THEY TO BE ASSIGNED TO ANY THIRD PARTY WITHOUT FIRST OBTAINING WRITTEN PERMISSION AND CONSENT OF THE ARCHITECT OF RECORD. THE USE OF THESE PLANS AND SPECIFICATIONS SHALL BE RESTRICTED TO THE ORIGINAL SITE FOR WHICH THEY WERE PREPARED AND PUBLICATION TEHREOF IS EXPRESSLY LIMITED TO SUCH USE. FEDERAL LAW PROHIBITS THE REPRODUCTION, DISPLAY, SALE OR


OTHER DISPOSITION OF THIS DOCUMENT WITHOUT THE EXPRESS WRITTEN CONSENT OF RA+A ARCHITECTS, P.C.


5/11/2023 1:59:14 PM

ISSUE RECORD: 2023-02-17 100% SD 2023-05-15 CD

REVISIONS:



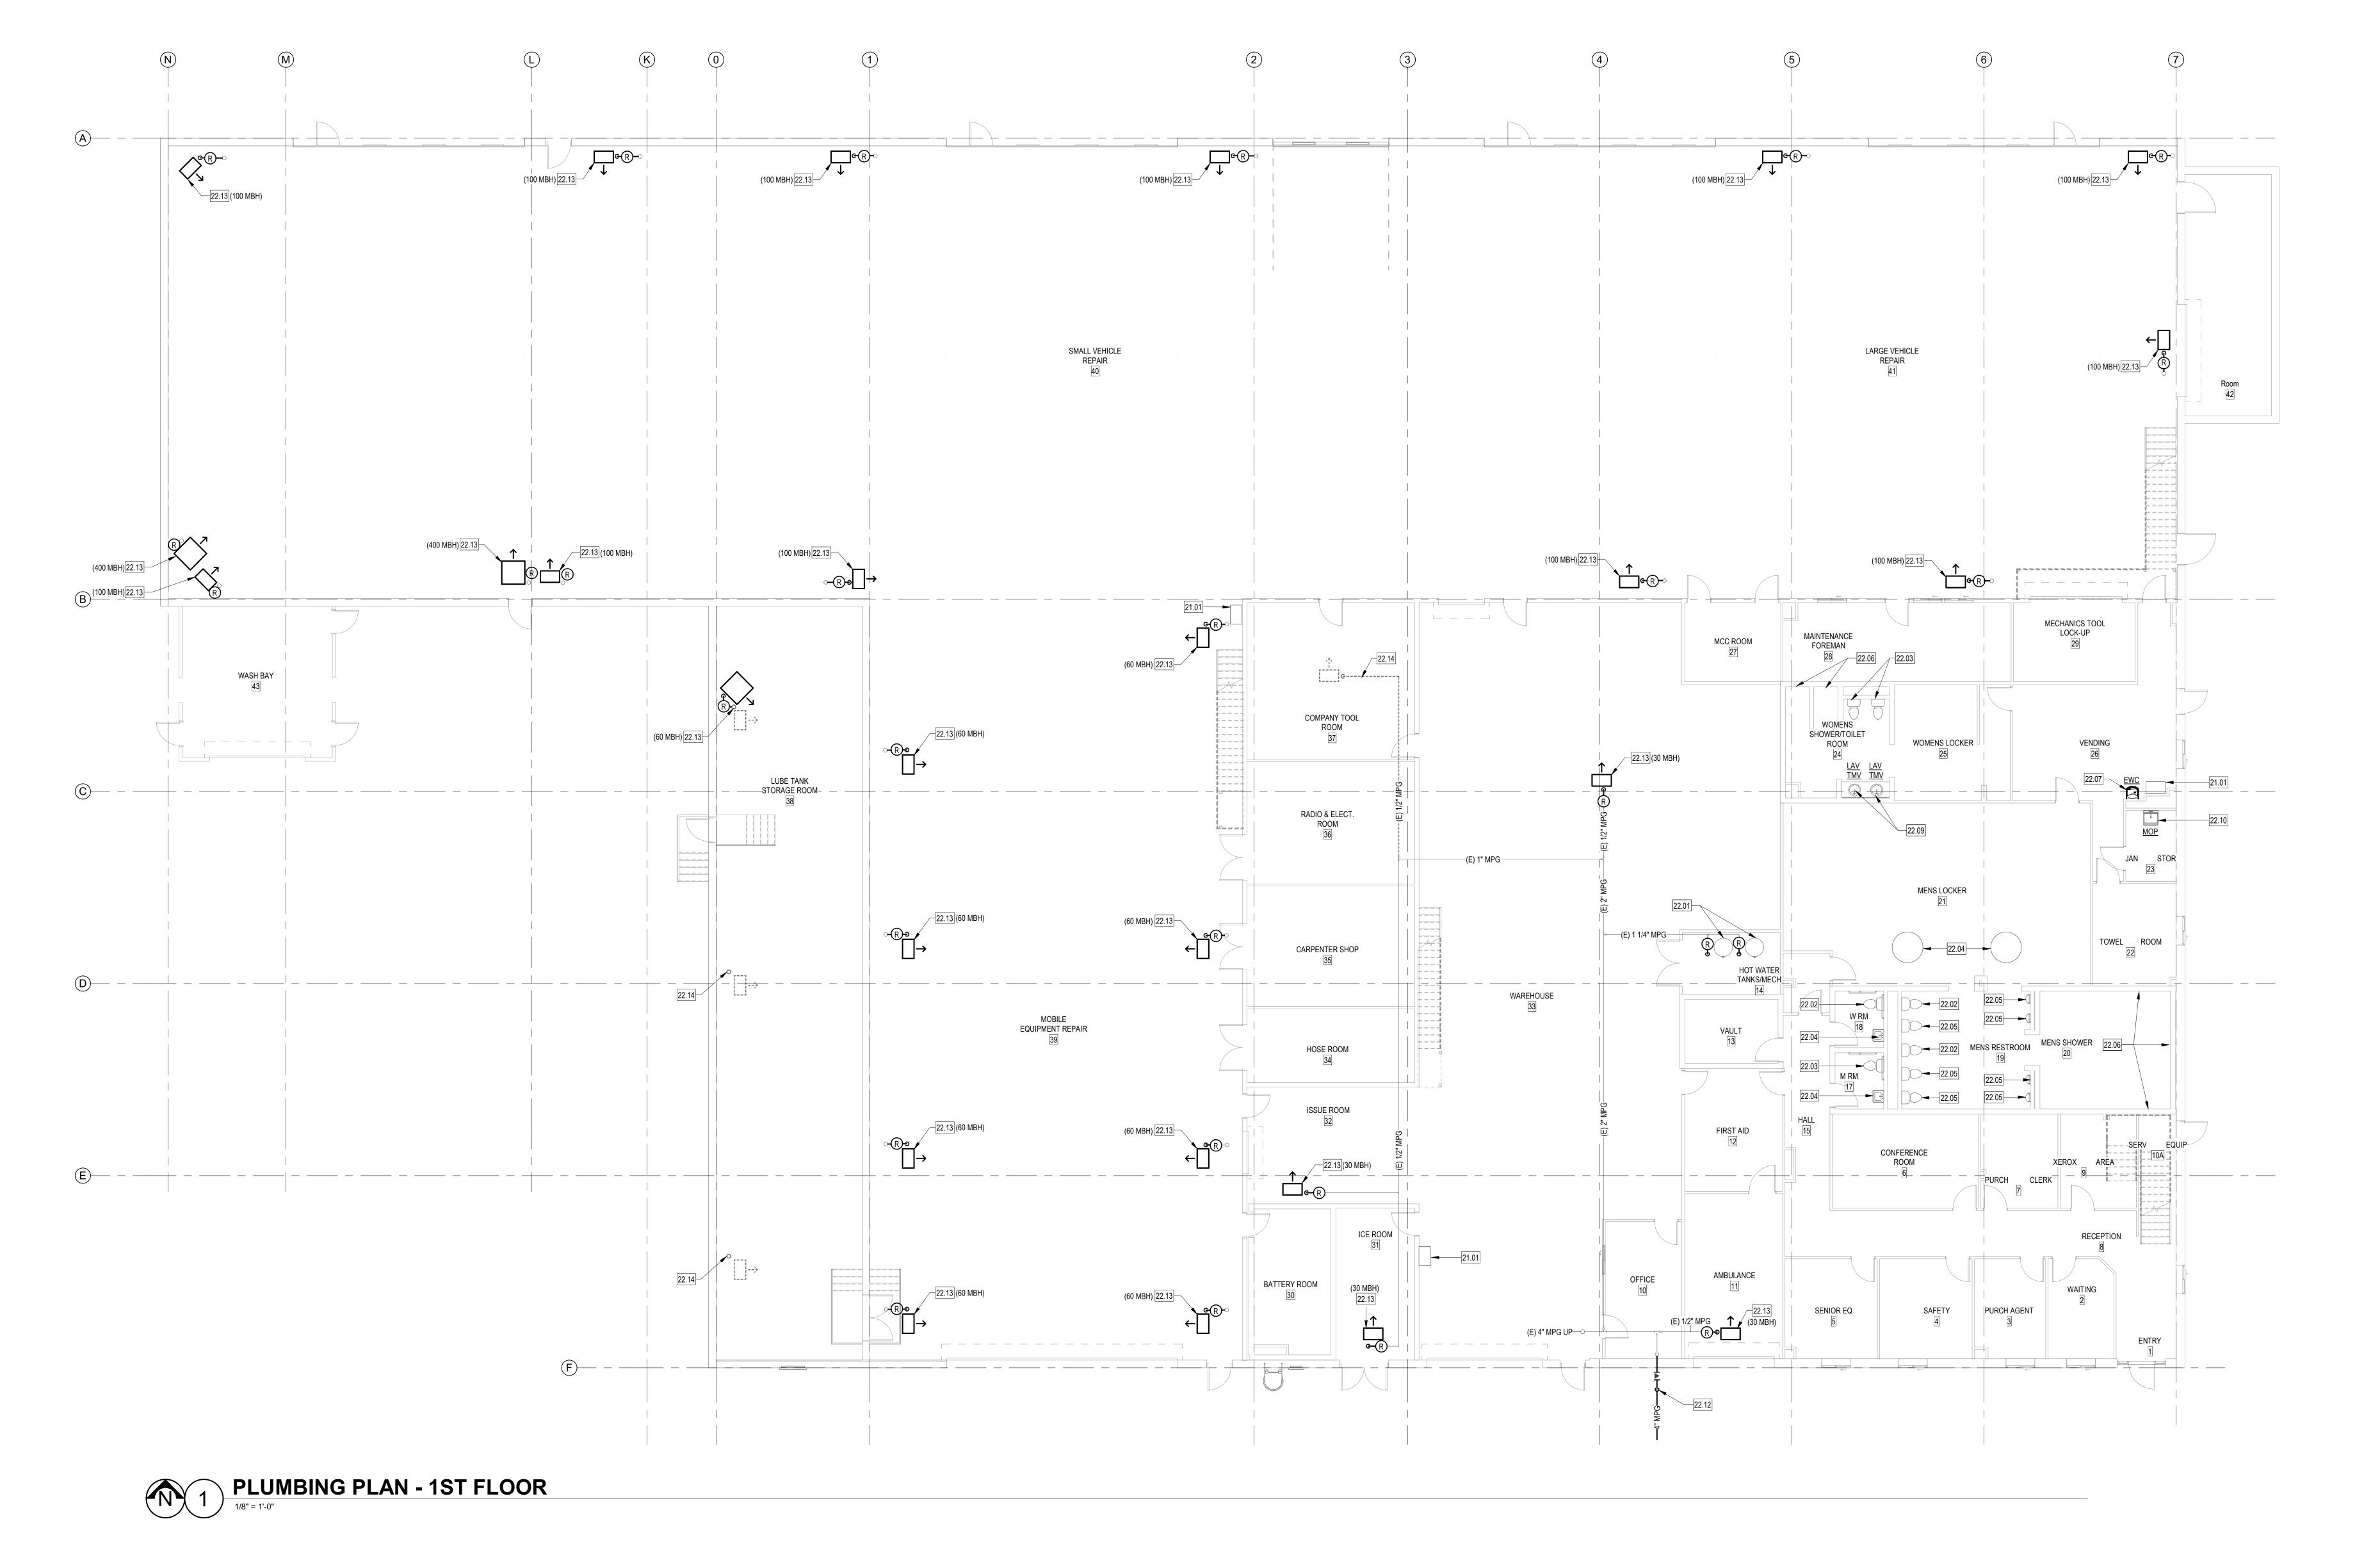

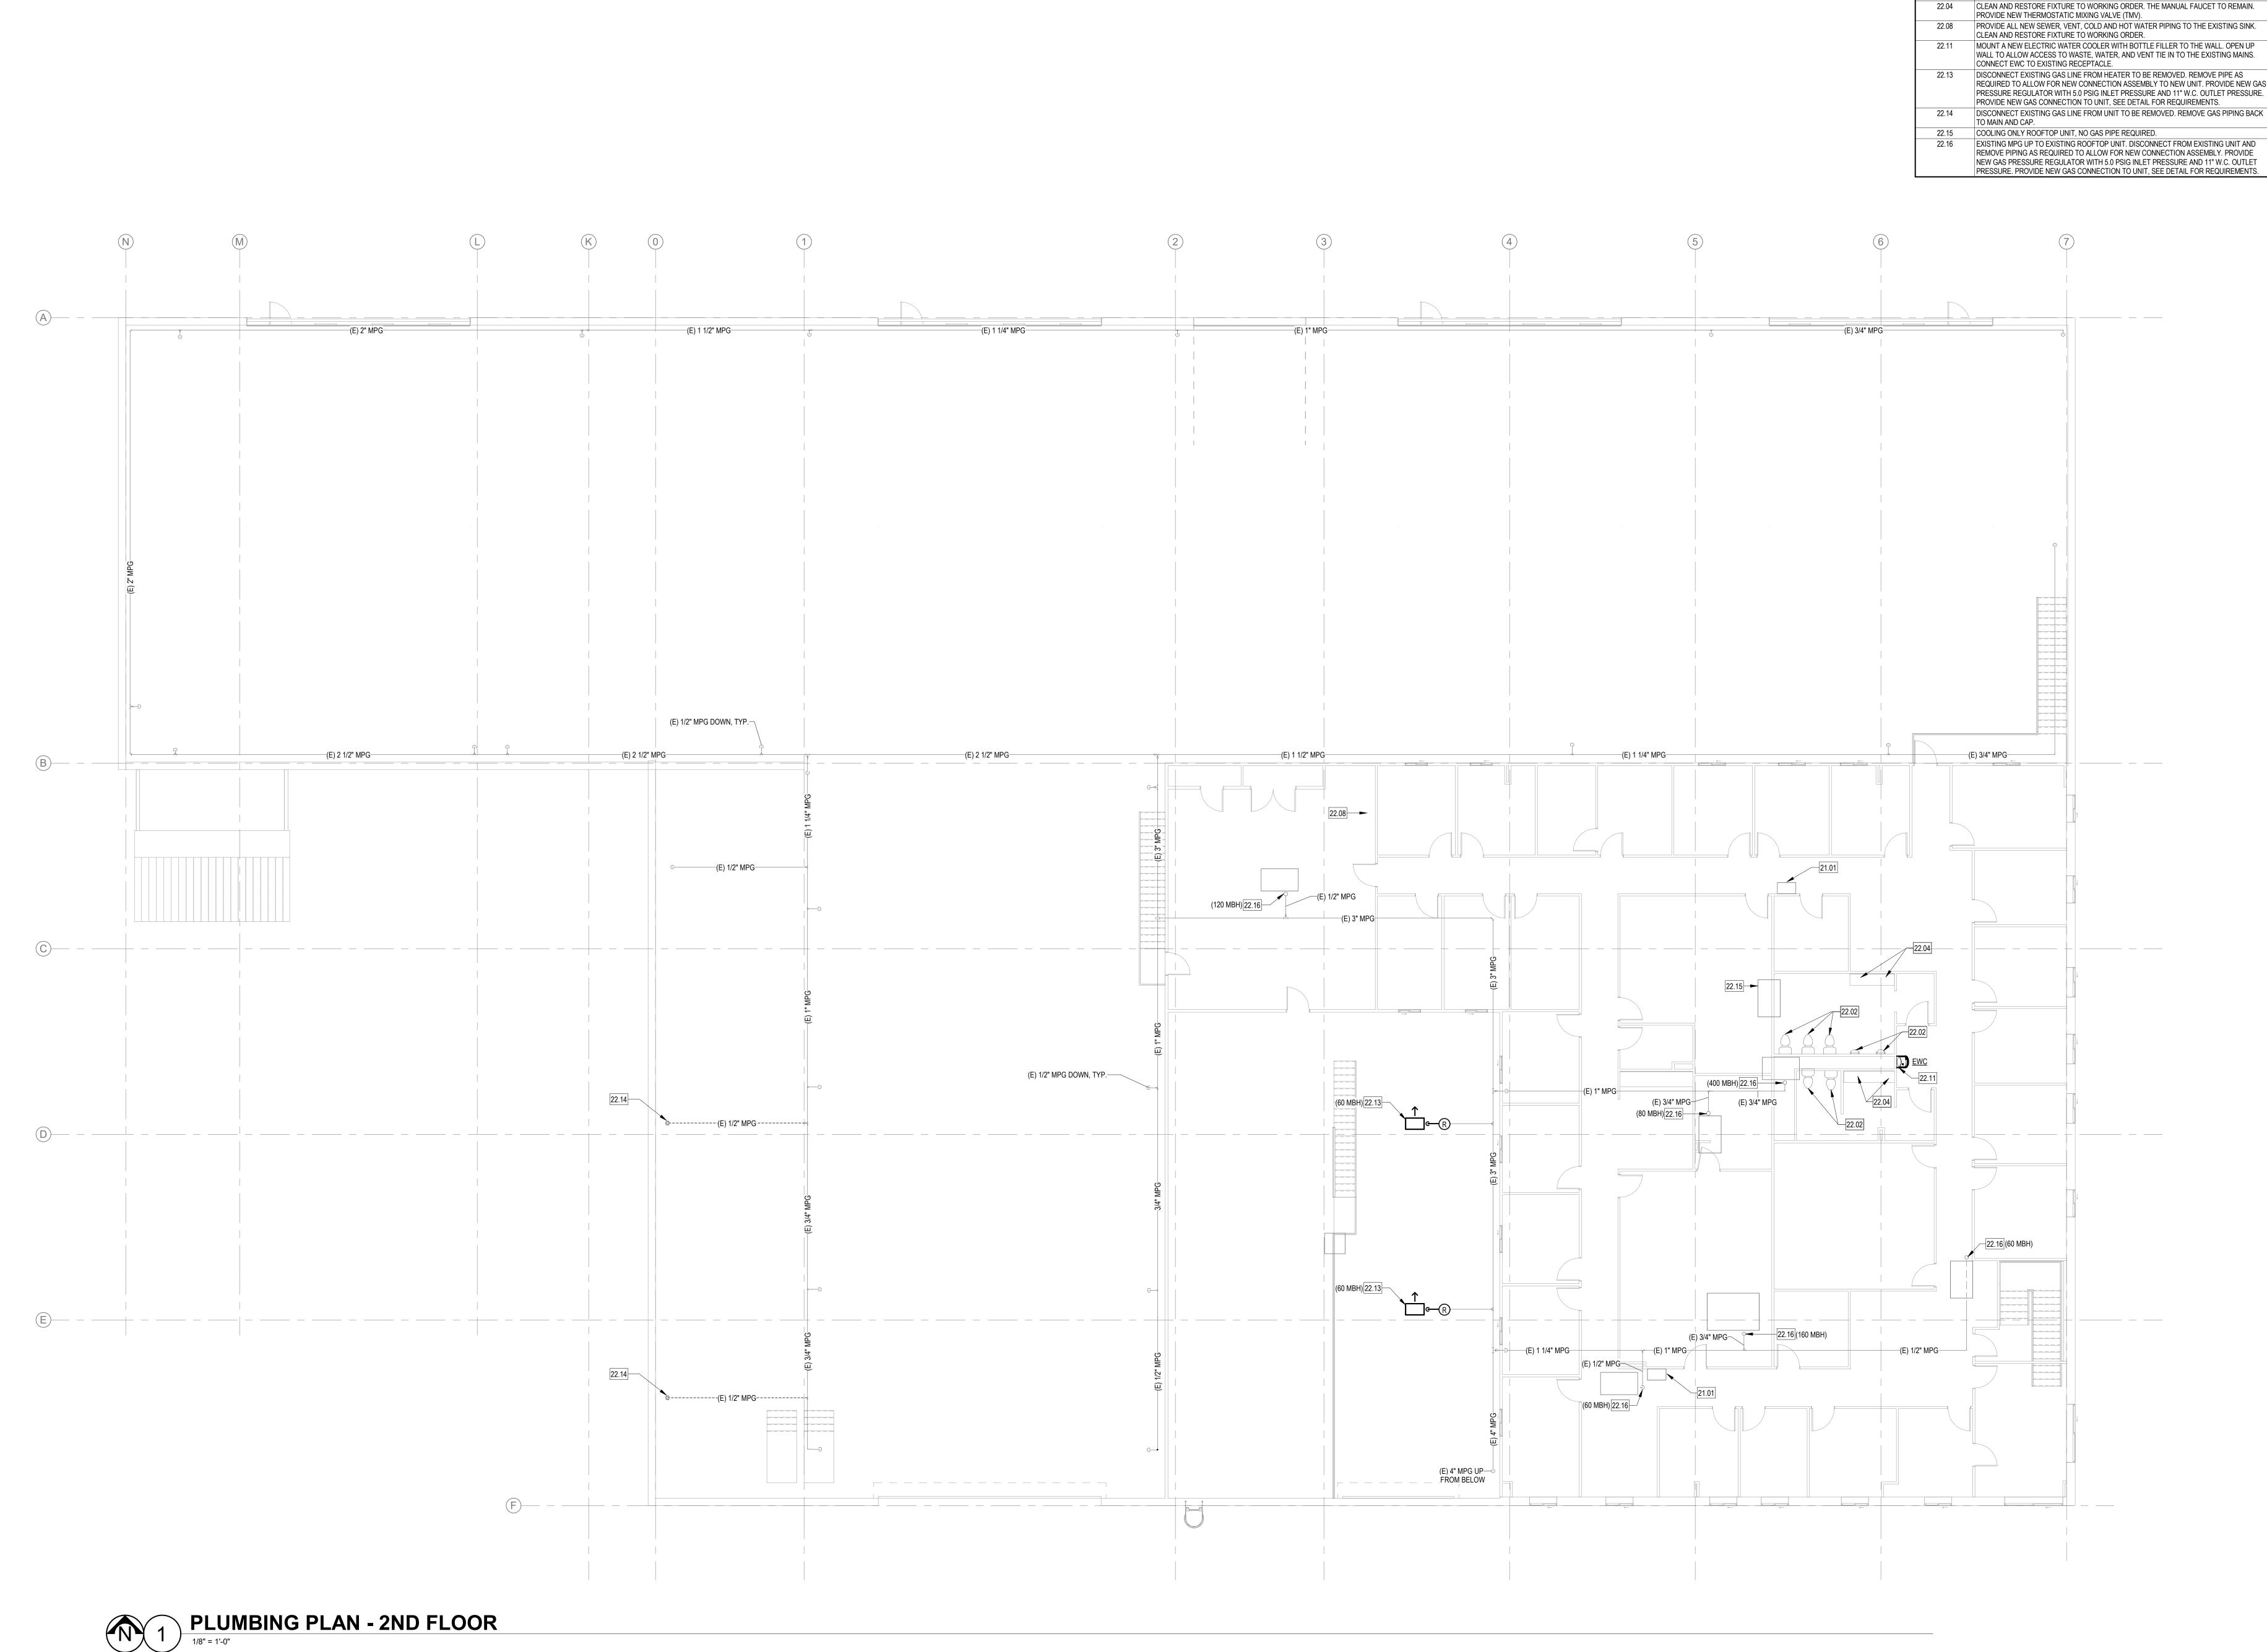

+ ASSOCIATES ARCHITECTURE ENGINEERING

KEYED NOTES

22.02 REPLACE THE BATTERIES IN THE FLUSH VALVE. CLEAN AND RESTORE FIXTURE TO

21.01 REPLACE 50-YEAR OLD FIRE HOSE REEL ASSEMBLY.

WORKING ORDER.


1140 MAIN AVE, STE. B DURANGO, CO 81301 (970) 259 - 7494 FAX (970) 259 - 7492

262 PAGOSA STREET, STE. 200 PAGOSA SPRINGS, CO 81147

RA-AE.COM

EXPRESSLY RESERVES THE COMMON LAW COPYRIGHT AND OTHER PROPERTY RIGHTS IN THESE PLANS. THESE PLANS ARE NOT TO BE CHANGED OR COPIED IN ANY FORM OR MANNER WHATSOEVER NOR ARE THEY TO BE ASSIGNED TO ANY THIRD PARTY WITHOUT FIRST OBTAINING WRITTEN PERMISSION AND CONSENT OF THE ARCHITECT OF RECORD.


THE USE OF THESE PLANS AND SPECIFICATIONS SHALL BE RESTRICTED TO THE ORIGINAL SITE FOR WHICH THEY WERE PREPARED AND PUBLICATION TEHREOF IS EXPRESSLY LIMITED TO SUCH USE. FEDERAL LAW PROHIBITS THE REPRODUCTION, DISPLAY, SALE OR OTHER DISPOSITION OF THIS DOCUMENT WITHOUT THE EXPRESS WRITTEN CONSENT OF RA+A ARCHITECTS, P.C.

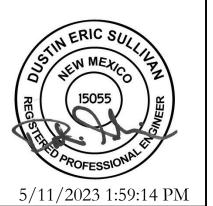

ISSUE RECORD: 2023-02-17 100% SD 2023-03-31 DD 2023-05-15 CD

REVISIONS:

PLUMBING PLAN -2ND FLOOR

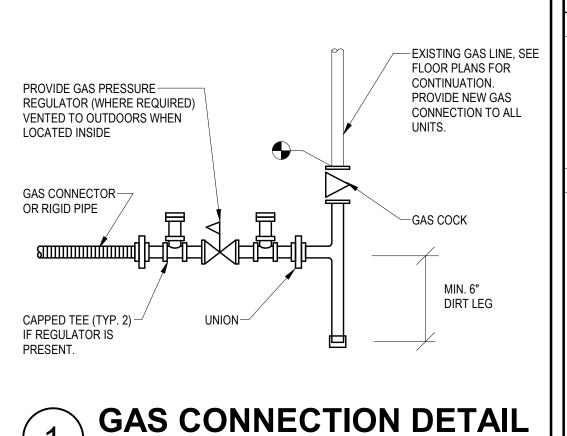

	SOLID BLACK INDICATES NEW	Ш
	LONG DASHED INDICATES BELOW GRADE	Ш
SYMBOL	DESCRIPTION	
<u>X#</u>	PLUMBING FIXTURE DESIGNATION	Ш
#	KEYED NOTE	Ш
	POINT OF CONNECTION	Ш
•		Ш
(E) CD	EXISTING CONDENSATE DRAIN (CD)	Ш
		Ш
SS	SANITARY SEWER (SS)	Ш
	VENT (V)	Ш
	COLD WATER (CW) HOT WATER SUPPLY (HW)	Ш
	HOT WATER RETURN (HWR)	Ш
	TEMPERED WATER (TW)	Ш
	NATURAL GAS (G)	Ш
	MEDIUM PRESSURE GAS (MPG)	Ш
	LIQUIEFIED PETROLEUM GAS (LPG)	Ш
		Ш
	ROOF DRAIN (RD)	Ш
	OVERFLOW DRAIN (OD)	Ш
	GREASE WASTE (GW)	Ш
	FIRE LINE (FL)	
I ▼ I	GAS COCK	
 	THERMOMETER CHECK VALVE (CKV)	
7 2	CHECK VALVE (CKV)	
ф Уст	RELIEF VALVE BUTTERFLY VALVE	
Ψ Δ	BALL VALVE (BV)	
	STRAINER WITH DRAIN VALVE	Ш
L	UNION	Ш
 ⋈	GATE VALVE	Ш
呂	SOLENOID WITH UNIONS	Ш
Ø	PRESSURE REDUCING VALVE (PRV)	Ш
1/11/	REDUCED PRESSURE BACKFLOW PREVENTER	Ш
\ !\! \	BACKFLOW PREVENTER	Ш
四	FLOOR SINK	Ш
	ROOF DRAIN	Ш
•	VENT THRU ROOF (VTR)	Ш
00	DOUBLE CLEAN OUT (DCO)	Ш
0	CLEAN OUT (CO)	Ш
•	FLOOR DRAIN	Ш
~~~	GAS FLEX	Ш
****	PEX PIPING	Ш
R	GAS PRESSURE REGULATOR	Ш
M	GAS METER	Ш
A	GAS PRESSURE REGULATOR	
\otimes	VALVE IN VALVE BOX	
ABBREVIATION	DESCRIPTION	
BFF	BELOW FINISHED FLOOR	
CA CD	COMPRESSED AIR CONDENSATE DRAIN	╽┝
CO	CLEANOUT	
CW	DOMESTIC COLD WATER	
DCO	DOUBLE CLEANOUT	
FFE	FINISHED FLOOR ELEVATION	
G GW	NATURAL GAS GREASE WASTE	
HW	DOMESTIC HOT WATER	
HWR	DOMESTIC HOT WATER RECIRCULATION	
IW	INDIRECT WASTE	
LPG	LIQUEFIED PETROLEUM GAS	
MPG N2O	MEDIUM PRESSURE GAS NITREOUS OXIDE (MED GAS)	
	OXYGEN (MED GAS)	
O2	OKTOLIV (MED GRO)	11
O2 OD	OVERFLOW DRAIN	
OD OW PD	OVERFLOW DRAIN OILY WASTE PRESSURIZED DISCHARGE	
OD OW PD RD	OVERFLOW DRAIN OILY WASTE PRESSURIZED DISCHARGE ROOF DRAIN	
OD OW PD RD SS	OVERFLOW DRAIN OILY WASTE PRESSURIZED DISCHARGE ROOF DRAIN SANITARY SEWER	
OD OW PD RD	OVERFLOW DRAIN OILY WASTE PRESSURIZED DISCHARGE ROOF DRAIN	
OD OW PD RD SS V	OVERFLOW DRAIN OILY WASTE PRESSURIZED DISCHARGE ROOF DRAIN SANITARY SEWER VENT	
OD OW PD RD SS V	OVERFLOW DRAIN OILY WASTE PRESSURIZED DISCHARGE ROOF DRAIN SANITARY SEWER VENT VACUUM (MED GAS)	

PLUMBI	NG SYMBOLS LEGEN
LINE TYPES	DESCRIPTION
	THIN LINE AND GRAY SCALE INDICATE EXISTING TO REM
	DASHED INDICATES EXISTING TO BE DEMOLISHED
	SOLID BLACK INDICATES NEW
	LONG DASHED INDICATES BELOW GRADE
SYMBOL	DESCRIPTION
<u>X#</u>	PLUMBING FIXTURE DESIGNATION
#	KEYED NOTE
•	POINT OF CONNECTION
(E)	EXISTING
CD	CONDENSATE DRAIN (CD)
	SANITARY SEWER (SS)
	VENT (V)
	COLD WATER (CW)
	HOT WATER SUPPLY (HW)
	HOT WATER RETURN (HWR)
	TEMPERED WATER (TW)
	NATURAL GAS (G)
	MEDIUM PRESSURE GAS (MPG)
	LIQUIEFIED PETROLEUM GAS (LPG)
	ROOF DRAIN (RD)
	OVERFLOW DRAIN (OD)

REMAIN


	PLUMBING GENERAL NOTES
1.	COMPLETE ALL WORK IN FULL COMPLIANCE WITH THE UPC, UMC, IECC, IBC, LIFE SAFETY ON N.F.P.A. AND ALL LOCAL CODES AND ORDINANCES.
2.	CAREFULLY LAYOUT AND INSTALL THE PLUMBING SYSTEMS INCLUDING ALL COORDINATION OF AND EXISTING SERVICES MECHANICAL FOLIPMENT DUCTWORK FLECTRICAL FOLIPMENT.

- NEW AND EXISTING SERVICES, MECHANICAL EQUIPMENT, DUCTWORK, ELECTRICAL EQUIPMENT, CONDUIT, CEILING GRID, AND ANY OTHER EQUIPMENT THAT MAY REQUIRE COORDINATION EFFORTS. COORDINATE TEMPORARY CUT-OFF OF WATER AND SEWER WITH UTILITY PROVIDERS. PERFORM ALL NECESSARY TRENCHING, BACK FILLING, CUTTING, PATCHING, REPAIRING, ETC. ASSOCIATED WITH THE INSTALLATION OF THE PLUMBING SYSTEM SHOWN ON THE PLANS AND DESCRIBED IN THE SPECIFICATIONS.
- ALL CONTRACTORS BIDDING ON THIS PROJECT ARE CAUTIONED TO VISIT THE SITE AND MAKE ALL NECESSARY INQUIRIES TO DETERMINE THE EXISTING CONDITIONS PRIOR TO SUBMITTING THEIR BIDS. NO SUBSEQUENT ALLOWANCE WILL BE MADE TO COMPENSATE FOR LACK OF PRE-BID INSPECTIONS BY THE SUCCESSFUL CONTRACTOR. ANY LINES ENCOUNTERED WHICH MAY INTERFERE WITH NEW CONSTRUCTION SHALL BE RELOCATED IF ACTIVE AND ABANDONED IF INACTIVE BY THIS CONTRACTOR UNDER THIS CONTRACT BY FIRST CONTACTING THE ARCHITECT FOR A RULING AS TO THEIR REMOVAL, RELOCATION, ETC.
 - PROVIDE ACCESS PANELS TO ALL INACCESSIBLE PLUMBING EQUIPMENT.
- INSULATE ALL NEWLY INSTALLED PIPING (DOMESTIC HOT AND COLD) IN THE BUILDING. LABEL PIPE WITH FLUID TYPE AND FLOW DIRECTION.
- INSULATE ALL EXPOSED COLD AND HOT WATER SUPPLY TUBING AND P-TRAPS AT LAVATORIES AND SINKS WITH AN A.D.A. APPROVED ENCLOSURE. INCLUDE ALL FITTINGS FOR A COMPLETE INSTALLATION.
- PRESSURE TEST, FLUSH AND DISINFECT ALL DOMESTIC WATER PIPING PER CHAPTER 6 OF THE PLUMBING CODE PRIOR TO CALLING FOR FINAL INSPECTION.
- DURING DEMOLITION CAREFULLY NOTE ANY CONDITIONS THAT MAY AFFECT THE JOB, SUCH AS UNANTICIPATED CONNECTIONS OR BROKEN, DAMAGED, PLUGGED, OR CRUSHED PIPE. TRANSMIT
- THESE FINDINGS IMMEDIATELY TO THE ENGINEER BY MEMO. RECONNECT EXISTING FIXTURES OR REPLACED FIXTURES WITH PIPING OF THE SAME SIZE AS
- EXISTING PIPING. 10. ALL PLENUM INSTALLED MATERIALS MUST BE PLENUM RATED OR WRAPPED IN A LISTED SYSTEM
- TO ACHIEVE A VALUE LOWER THAN 25 FLAME SPREAD AND 50 SMOKE DEVELOPMENT RATING.
- 11. FLUSHING LEVERS/MECHANISMS SHALL BE PLACED ON THE ACCESSIBLE SIDE OF THE FIXTURE. 12. ALL EXPOSED PIPE WALL PENETRATIONS IN FINISHED SPACES SHALL BE FITTED WITH CHROME

PLATED ESCUTCHEONS SECURED RIGIDLY FLUSH WITH WALL SURFACE.

CODE COMPLIANCE.

- 13. DOMESTIC HOT WATER SYSTEMS HAVE BEEN DESIGNED AND SIZED BASED ON 140 DEGREE SUPPLY TEMPERATURE. LOCATE POINT OF USE MIXING VALVE AT ALL SINKS AND LAVATORIES FOR
- 14. ALL PENETRATIONS THROUGH FIRE RATED WALLS OR ASSEMBLIES SHALL BE COMPLETED IN A MANNER THAT MAINTAINS THE FIRE RATING OF THE WALL OR ASSEMBLY.

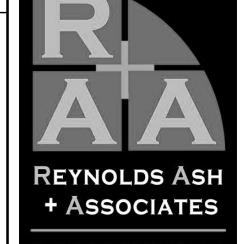


ARCHITECTURE ENGINEERING 1140 MAIN AVE, STE. B DURANGO, CO 81301 (970) 259 - 7494 FAX (970) 259 - 7492

> 262 PAGOSA STREET, STE. 200 PAGOSA SPRINGS, CO 81147 RA-AE.COM

EXPRESSLY RESERVES THE COMMON LAW COPYRIGHT AND OTHER PROPERTY RIGHTS IN THESE PLANS. THESE PLANS ARE NOT TO BE CHANGED OR COPIED IN ANY FORM OR MANNER WHATSOEVER NOR ARE THEY TO BE ASSIGNED TO ANY THIRD PARTY WITHOUT FIRST OBTAINING WRITTEN PERMISSION AND CONSENT OF THE ARCHITECT OF RECORD.

THE USE OF THESE PLANS AND SPECIFICATIONS SHALL BE RESTRICTED TO THE ORIGINAL SITE FOR WHICH
THEY WERE PREPARED AND PUBLICATION TEHREOF IS EXPRESSLY LIMITED TO SUCH USE. FEDERAL LAW PROHIBITS THE REPRODUCTION, DISPLAY, SALE OR EXPRESS WRITTEN CONSENT OF RA+A ARCHITECTS, P.C.

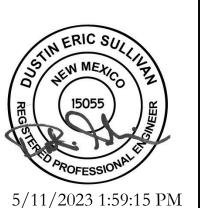

PLUMBING SCHEDULE

EWC ELECTRIC WATER COOLER: SINGLE LEVEL ADA COMPLIANT WATER COOLER WITH BOTTLE FILLER, LEAD-FREE WATERWAY, FRONT/SIDE PUSHBAR ACTIVATION, STAINLESS STEEL BASIN WITH INTEGRAL DRAIN, LIGHT GRAY GRANITE VINYL CLAD FINISH WITH CANE APRON, BOTTLE FILL STATION, 8 GPH CAPACITY, ELEC = 120V/1PH/5.0A "ELKAY" MODEL LZS8WSLK WASTE = 2", VENT = 1-1/2" CW = 1/2"

WASTE = 2 IN., VENT = 1 1/2 IN., CW = 1/2 IN., TW = 1/2 IN.

KIT, ELECTRICAL: 120V/1PH/10A.

"AMTROL" MODEL ST-5C (ALTERNATE BID #P1)

- LAV LAVATORY: COUNTERTOP MOUNTED VITREOUS CHINA, SELF-RIMMING, FRONT OVERFLOW, 4 IN. FAUCET CENTERS, PERFORATED STRAINER, CHROME PLATED BRASS "P" TRAP AND TAILPIECE. TRUEBRO LAV GUARD IF EXPOSED TRAP, A.D.A. COMPLIANT METERED MANUAL FAUCET. "AMERICAN STANDARD" AQUALYN 0476.028
- MOP SERVICE SINK: 24"x24" PRECAST TERRAZZO, STAINLESS STEEL CAPS ON ALL CURBS, WALL MOUNTED 3 STATION MOP HOLDER., "CHICAGO" 445-897-SRCXKCP 2.0 GPM FAUCET WITH VACUUM BREAKER AND CHECK STOPS, WALL BRACE AND 3/4" THREADED HOSE OUTLET. "FIAT" MODEL TSB100
- WASTE = 3 IN., VENT = 1 1/2 IN., CW & HW = 3/4 IN. TMV THERMOSTATIC MIXING VALVE: 1/2" ASSE 1070 POINT OF USE MIXING VALVE. SET AT 105°F. COLD WATER 50°F, HOT WATER 140°F.
- "WATTS" MODEL LFMMV WH WATER HEATER: 98% EFF., 100 GALLON, 199 MBH INPUT, NATURAL GAS, 227 GPH AT 100 DEG. F., TEMPERATURE RISE, INSULATED WITH R8.33, GLASS LINED TANK, CONDENSATE NEUTRALIZER
- "A.O. SMITH" MODEL BTH-199 (ALTERNATE BID #P1) XT EXPANSION TANK: POTABLE WATER USE, 150 MAX. WORKING PRESSURE, 2.0 GALLONS TOTAL VOLUME, ASME, 55 PSIG FACTORY PRECHARGE.

2229	JOB. NO.:
2023-05-15	DATE:
ME&E	DRAWN BY:

MEXICO

PI

1130,

ISSUE RECORD: 2023-02-17 100% SD 2023-03-31 DD

REVISIONS:


2023-05-15 CD

PLUMBING LEGEND, NOTES, AND DETAILS

KEYED NOTES 23.01 REPLACE EXISTING 105 MBH INPUT PROPANE FIRED INFRARED HEATER WITH NATURAL GAS FIRED INFRARED HEATER. PROVIDE A NEW THERMOSTAT. 23.02 REPLACE EXISTING PROPANE FIRED UNIT HEATER WITH NATURAL GAS FIRED UNIT HEATER. PROVIDE NEW 6" FLUE AND COMBUSTION AIR PIPES ROUTED THROUGH EXTERIOR WALL TO CONCENTRIC VENT KIT. INSTALL PER MANUFACTURER'S INSTRUCTIONS. 23.03 EXISTING THROUGH-THE-WALL HVAC UNIT TO REMAIN, NO WORK. ALL EXISTING DUCTWORK TO REMAIN, NO WORK. ALL EXISTING DIFFUSERS AND GRILLES TO REMAIN AND BE REUSED UNLESS NOTED OTHERWISE. CLEAN AND RESTORE ALL, TYP. REPLACE EXISTING 52.5 MBH INPUT PROPANE FIRED INFRARED HEATER WITH NATURAL GAS FIRED INFRARED HEATER. PROVIDE A NEW THERMOSTAT. REPLACE EXISTING 17.5 MBH INPUT PROPANE FIRED INFRARED HEATER WITH NATURAL GAS FIRED INFRARED HEATER. PROVIDE A NEW THERMOSTAT.

KEYED NOTES


- 23.08 REPLACE EXISTING CEILING EXHAUST FAN. BALANCE THE 4" DIAMETER EXHAUST DUCT CONNECTING TO THE LOCKERS TO 50 CFM,
- REMOVE AND DISPOSE OF EXISTING RADIANT HEATER AND ASSOCIATED CONTROLS. MOUNT THE ROOF EXHAUSTER SPEED CONTROLLER ON WALL. RX# INDICATES ASSOCIATED
- ROOF EXHAUSTER TO BE CONTROLLED, TYPICAL. PROVIDE NEW NATURAL GAS FIRED UNIT HEATER. PROVIDE NEW 4" FLUE AND COMBUSTIC AIR PIPES ROUTED THROUGH EXTERIOR WALL TO CONCENTRIC VENT KIT. INSTALL PIPES PER MANUFACTURER'S INSTRUCTIONS.

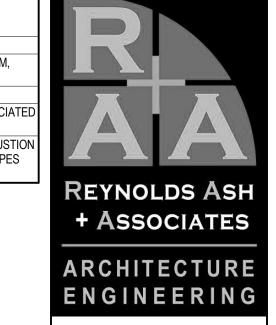

1140 MAIN AVE, STE. B DURANGO, CO 81301 (970) 259 - 7494 FAX (970) 259 - 7492 262 PAGOSA STREET, STE. 200 PAGOSA SPRINGS, CO 81147 RA-AE.COM

EXPRESSLD'S ASH + ASSOCIATES, P.C.

EXPRESSLY RESERVES THE COMMON LAW COPYRIGHT
AND OTHER PROPERTY RIGHTS IN THESE PLANS. THESE
PLANS ARE NOT TO BE CHANGED OR COPIED IN ANY
FORM OR MANNER WHATSOEVER NOR ARE THEY TO BE
ASSIGNED TO ANY THIRD PARTY WITHOUT FIRST
OBTAINING WRITTEN PERMISSION AND CONSENT OF
THE ARCHITECT OF RECORD. THE USE OF THESE PLANS AND SPECIFICATIONS SHALL BE RESTRICTED TO THE ORIGINAL SITE FOR WHICH THEY WERE PREPARED AND PUBLICATION TEHREOF IS EXPRESSLY LIMITED TO SUCH USE. FEDERAL LAW PROHIBITS THE REPRODUCTION, DISPLAY, SALE OR OTHER DISPOSITION OF THIS DOCUMENT WITHOUT THE EXPRESS WRITTEN CONSENT OF RA+A ARCHITECTS, P.C.

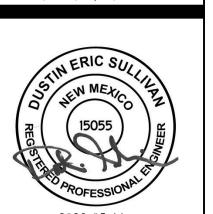


ISSUE RECORD: 2023-02-17 100% SD 2023-03-31 DD

2023-05-15 CD

REVISIONS:

MECHANICAL PLAN - 1ST FLOOR

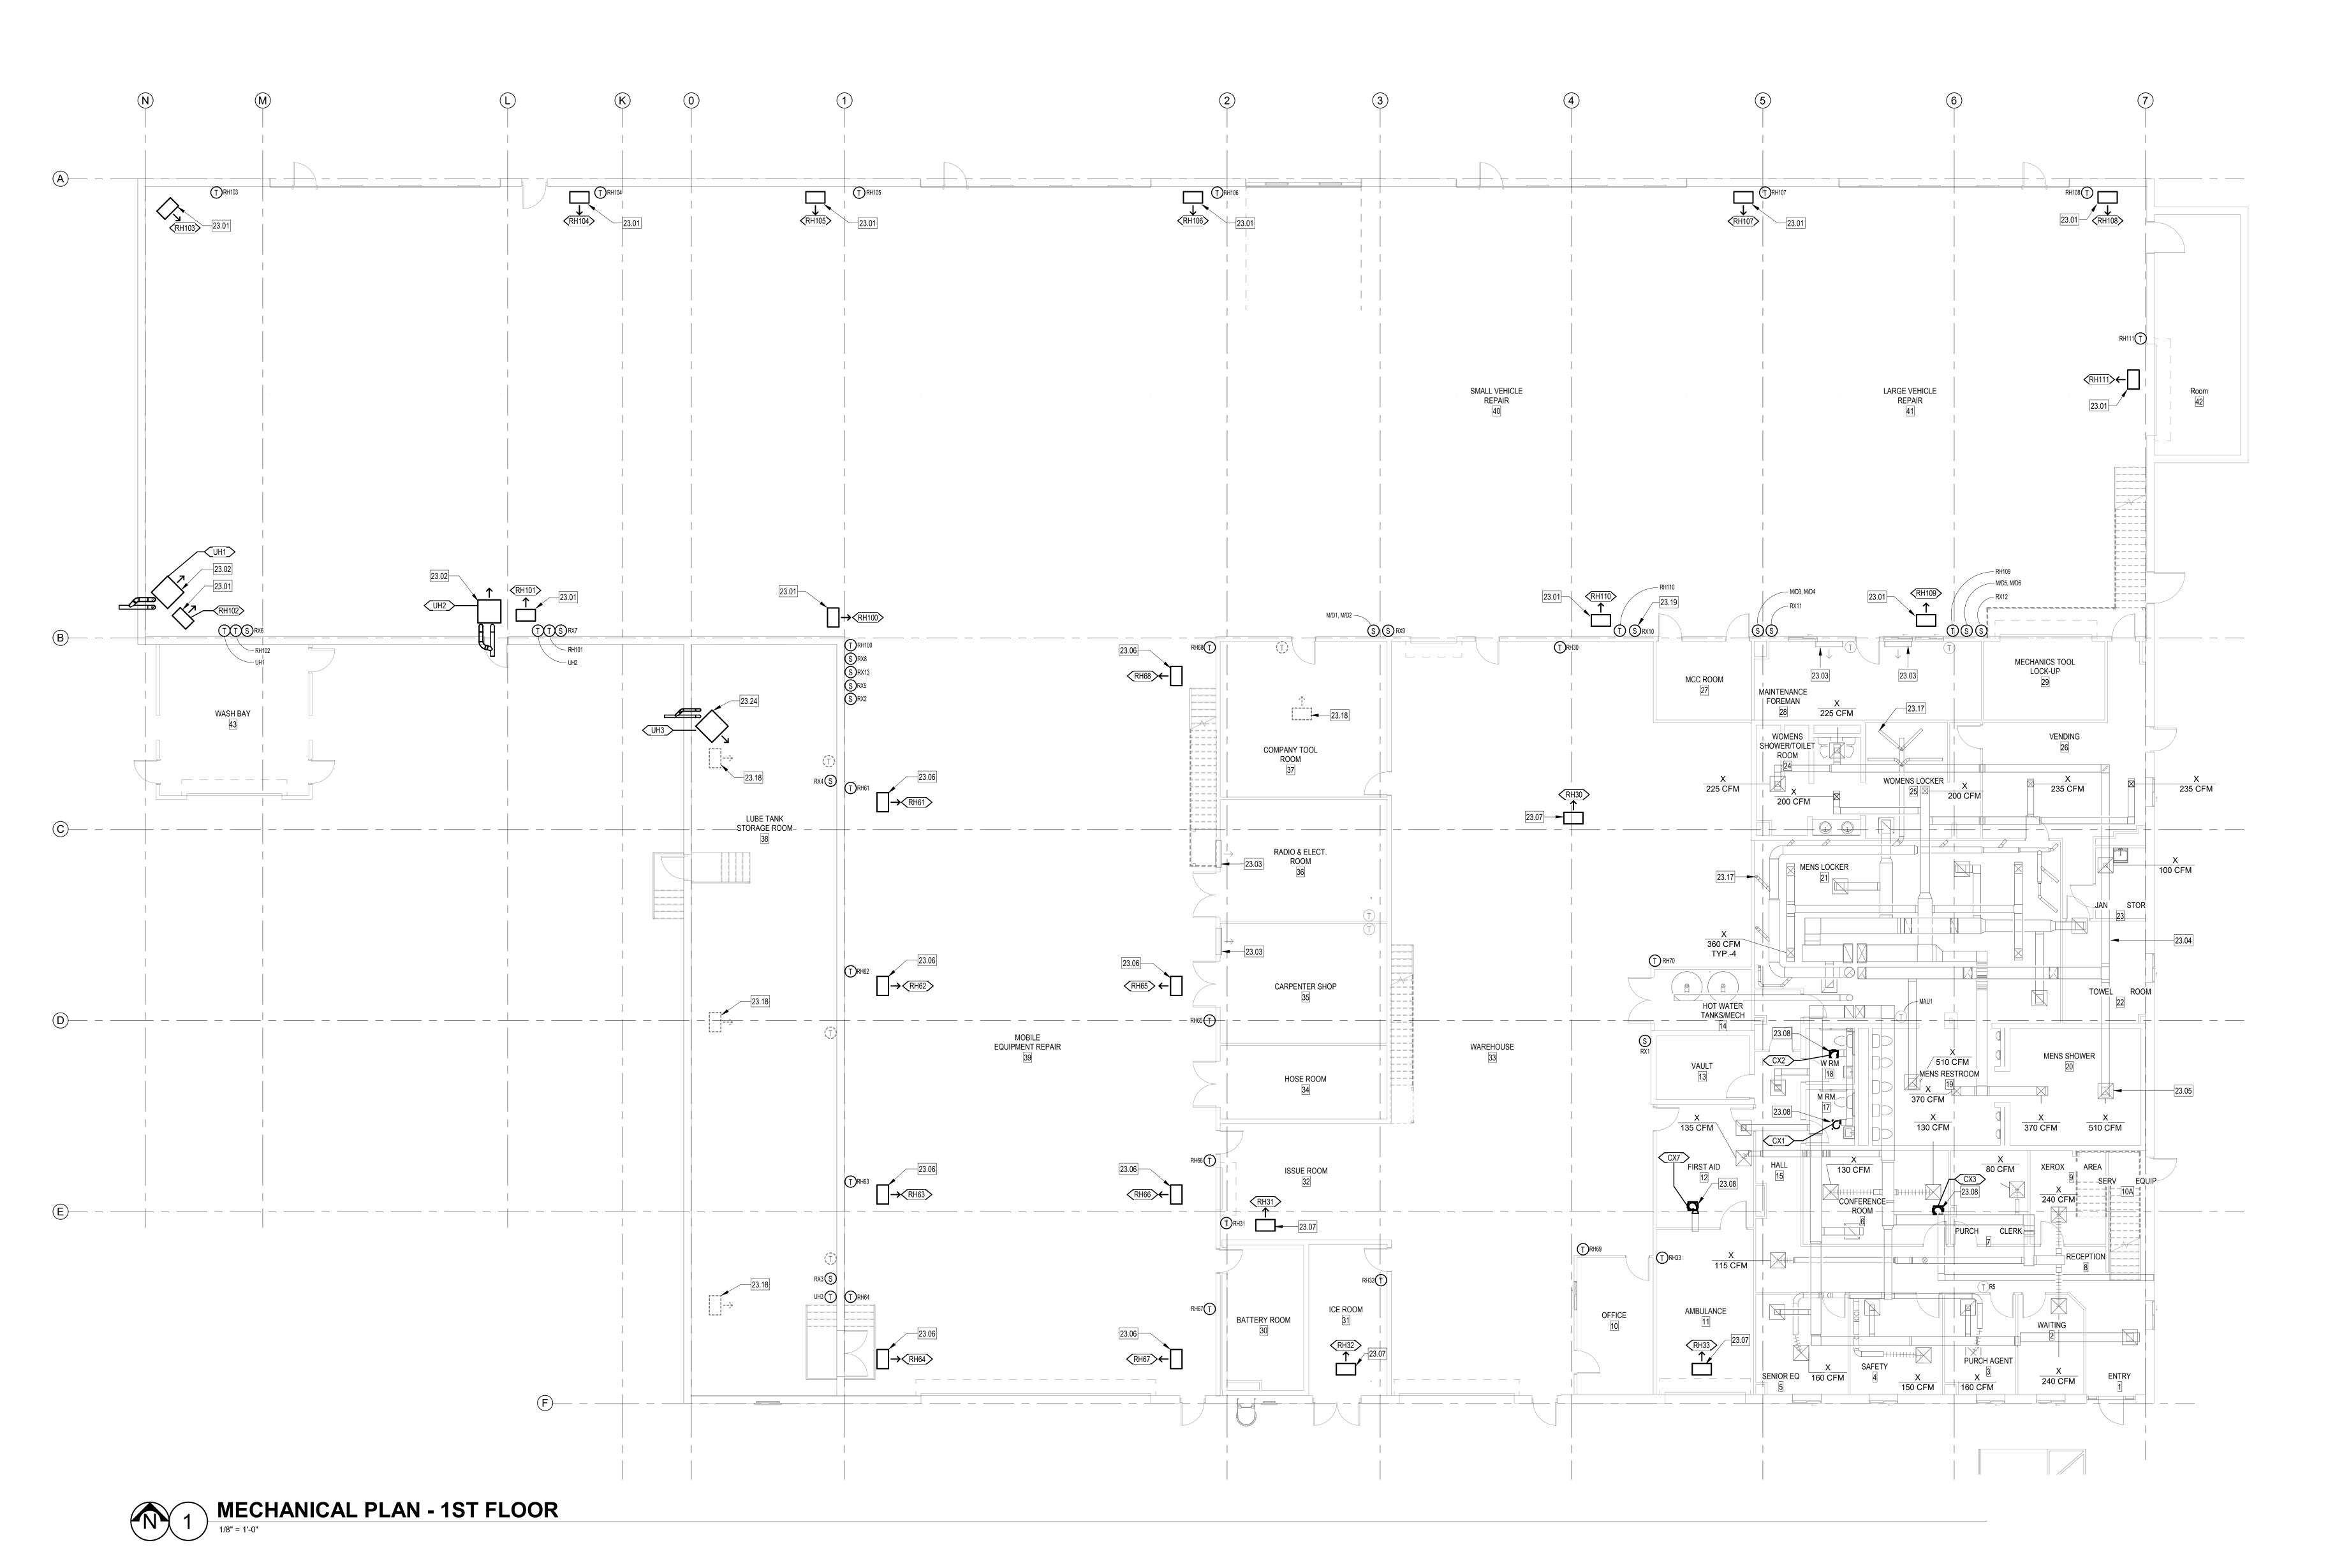

	KEYED NOTES							
23.04	ALL EXISTING DUCTWORK TO REMAIN, NO WORK.							
23.05	ALL EXISTING DIFFUSERS AND GRILLES TO REMAIN AND BE REUSED UNLESS NOTED OTHERWISE. CLEAN AND RESTORE ALL, TYP.							
23.06	REPLACE EXISTING 52.5 MBH INPUT PROPANE FIRED INFRARED HEATER WITH NATURAL GAS FIRED INFRARED HEATER. PROVIDE A NEW THERMOSTAT.							
23.08	REPLACE EXISTING CEILING EXHAUST FAN.							
23.09	REPLACE EXISTING ROOF MOUNTED FAN. SEE DETAIL.							
23.10	ABANDON EXISTING ROOF MOUNTED FAN IN PLACE. REMOVE EXISTING BACKDRAFT DAMPER AND REPLACE WITH A MOTORIZED DAMPER. SEE DETAIL.							
23.11	REPLACE EXISTING PROPANE GAS ORIFICE WITH NEW NATURAL GAS ORIFICE. UNDER ALTERNATE BID: REPLACE ROOFTOP UNIT, SEE SCHEDULES.							
23.12	COOLING ONLY UNIT, NO WORK. UNDER ALTERNATE BID: REPLACE ROOFTOP UNIT, SEE SCHEDULES. DUCT ROUTING AND DIFFUSER QUANTITY AND LOCATIONS ARE UNKNOWN. BALANCE ALL EXISTING DIFFUSERS EQUALLY TO ACHIEVE SCHEDULED NEW UNIT AIRFLOW							
23.13	REMOVE EXISTING ROOF MOUNTED PRINTER EXHAUST FAN. CAP AND SEAL ROOF CURB.							
23.14	RELOCATE EXHAUST FAN TERMINATION THROUGH ROOF TO BE MIN. 10' AWAY FROM MAU-INTAKE.							

	_		
		23.15	REPLAC
D UNLESS NOTED		23.16	ROOF E
ATER WITH NATURAL		23.20	PROVID LOCATI SHALL (FAN CO DETAIL
TING BACKDRAFT		23.21	INTERC ROOF E INTERC
AS ORIFICE. UNDER			30"x30" INFORM
ROOFTOP UNIT, SEE TIONS ARE UNKNOWN.		23.22	ABANDO
JLED NEW UNIT AIRFLOW.		23.23	REPLAC


	KEYED NOTES	
15	REPLACE EXISTING DAMAGED DIFFUSER. "KRUEGER" 1450A OR EQUAL.	
16	ROOF EXHAUSTERS TO REMAIN.	
20	PROVIDE A WALL SWITCH TO CONTROL MOTORIZED DAMPERS, SEE 1ST FLOOR PLAN FOR LOCATIONS. ONE WALL SWITCH SHALL CONTROL TWO DAMPERS. MOTORIZED DAMPERS SHALL OPEN WHEN ASSOCIATED WALL SWITCH IS TURNED ON. TRANSITION FROM ORIGINAL FAN CONNECTION TO THE 36"x36" DAMPER AS REQUIRED, TYPICAL. SEE MAKEUP AIR HOOD DETAIL FOR MORE INFORMATION.	ΑΑ
21	INTERCONNECT 30"x30" MOTORIZED DAMPER TO OPEN UPON ACTIVATION OF ASSOCIATED ROOF EXHAUSTER. RX# INDICATES ASSOCIATED ROOF EXHAUSTER TO BE INTERCONNECTED WITH, TYPICAL. TRANSITION FROM ORIGINAL FAN CONNECTION TO THE 30"x30" DAMPER AS REQUIRED, TYPICAL. SEE MAKEUP AIR HOOD DETAIL FOR MORE INFORMATION.	REYNOLDS AS
22	ABANDON FAN IN PLACE.	· ASSOCIATI
23	REPLACE EXISTING INLINE FAN, REUSE EXISTING CONTROLS. MODIFY DUCTWORK AS REQUIRED TO CONNECT TO NEW FAN.	ARCHITECTU

1140 MAIN AVE, STE. B DURANGO, CO 81301 (970) 259 - 7494 FAX (970) 259 - 7492 262 PAGOSA STREET, STE. 200 P.O. BOX 96 PAGOSA SPRINGS, CO 81147

ENGINEERING

EXPRESSLY RESERVES THE COMMON LAW COPYRIGHT
AND OTHER PROPERTY RIGHTS IN THESE PLANS. THESE
PLANS ARE NOT TO BE CHANGED OR COPIED IN ANY
FORM OR MANNER WHATSOEVER NOR ARE THEY TO BE
ASSIGNED TO ANY THIRD PARTY WITHOUT FIRST
OBTAINING WRITTEN PERMISSION AND CONSENT OF
THE ARCHITECT OF RECORD.

THE USE OF THESE PLANS AND SPECIFICATIONS SHALL
BE RESTRICTED TO THE ORIGINAL SITE FOR WHICH
THEY WERE PREPARED AND PUBLICATION TEHREOF IS
EXPRESSLY LIMITED TO SUCH USE. FEDERAL LAW
PROHIBITS THE REPRODUCTION, DISPLAY, SALE OR
OTHER DISPOSITION OF THIS DOCUMENT WITHOUT THE
EXPRESS WRITTEN CONSENT OF
RA+A ARCHITECTS, P.C.

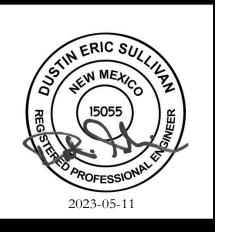

AN JUAN COUNTY INDUSTRIAL PARK

> NO.: **2229** E: **2023-05-15** WN BY: **JS**


ISSUE RECORD: 2023-02-17 100% SD 2023-03-31 DD


2023-03-31 DD 2023-05-15 CD


REVISIONS:


M102

MECHANICAL PLAN
- 2ND FLOOR

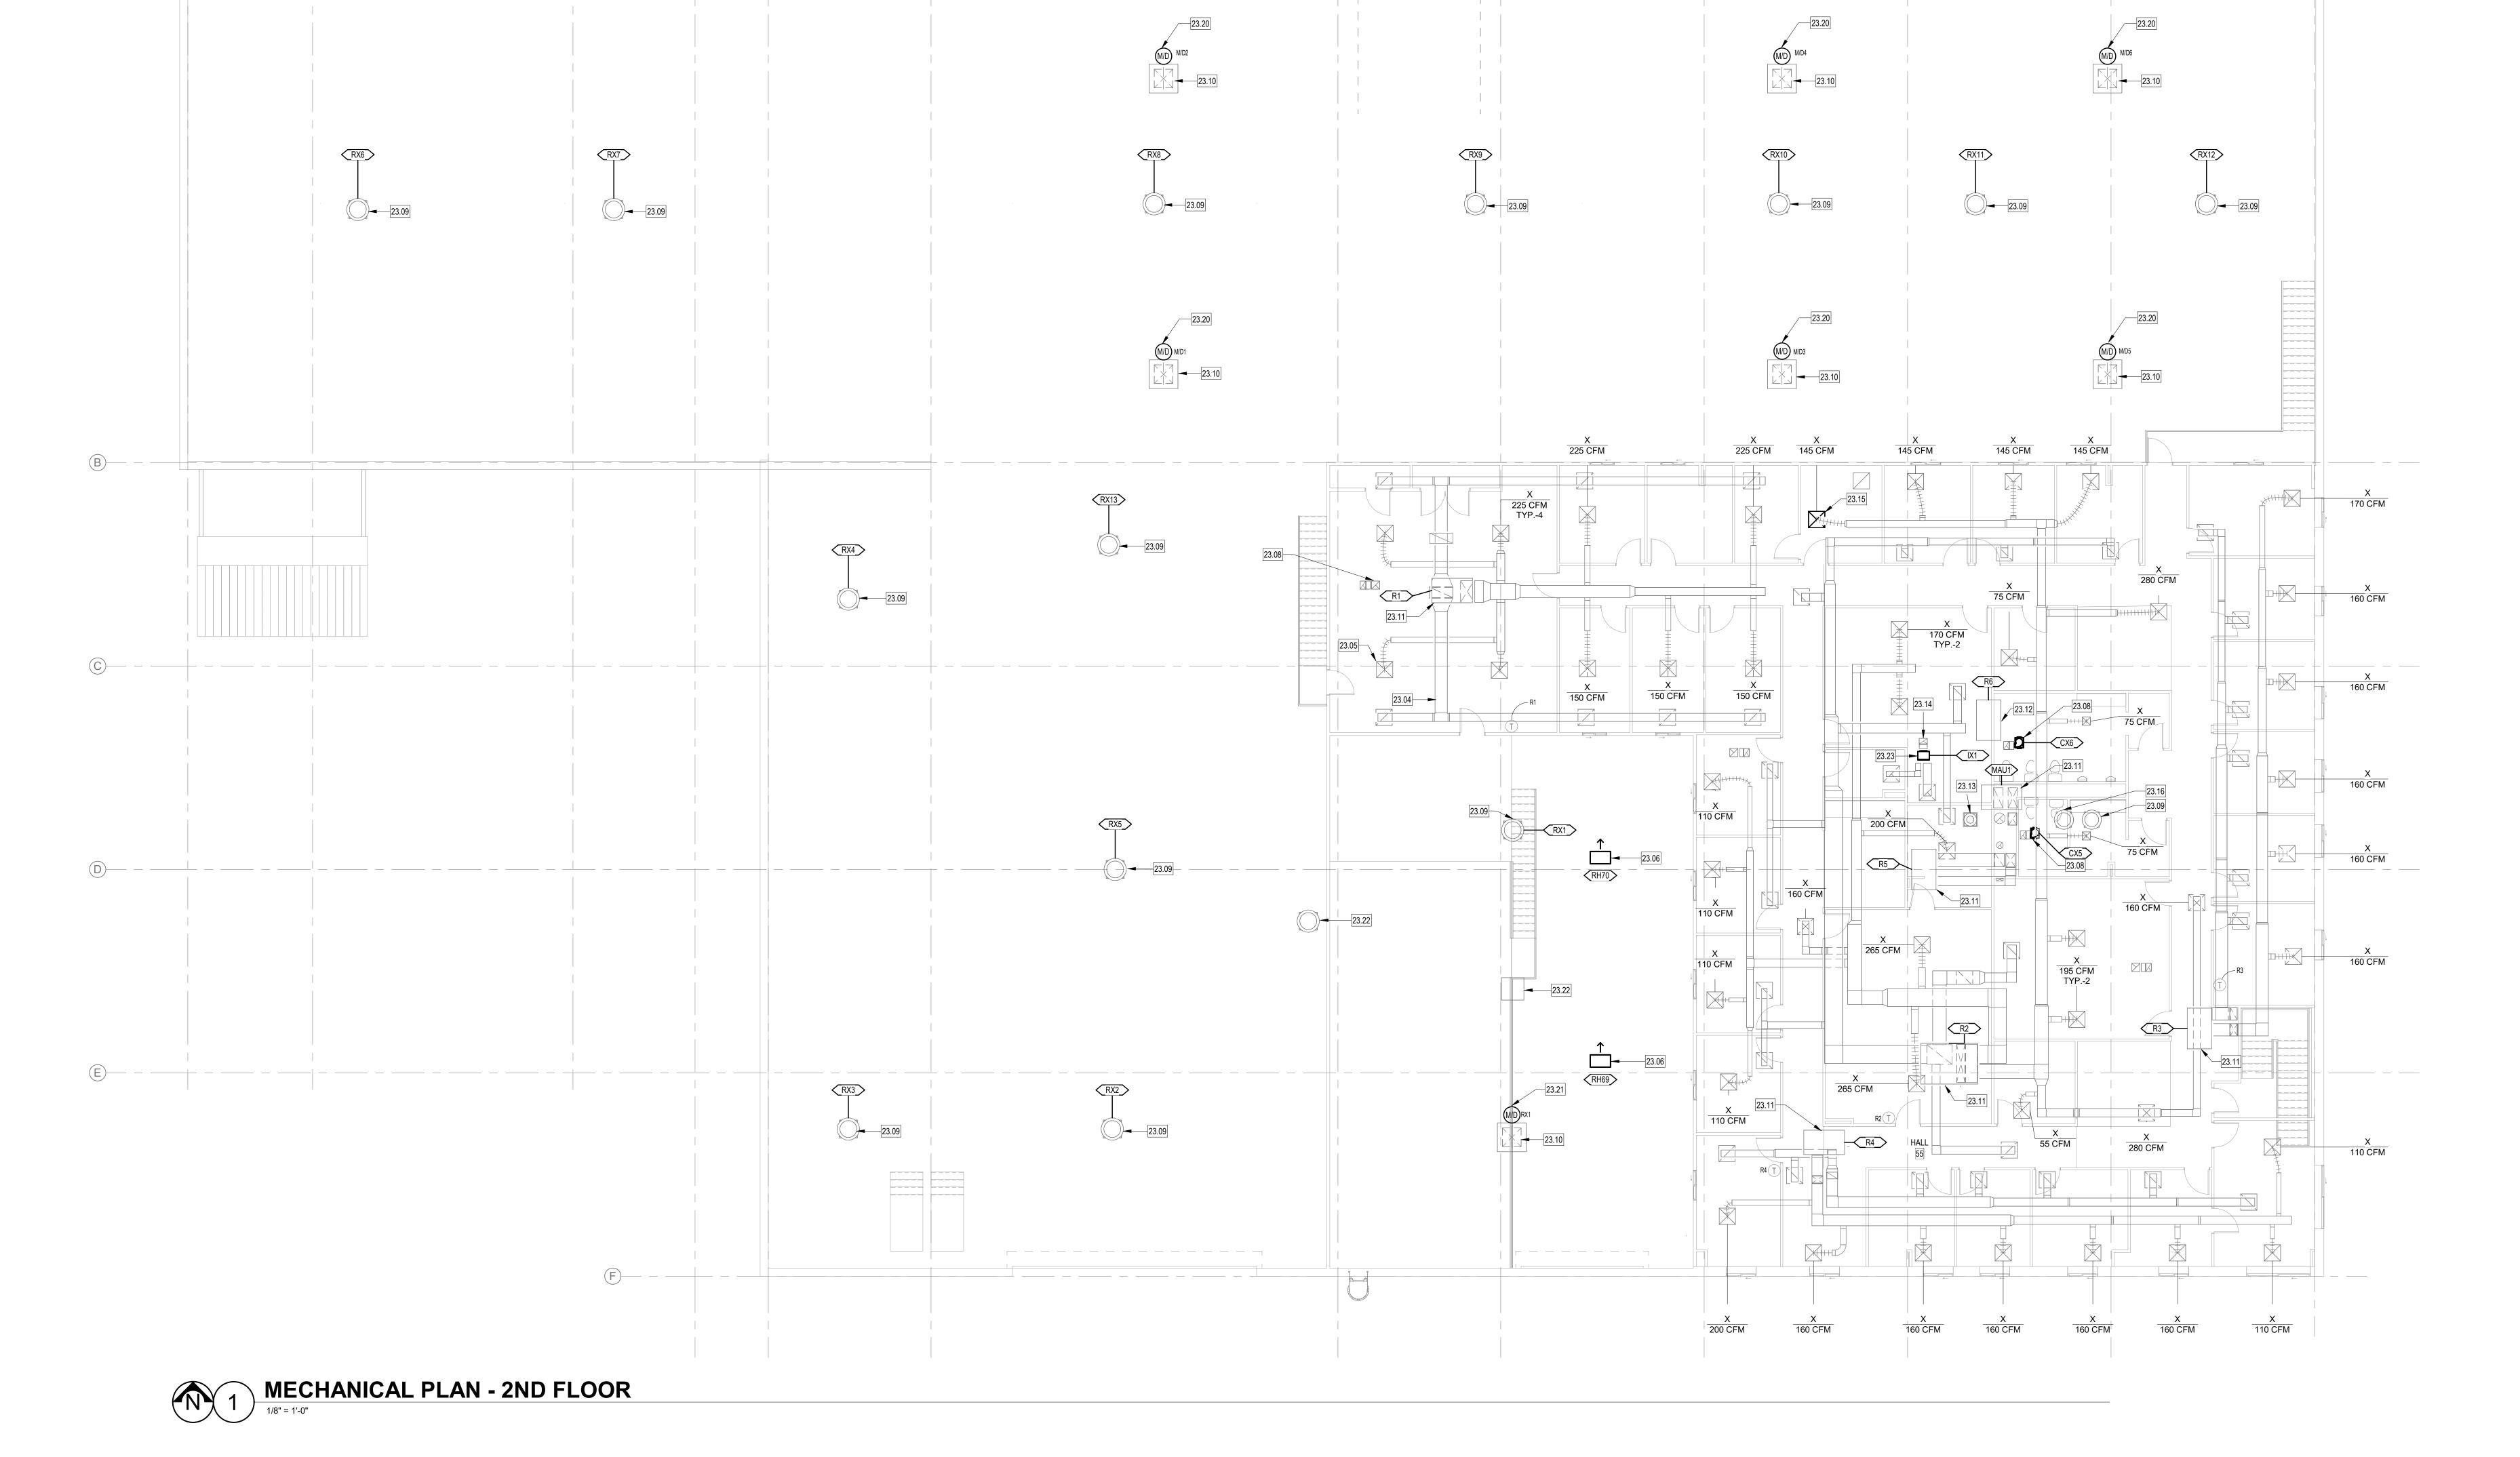

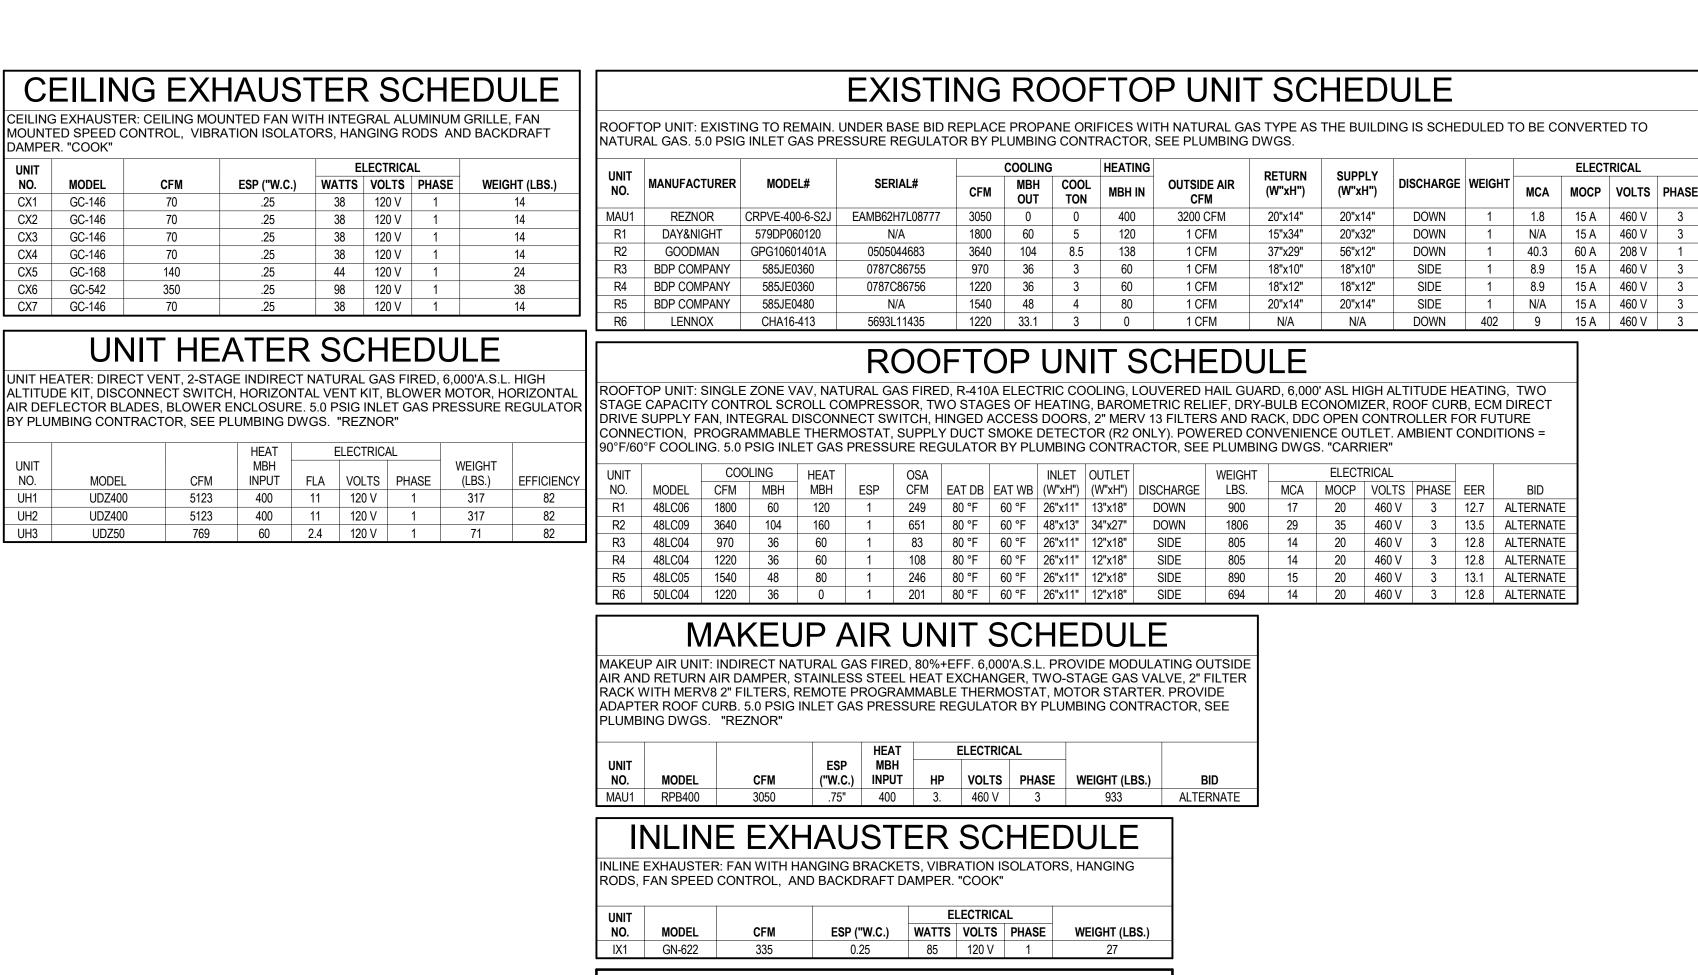

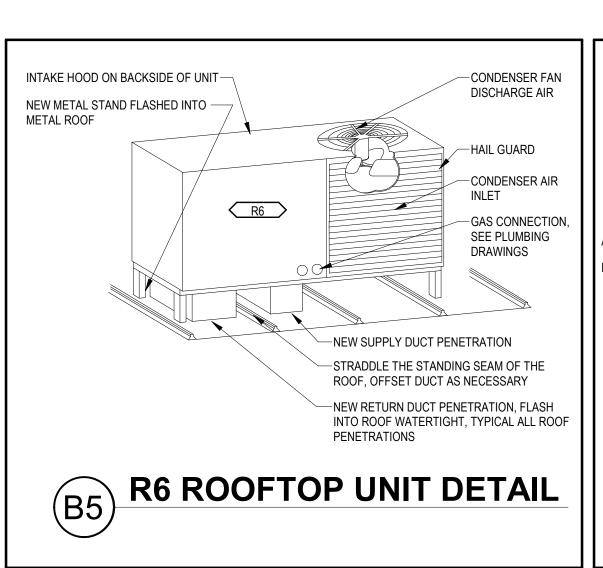

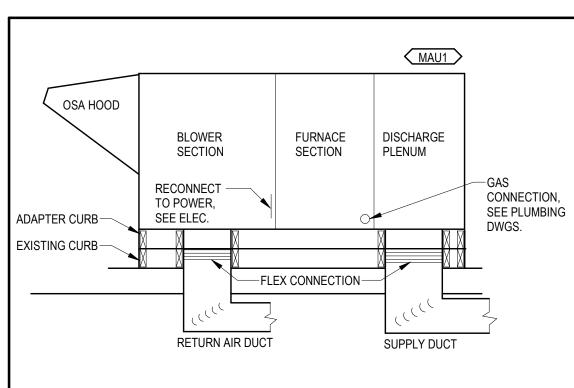



"RUSKIN" MODEL TED50


DAMPER SCHEDULE

MOTORIZED DAMPER: EXTRUDED ALUMINUM OPPOSED BLADE WITH BELIMO 24V POWER, 0-10VDC CONTROL INPUT, SPRING RETURN ACTUATOR. CLASS 1 MAXIMUM LEAKAGE RATE AT 4


CFM PER SQ.FT. AT 1.0"W.C. AMCA 500D TESTED. PROVIDE 120V/24V TRANSFORMER.

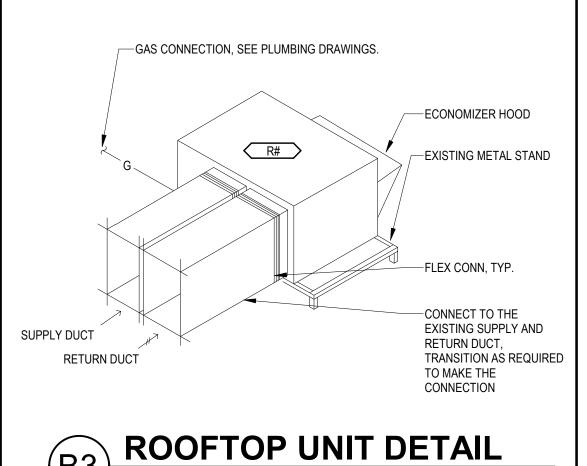

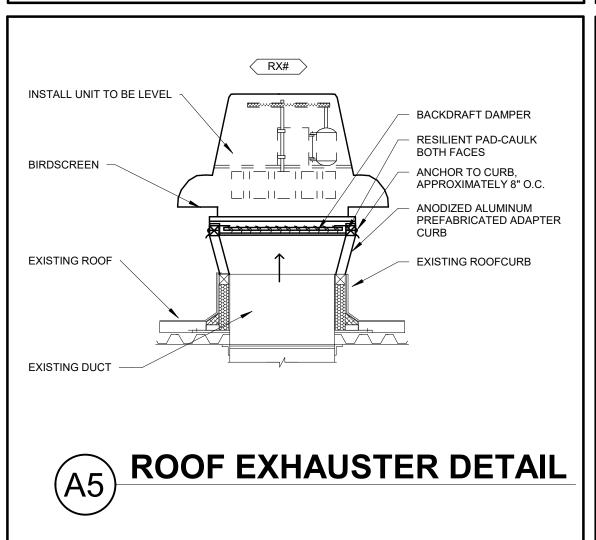

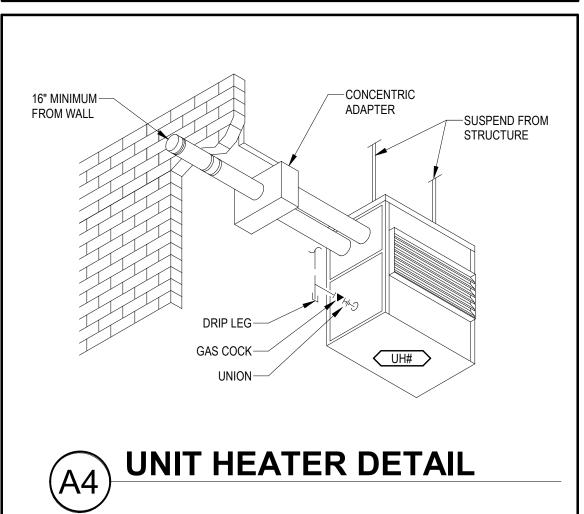

B4 MAKEUP AIR UNIT DETAIL

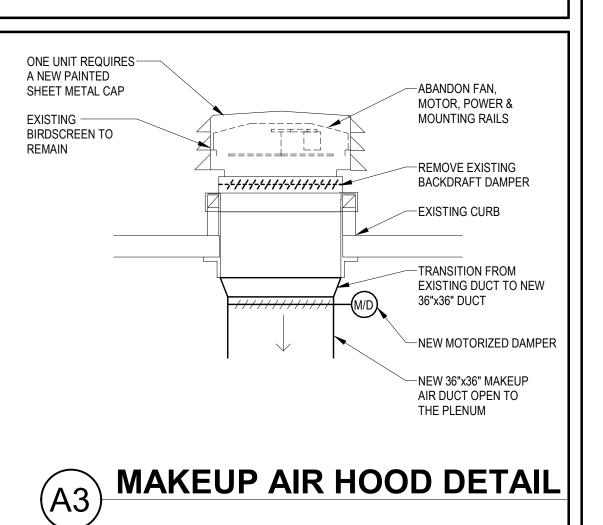

MEC LINE WEIGHT	HANICAL LEGEND DESCRIPTION
LIIVL VVEIGITI	
	THIN LINE AND GRAY SCALE INDICATE EXISTING TO REMAIN
	WIDE DASHED INDICATE EXISTING TO BE DEMOLISHED
	SOLID BLACK INDICATES NEW
SYMBOL	DESCRIPTION
<u>A2-6</u> CFM	DIFFUSER DESIGNATION
1	UNIT DESIGNATION
23.00	KEYED NOTE
•	POINT OF CONNECTION
CD	CONDENSATE DRAIN
HWS	HEATING WATER SUPPLY
HWR——	HEATING WATER RETURN
&	2-WAY VALVE
\$	3-WAY VALVE
đ	BALL VALVE
ф	BUTTERFLY VALVE
I∇I	PLUG, CIRCUIT SETTER OR GAUGE COCK
I ▼ I	GAS COCK
₽	THERMOMETER
17	CHECK VALVE
₩	RELIEF VALVE
۲	STRAINER
IļI	UNION
×	GATE VALVE
及	SOLENOID
Ø	PRV
147	REDUCED PRESSURE BACKFLOW PREVENTER
10"x10"	CLEAR INSIDE DUCT DIMENSION (NEW)
+++++++	FLEX DUCT
\boxtimes	SUPPLY DIFFUSER (TAGGED WITH DIFFUSER DESIGNATION)
	RETURN GRILLE (TAGGED WITH DIFFUSER DESIGNATION)
L L	EXHAUST GRILLE (TAGGED WITH DIFFUSER DESIGNATION)
$\parallel \rightarrow$	SIDEWALL SUPPLY
←	SIDEWALL RETURN
N/D(F/D(F/S)(V/D)	MOTORIZED, FIRE, FIRE/SMOKE OR VOLUME DAMPER
$\mathbb{P} \mathbb{P}$	THERMOSTAT, REMOTE SENSOR OR HUMIDISTAT
\$=- \D _{co}	DUCT SMOKE/ CARBON MONOXIDE DETECTOR
→ − co	CARBON DIOXIDE SENSOR

 	SIDEWALL RETURN
M/D(F/D(F/S)(V/D)	MOTORIZED, FIRE, FIRE/SMOKE OR VOLUME DAMPER
$ \mathcal{P} \mathcal{P} \mathcal{P} $	THERMOSTAT, REMOTE SENSOR OR HUMIDISTAT
\$=- \O _co	DUCT SMOKE/ CARBON MONOXIDE DETECTOR
(CO2)	CARBON DIOXIDE SENSOR
ABBREVIATION	DESCRIPTION
ADJ	ADJUSTABLE
APD	AIR PRESSURE DROP
CFM	CUBIC FEET PER MINUTE
DB	DRY BULB TEMPERATURE
EA	EXHAUST AIR
EAT	ENTERING AIR TEMPERATURE
ESP	EXTERNAL STATIC PRESSURE
EWT	ENTERING WATER TEMPERATURE
GPM	GALLONS PER MINUTE
GWR	GEOTHERMAL WATER RETURN
GWS	GEOTHERMAL WATER SUPPLY
HWR	HEATING WATER RETURN
HWS	HEATING WATER SUPPLY
LAT	LEAVING AIR TEMPERATURE
LWT	LEAVING WATER TEMPERATURE
OA	OUTSIDE AIR
PG	PROPYLENE GLYCOL
RA	RETURN AIR
RZ	RADIANT ZONE
SA	SUPPLY AIR
SMR	SNOWMELT RETURN
SMS	SNOWMELT SUPPLY
SZ	SNOWMELT ZONE
TSP	TOTAL STATIC PRESSURE
WB	WET BULB TEMPERATURE
WPD	WATER PRESSURE DROP
XFER	TRANSFER AIR

MECHANICAL GENERAL NOTES

1. PROVIDE AND INSTALL ALL MATERIAL AND EQUIPMENT AS REQUIRED BY UPC, UMC, NFPA, LIFE SAFETY CODE, GAS CODE, AND ALL OTHER LOCAL CODES AND ORDINANCES THAT APPLY. WHERE THERE IS A DISCREPANCY BETWEEN THE CODES OR ORDINANCES AND THE DRAWINGS, THE MORE STRINGENT APPLICATION SHALL APPLY.

- 2. LAYOUT AND INSTALL COMPLETE AND FUNCTIONAL MECHANICAL SYSTEMS, INCLUDING TEMPORARY CUTOFF OF EXISTING UTILITIES. PERFORM ALL CUTTING, PATCHING, AND REPAIR ASSOCIATED WITH
- INSTALLING THE SYSTEMS.

 3. VIBRATIONALLY ISOLATE ALL EQUIPMENT AND PIPING FROM THE BUILDING STRUCTURE.
- COORDINATE TO ASSURE THAT AS QUIET AN OPERATING SYSTEM AS POSSIBLE IS INSTALLED.

 4. VERIFY THAT DUCTWORK AND ALL EQUIPMENT SPECIFIED IS CORRECT FOR FIELD INSTALLATION BEFORE ORDERING OR FABRICATING. PROVIDE A WRITTEN REQUEST FOR INFORMATION TO THE ENGINEER FOR A RULING ON HOW TO PROCEED IF CONDITIONS EXIST THAT WILL NOT ALLOW FOR
- 5. PROVIDE ALL DUCTWORK CONNECTIONS AND TRANSITIONS AT LOCATIONS WHERE REQUIRED. CONSTRUCT ALL TRANSITIONS AND CONNECTIONS ACCORDING TO SMACNA STANDARDS.

THE INSTALLATION OF THE EQUIPMENT SPECIFIED.

ELECTRICAL DRAWINGS.

165C17D(VF)

RH109 RH110

RIHN 100

- 6. TESTING AND BALANCING AGENCY: PROVIDE AND INSTALL SHEAVES AND ALL EQUIPMENT NECESSARY TO PROVIDE PLUS OR MINUS 10% OF THE CFM REQUIRED FROM EACH DIFFUSER AND
- PROVIDE AND INSTALL ALL MECHANICAL EQUIPMENT, TRANSFORMERS, RELAYS, AND OTHER ELEMENTS NECESSARY FOR A COMPLETE OPERATING SYSTEM. COMPLETE ALL 24 VOLT CONTROL WIRING AND EQUIPMENT TO THE ABOVE. ALL LINE VOLTAGE WIRING TO THE ABOVE SHALL BE

COMPLETED BY THE ELECTRICAL CONTRACTOR. REFER TO COORDINATION SCHEDULE ON

- ALTER DIMENSIONS OF THE DUCTWORK IN THE CEILING SPACE FROM SIZES INDICATED ON THE DRAWINGS AT SPECIFIC LOCATIONS WHEN NECESSARY TO FIT THE DUCTWORK IN THE SPACE PROVIDED. REROUTE DUCTWORK IN CEILING SPACE TO AVOID OTHER MECHANICAL EQUIPMENT, LIGHT FIXTURES, ETC. MAINTAIN THE SAME FREE AREA AND SUBMIT PROPOSED CHANGES TO THE ENGINEER FOR APPROVAL. BE RESPONSIBLE FOR VERIFYING SPACE LIMITATIONS BEFORE DUCTWORK FABRICATION AND MAKE CHANGES ACCORDINGLY. PROVIDE ALL NECESSARY TRANSITIONS
- 9. COORDINATE ALL PROPOSED ROOF PENETRATIONS WITH GENERAL CONTRACTOR AND ARCHITECT AND RELOCATE IF NECESSARY.
- 10. PROVIDE ONE UNION AT ALL VALVES OR SUITABLE MEANS OF REMOVAL WITHOUT PIPE CUTTING ON SCREWED PIPING. UNIONS REQUIRED ON COPPER PIPING AT EQUIPMENT CONNECTION.
- REVIEW ALL EQUIPMENT AND MATERIALS TO BE REMOVED WITH THE OWNER FOR SALVAGE RIGHTS. EQUIPMENT AND MATERIAL NOT SELECTED BY OWNER TO BE DISPOSED OF BY THIS CONTRACTOR.
 PROVIDE TURNING VANES IN ALL RECTANGULAR DUCTWORK AT ELBOWS AND TEES WHETHER SHOWN ON THE PLANS OR NOT. THE ONLY EXCEPTION IS RETURN AIR TRANSFER DUCTS BETWEEN
- 13. FIELD VERIFY THAT ALL NEW DUCTWORK CAN FIT WITHIN THE SPACE PROVIDED PRIOR TO FABRICATING ANY NEW DUCTWORK. EXISTING DUCTWORK SHOWN IS FROM ORIGINAL AS-BUILT DRAWINGS AND NOT ALL CONFIGURATIONS HAVE BEEN VERIFIED.
- 4. PROVIDE DUCT SMOKE DETECTORS, SHUTDOWN CONTROLS, AND AUDIBLE/VISIBLE NOTIFICATION DEVICES PER MECHANICAL CODE AND BUILDING CODE WHERE REQUIRED. COORDINATE CONNECTION TO BUILDING FIRE ALARM SYSTEM, IF REQUIRED.
- 5. ALL PENETRATIONS THROUGH FIRE RATED WALLS OR ASSEMBLIES SHALL BE COMPLETED IN A MANNER THAT MAINTAINS THE FIRE RATING OF THE WALL OR ASSEMBLY.

R	ADIANT HE	EATER	SC	HE	DUL	E.
DIRECT SP.	EATER: DIRECT FIRED, NAT ARK IGNITION, 120V/24V THI EREGULATOR BY PLUMBING	ERMOSTAT AND	TRANS	FORMER	R. 5.0 PSIG II	AS VALVE, NLET GAS
				ELECTRI	CAL	WEIGHT
UNIT NO.	MODEL	HEAT MBH INPUT	VOLTS	PHASE	WATTS	(LBS.)
RH30	RIHN 30	30	120 V	1	16.8	30
RH31	RIHN 30	30	120 V	1	16.8	30
RH32	RIHN 30	30	120 V	1	16.8	30
RH33	RIHN 30	30	120 V	1	16.8	30
RH61	RIHN 60	60	120 V	1	16.8	30
RH62	RIHN 60	60	120 V	1	16.8	30
RH63	RIHN 60	60	120 V	1	16.8	30
RH64	RIHN 60	60	120 V	1	16.8	30
RH65	RIHN 60	60	120 V	1	16.8	30
RH66	RIHN 60	60	120 V	1	16.8	30
RH67	RIHN 60	60	120 V	1	16.8	30
RH68	RIHN 60	60	120 V	1	16.8	30
RH69	RIHN 60	60	120 V	1	16.8	30
RH70	RIHN 60	60	120 V	1	16.8	30
RH100	RIHN 100	100	120 V	1	16.8	36
RH101	RIHN 100	100	120 V	1	16.8	36
RH102	RIHN 100	100	120 V	1	16.8	36
RH103	RIHN 100	100	120 V	1	16.8	36
RH104	RIHN 100	100	120 V	1	16.8	36
RH105	RIHN 100	100	120 V	1	16.8	36
RH106	RIHN 100	100	120 V	1	16.8	36
RH107	RIHN 100	100	120 V	1	16.8	36

100 100 100 REYNOLDS ASH
+ ASSOCIATES

ARCHITECTURE
ENGINEERING

1140 MAIN AVE, STE. B DURANGO, CO 81301 (970) 259 - 7494 FAX (970) 259 - 7492 262 PAGOSA STREET, STE. 200 P.O. BOX 96 PAGOSA SPRINGS, CO 81147


RA-AE.COM

REYNOLDS ASH + ASSOCIATES, P.C.

EXPRESSLY RESERVES THE COMMON LAW COPYRIGHT
AND OTHER PROPERTY RIGHTS IN THESE PLANS. THESE
PLANS ARE NOT TO BE CHANGED OR COPIED IN ANY
FORM OR MANNER WHATSOEVER NOR ARE THEY TO BE
ASSIGNED TO ANY THIRD PARTY WITHOUT FIRST

OBTAINING WRITTEN PERMISSION AND CONSENT OF THE ARCHITECT OF RECORD.

THE USE OF THESE PLANS AND SPECIFICATIONS SHALL BE RESTRICTED TO THE ORIGINAL SITE FOR WHICH THEY WERE PREPARED AND PUBLICATION TEHREOF IS EXPRESSLY LIMITED TO SUCH USE. FEDERAL LAW PROHIBITS THE REPRODUCTION, DISPLAY, SALE OR OTHER DISPOSITION OF THIS DOCUMENT WITHOUT THE EXPRESS WRITTEN CONSENT OF RA+A ARCHITECTS, P.C.

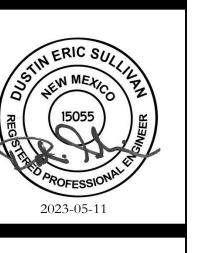

SAN JUAN COUNTY INDUSTI PARK

16.8 16.8 16.8

120 V 1 120 V 1

120 V 1

JOB. NO.: 2229 DATE: 2023-05-15 DRAWN BY: ME&E

PL

1130,


ISSUE RECORD: 2023-02-17 100% SD 2023-03-31 DD 2023-05-15 CD

REVISIONS:

1601

MECHANICAL LEGEND, NOTES, AND DETAILS

26.17 OWNER HAS \$60,000 ALLOWANCE FOR ELECTRICAL UPGRADE AND REPAIRS TO WASHBAY AND PAINT BOOTH, BEGINNING WITH BUILDING FEEDS, SERVICE, AND MDP.

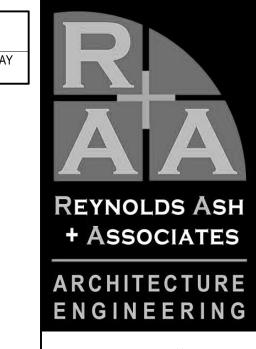



1140 MAIN AVE, STE. B DURANGO, CO 81301 (970) 259 - 7494 FAX (970) 259 - 7492

262 PAGOSA STREET, STE. 200 P.O. BOX 96 PAGOSA SPRINGS, CO 81147 RA-AE.COM

REYNOLDS ASH + ASSOCIATES, P.C.
EXPRESSLY RESERVES THE COMMON LAW COPYRIGHT
AND OTHER PROPERTY RIGHTS IN THESE PLANS. THESE
PLANS ARE NOT TO BE CHANGED OR COPIED IN ANY
FORM OR MANNER WHATSOEVER NOR ARE THEY TO BE
ASSIGNED TO ANY THIRD PARTY WITHOUT FIRST
OBTAINING WRITTEN PERMISSION AND CONSENT OF
THE ARCHITECT OF RECORD.

THE USE OF THESE PLANS AND SPECIFICATIONS SHALL BE RESTRICTED TO THE ORIGINAL SITE FOR WHICH THEY WERE PREPARED AND PUBLICATION TEHREOF IS EXPRESSLY LIMITED TO SUCH USE. FEDERAL LAW PROHIBITS THE REPRODUCTION, DISPLAY, SALE OR OTHER DISPOSITION OF THIS DOCUMENT WITHOUT THE EXPRESS WRITTEN CONSENT OF RA+A ARCHITECTS, P.C.

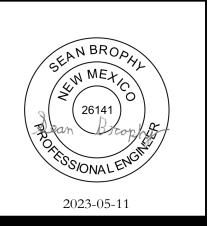

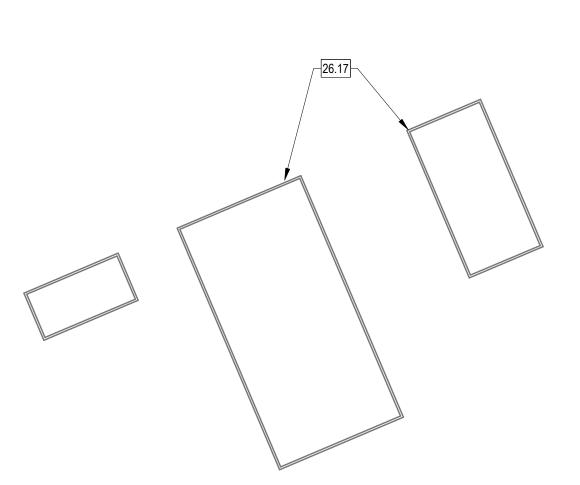

1 ELECTRICAL SITE PLAN
1" = 30'-0"

JOB. NO.: 2229 DATE: 2023-05-15 Drawn by: Me&e

ISSUE RECORD: 2023-02-17 100% SD 2023-03-31 DD 2023-05-15 CD

SAN JUAN COUNTY INDUSTRIAL PARK

RD 1130, LA PLATA, NEW MEXICO 87418

REVISIONS:

E100

ELECTRICAL SITE PLAN

LIGHTING: PROVIDE ADDITIONAL CONDUCTORS AND PATHWAYS AS REQUIRED FOR LIGHTING AND CONTROLS WORK.

PATCH AND REPAIR: PATCH, PAINT, AND REPAIR ALL SURFACES AFFECTED BY LIGHTING REPLACEMENT PER ARCHITECT. PROVIDE NEW 2X4 CEILING TILES WHERE FIXTURES ARE


KEYED NOTES

- 26.01 EXISTING 2X4 LAY-IN FLUORESCENT T12 FIXTURES TO BE REPLACED WITH NEW LAY-IN LEI LIGHTING. EXISTING SURFACE MOUNT FLUORESCENT T12 FIXTURES TO BE REPLACED WITH NEW
- SURFACE-MOUNT LED LIGHTING. EXISTING LOW-BAY FIXTURES TO BE REPLACED WITH NEW LED PENDANT-MOUNT LOW-BAY
- EXISTING EXTERIOR WALLPACKS TO BE REPLACED WITH NEW LED WALL-PACKS. EXISTING BATTERY-BACKUP EGRESS LIGHTING TO BE REPLACED WITH NEW LED BATTER'
- BACKUP EGRESS LIGHTING. EXISTING 8' WALL-MOUNT STRIPLIGHTS TO BE REPLACED WITH NEW LED STRIP LIGHTS. EXISTING EXIT SIGNS TO BE REPLACED WITH NEW BATTERY-BACKUP LED EXIT SIGNS.
- EXISTING WET-LISTED STRIP LIGHT TO BE REPLACED WITH NEW WET LISTED LED STRIP
- EXISTING 4' FLUORSCENT WALL-MOUNT TO BE REPLACED WITH NEW LED ABOVE-MIRROR

+ ASSOCIATES **ARCHITECTURE** ENGINEERING

1140 MAIN AVE, STE. B DURANGO, CO 81301 (970) 259 - 7494 FAX (970) 259 - 7492 262 PAGOSA STREET, STE. 200 PAGOSA SPRINGS, CO 81147 RA-AE.COM

EXPRESSLY RESERVES THE COMMON LAW COPYRIGH AND OTHER PROPERTY RIGHTS IN THESE PLANS. THESE PLANS ARE NOT TO BE CHANGED OR COPIED IN ANY FORM OR MANNER WHATSOEVER NOR ARE THEY TO BE ASSIGNED TO ANY THIRD PARTY WITHOUT FIRST OBTAINING WRITTEN PERMISSION AND CONSENT OF THE ARCHITECT OF RECORD. THE USE OF THESE PLANS AND SPECIFICATIONS SHALL BE RESTRICTED TO THE ORIGINAL SITE FOR WHICH THEY WERE PREPARED AND PUBLICATION TEHREOF IS EXPRESSLY LIMITED TO SUCH USE. FEDERAL LAW PROHIBITS THE REPRODUCTION, DISPLAY, SALE OR OTHER DISPOSITION OF THIS DOCUMENT WITHOUT EXPRESS WRITTEN CONSENT OF RA+A ARCHITECTS, P.C.

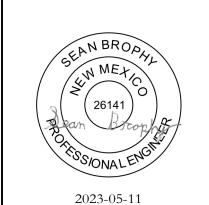


2023-05-11

ISSUE RECORD: 2023-02-17 100% SD 2023-03-31 DD 2023-05-15 CD

REVISIONS:

ELECTRICAL LIGHTING DEMOLITION PLAN - 1ST

FLOOR

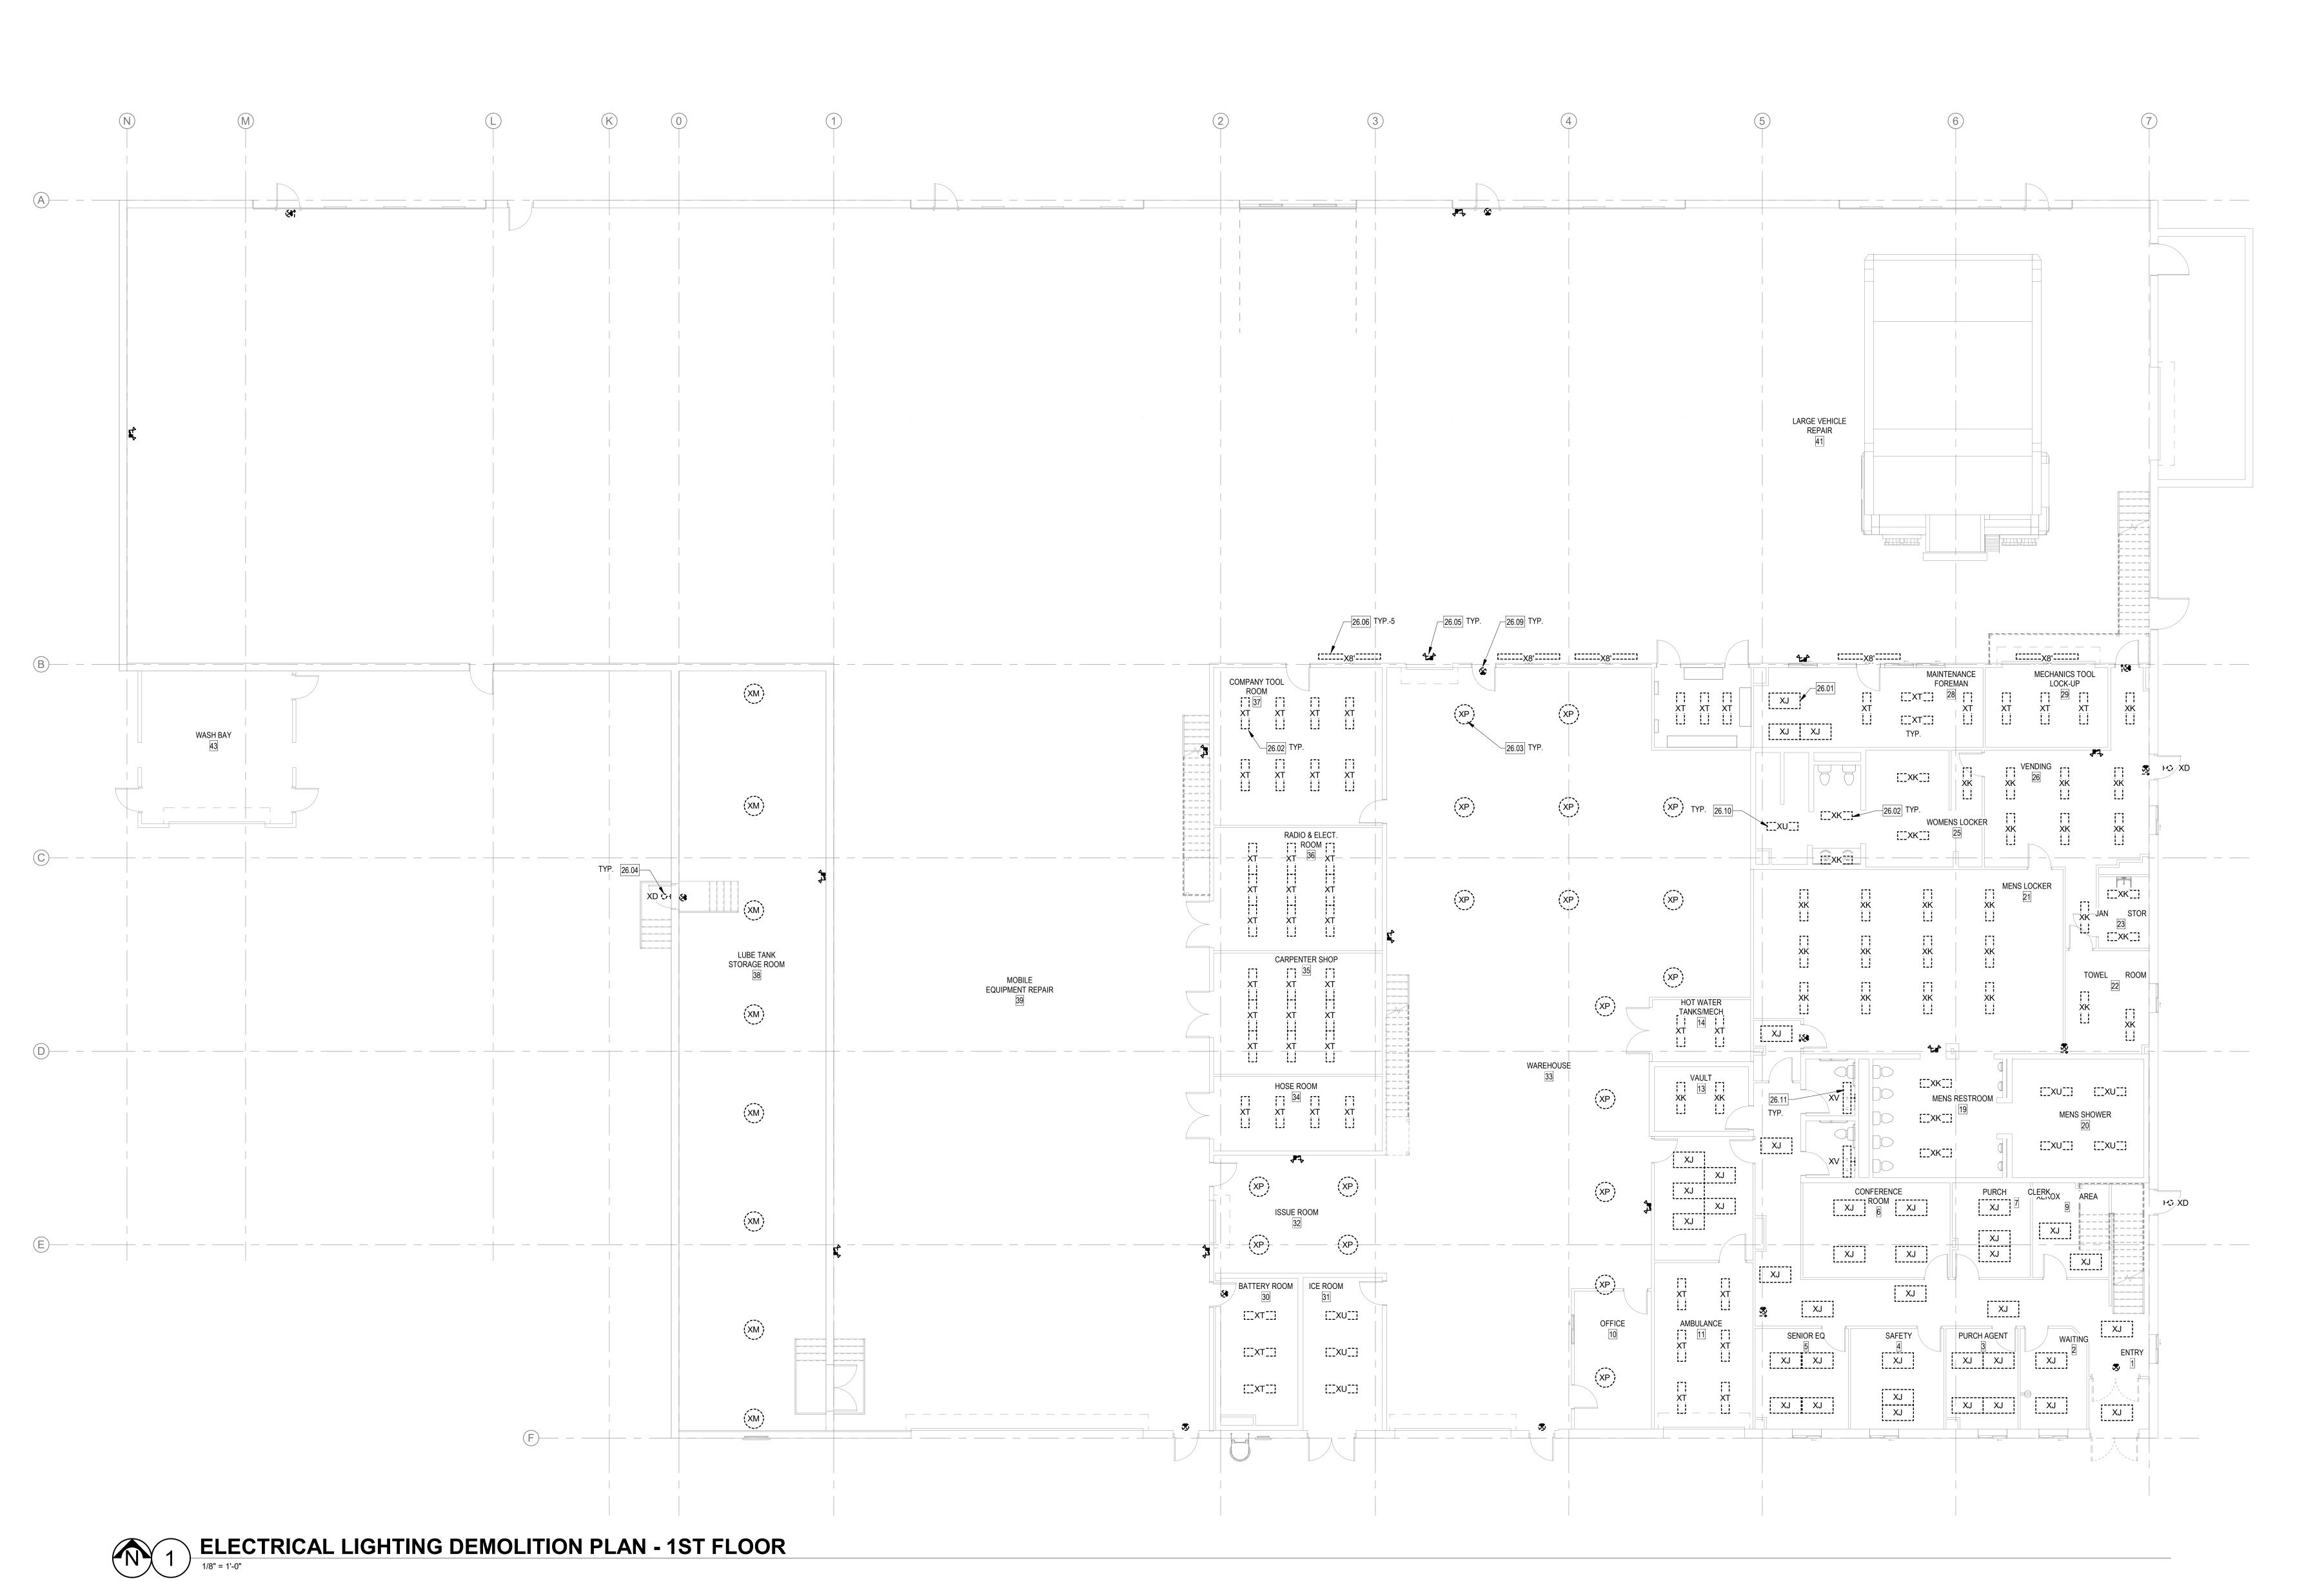

LIGHTING: PROVIDE ADDITIONAL CONDUCTORS AND PATHWAYS AS REQUIRED FOR LIGHTING AND CONTROLS WORK. PATCH AND REPAIR: PATCH, PAINT, AND REPAIR ALL SURFACES AFFECTED BY LIGHTING

REPLACEMENT PER ARCHITECT. PROVIDE NEW 2X4 CEILING TILES WHERE FIXTURES ARE

KEYED NOTES

- 26.01 EXISTING 2X4 LAY-IN FLUORESCENT T12 FIXTURES TO BE REPLACED WITH NEW LAY-IN LEI LIGHTING.
- EXISTING SURFACE MOUNT FLUORESCENT T12 FIXTURES TO BE REPLACED WITH NEW SURFACE-MOUNT LED LIGHTING. EXISTING LOW-BAY FIXTURES TO BE REPLACED WITH NEW LED PENDANT-MOUNT LOW-BAY
- LIGHTING. EXISTING EXTERIOR WALLPACKS TO BE REPLACED WITH NEW LED WALL-PACKS.
- EXISTING BATTERY-BACKUP EGRESS LIGHTING TO BE REPLACED WITH NEW LED BATTERY BACKUP EGRESS LIGHTING.
- EXISTING COLUMN-MOUNT LIGHTING TO BE REMOVED. EXISTING HIGH-BAY LIGHTING TO REMAIN. REPLACEMENT AS ALTERNATE BID.
- EXISTING EXIT SIGNS TO BE REPLACED WITH NEW BATTERY-BACKUP LED EXIT SIGNS. FAN TO BE REPLACED. RECONNECT NEW FAN. REUSE CONDUCTORS AND OVERCURRENT PROTECTION.
- EQUIPMENT TO BE DEMOLISHED. REMOVE CIRCUIT BACK TO PANEL. IF EQUIPMENT IS ON SHARED CIRCUIT, MAINTAIN CONTINUITY OF CIRCUIT TO REMAINING EQUIPMENT.
- EXISTING MDF ROOM AND ISP DEMARC. EXISTING RACK AND CABLING TO REMAIN. PROVIDE NEW PATCH PANEL FOR CABLING SCOPE.
- TEST ALL EXISTING DATA CABLING FROM WALL JACKS TO PATCH PANEL. PROVIDE REPORT.




262 PAGOSA STREET, STE. 200


REYNOLDS ASH

+ ASSOCIATES

ARCHITECTURE

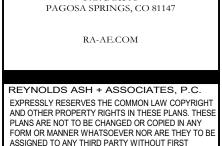

FORM OR MANNER WHATSOEVER NOR ARE THEY TO ASSIGNED TO ANY THIRD PARTY WITHOUT FIRST OBTAINING WRITTEN PERMISSION AND CONSENT OF THE ARCHITECT OF RECORD. THE USE OF THESE PLANS AND SPECIFICATIONS SHAL BE RESTRICTED TO THE ORIGINAL SITE FOR WHICH THEY WERE PREPARED AND PUBLICATION TEHREOF IS EXPRESSLY LIMITED TO SUCH USE. FEDERAL LAW PROHIBITS THE REPRODUCTION, DISPLAY, SALE OR OTHER DISPOSITION OF THIS DOCUMENT WITHOUT EXPRESS WRITTEN CONSENT OF RA+A ARCHITECTS, P.C.

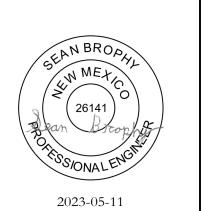


ISSUE RECORD:

2023-02-17 100% SD 2023-03-31 DD 2023-05-15 CD

REVISIONS:

FLOOR

ELECTRICAL LIGHTING DEMOLITION PLAN - 2ND

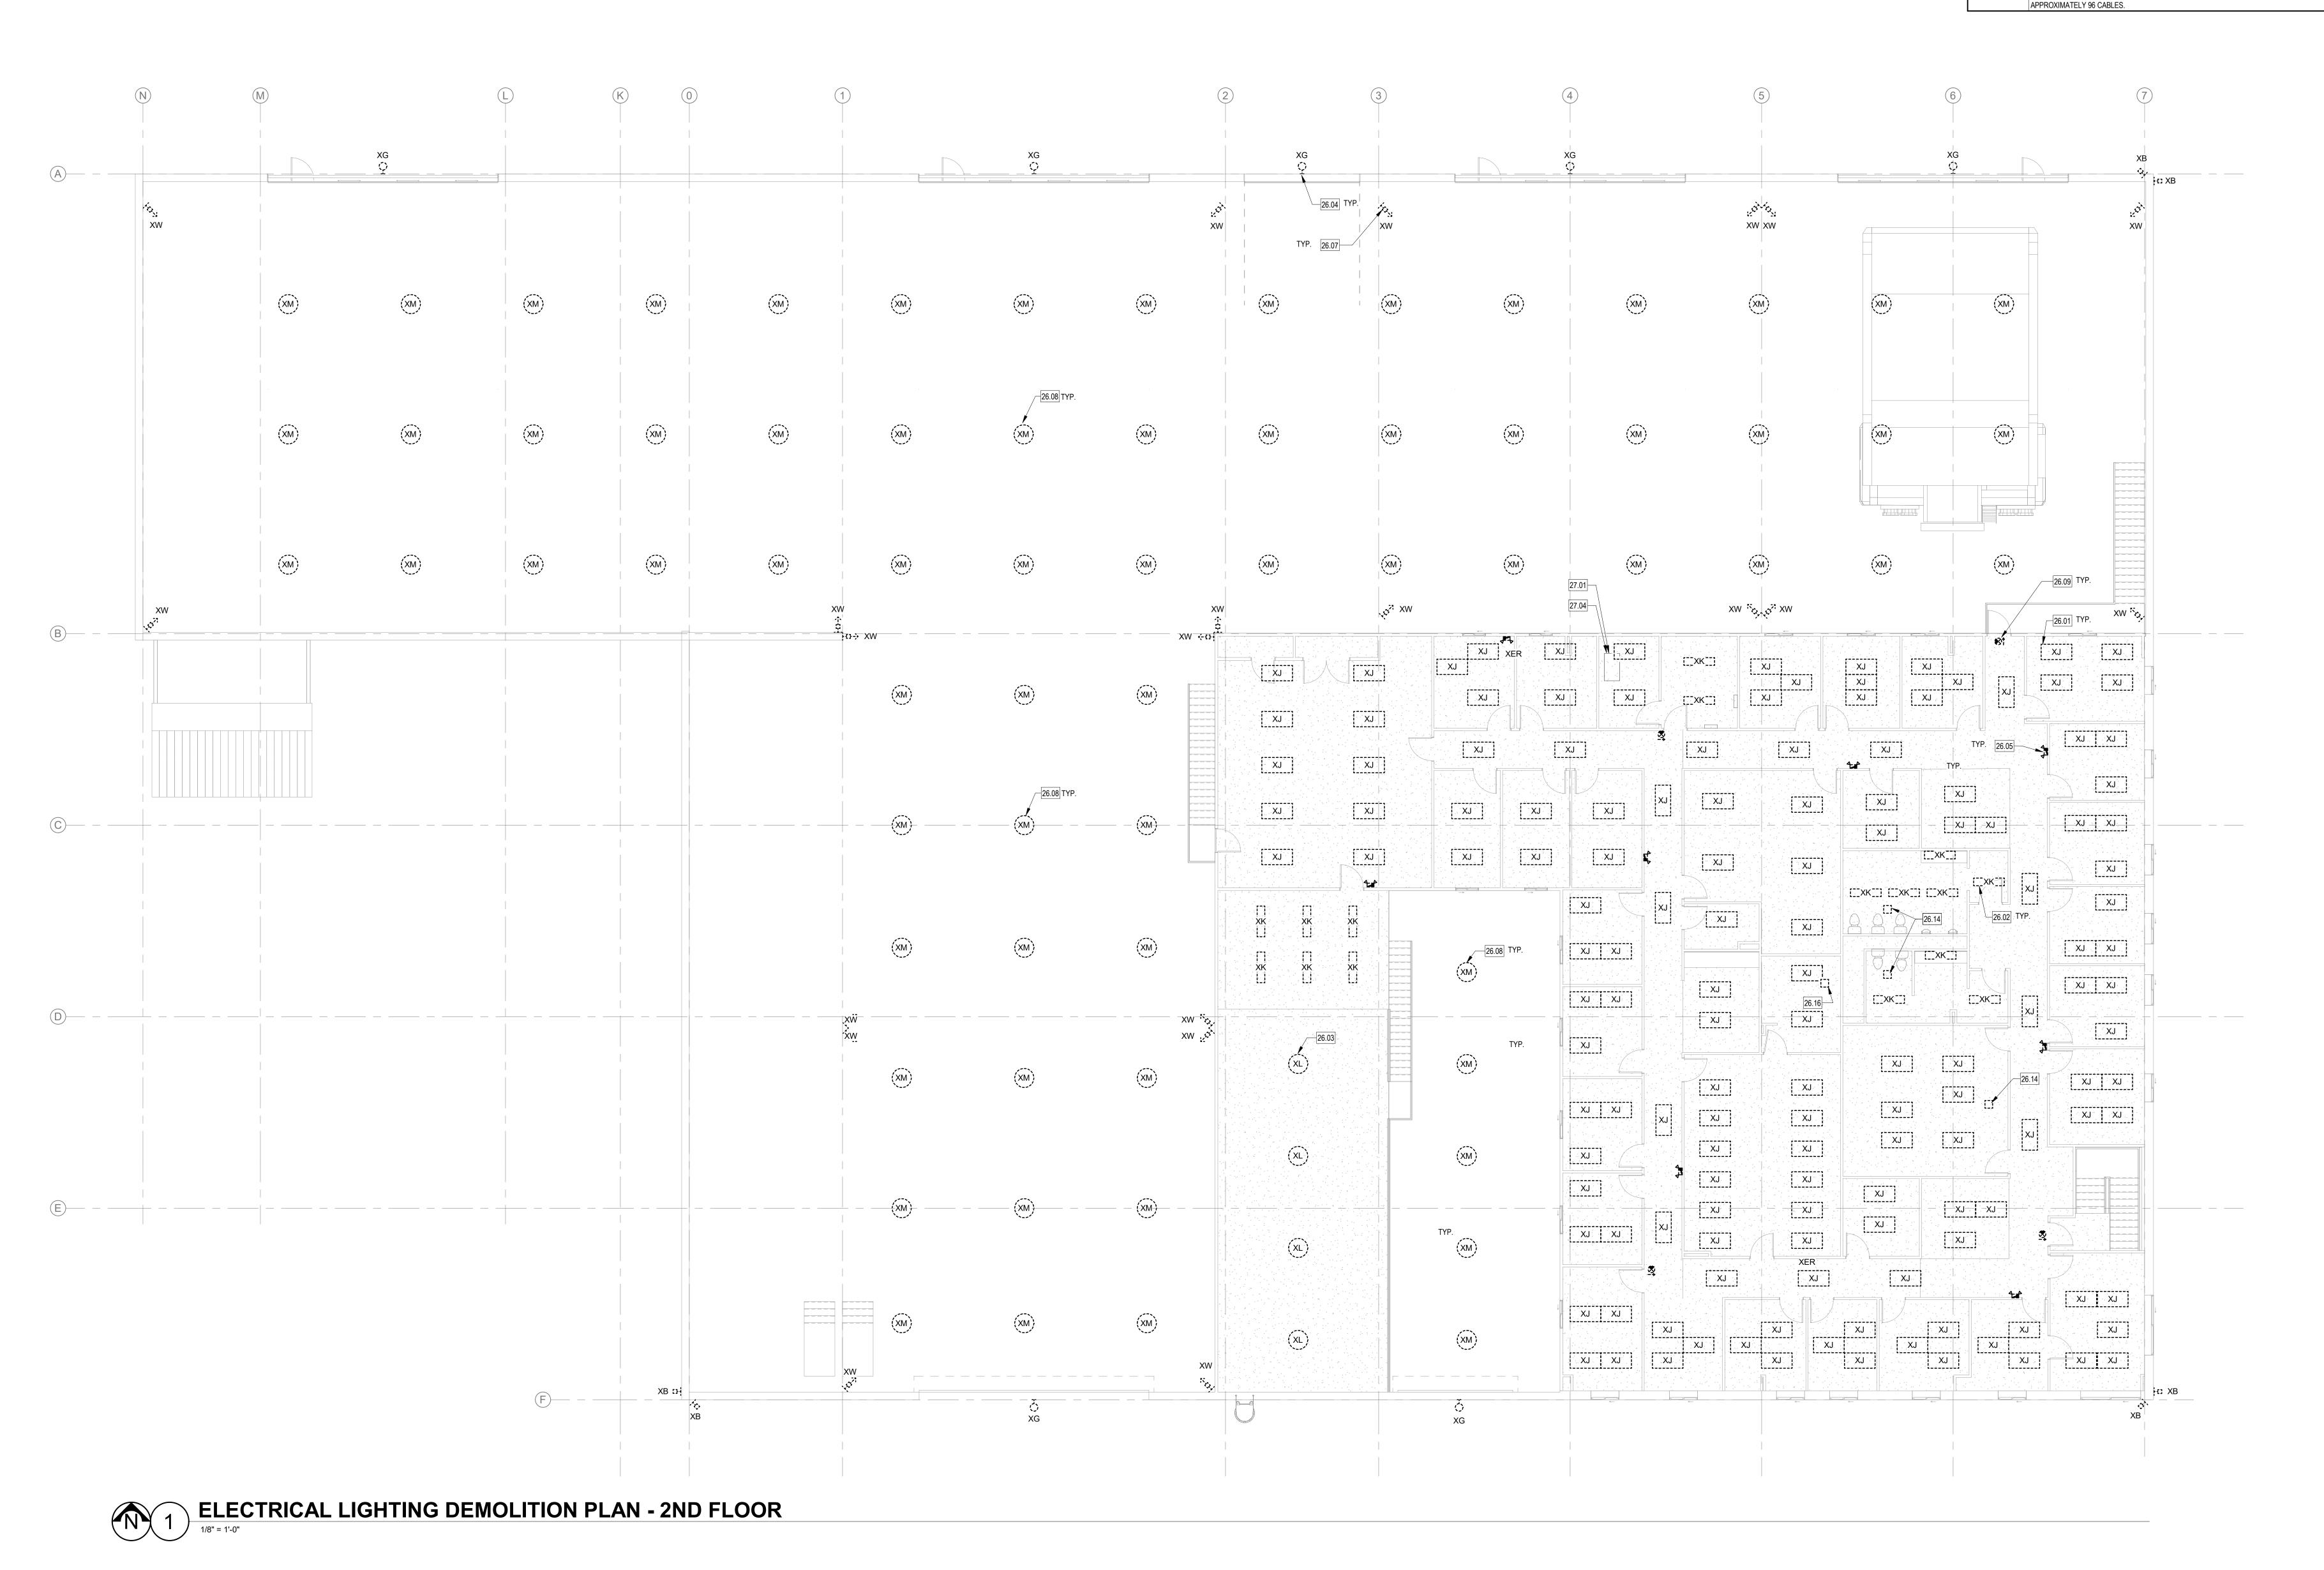

- LIGHTING: PROVIDE ADDITIONAL CONDUCTORS AND PATHWAYS AS REQUIRED FOR LIGHTING AND CONTROLS WORK.
- PATCH AND REPAIR: PATCH, PAINT, AND REPAIR ALL SURFACES AFFECTED BY LIGHTING REPLACEMENT PER ARCHITECT. PROVIDE NEW 2X4 CEILING TILES WHERE FIXTURES ARE NOT BEING REPLACED.

P

EM E

- **KEYED NOTES** 26.18 ALTERNATE BID: PROVIDE 120V CIRCUIT TO J-BOX ABOVE CEILING FOR FUTURE ADA OPERATOR AND DOOR CONTROLS. CONNECT TO LOCAL RECEPTACLE CIRCUIT. PREP DOOR FRAMES FOR FUTURE ACCESS CONTROL. SEE TYPICAL DOOR PATHWAY DETAIL. PROVIDE NEW CIRCUIT FOR ELECTRIC WATER COOLER. ROUTE CIRCUIT BACK TO PANEL DP-11 ON 2ND FLOOR. PROVIDE NEW 20A/1P BREAKER.
- PROVIDE TWO CAT6A CABLES FROM EACH WIRELESS ACCESS POINT BACK TO A NEW PATCH-PANEL IN THE MDF ROOM. PROVIDE WEATHERPROOF 2-GANG BOX AND COVER AT APPROX 12' ABOVE GRADE FOR FUTURE SECURITY CAMERA. PROVIDE CAT6 CABLE BACK TO IDF ROOM. PROVIDE 10'

SERVICE LOOP IN IDF ROOM. PROVIDE 2' SERVICE LOOP IN WEATHERPROOF J-BOX.

+ ASSOCIATES **ARCHITECTURE** ENGINEERING

> 1140 MAIN AVE, STE. B DURANGO, CO 81301 (970) 259 - 7494 FAX (970) 259 - 7492 262 PAGOSA STREET, STE. 200 PAGOSA SPRINGS, CO 81147

> > RA-AE.COM

EXPRESSLY RESERVES THE COMMON LAW COPYRIGHT AND OTHER PROPERTY RIGHTS IN THESE PLANS. THESE PLANS ARE NOT TO BE CHANGED OR COPIED IN ANY FORM OR MANNER WHATSOEVER NOR ARE THEY TO BE ASSIGNED TO ANY THIRD PARTY WITHOUT FIRST OBTAINING WRITTEN PERMISSION AND CONSENT OF THE ARCHITECT OF RECORD. THE USE OF THESE PLANS AND SPECIFICATIONS SHALL BE RESTRICTED TO THE ORIGINAL SITE FOR WHICH THEY WERE PREPARED AND PUBLICATION TEHREOF IS EXPRESSLY LIMITED TO SUCH USE. FEDERAL LAW PROHIBITS THE REPRODUCTION, DISPLAY, SALE OR OTHER DISPOSITION OF THIS DOCUMENT WITHOUT THE EXPRESS WRITTEN CONSENT OF RA+A ARCHITECTS, P.C.




ISSUE RECORD: 2023-02-17 100% SD 2023-03-31 DD

2023-05-15 CD

REVISIONS:

ELECTRICAL LIGHTING PLAN - 1ST FLOOR

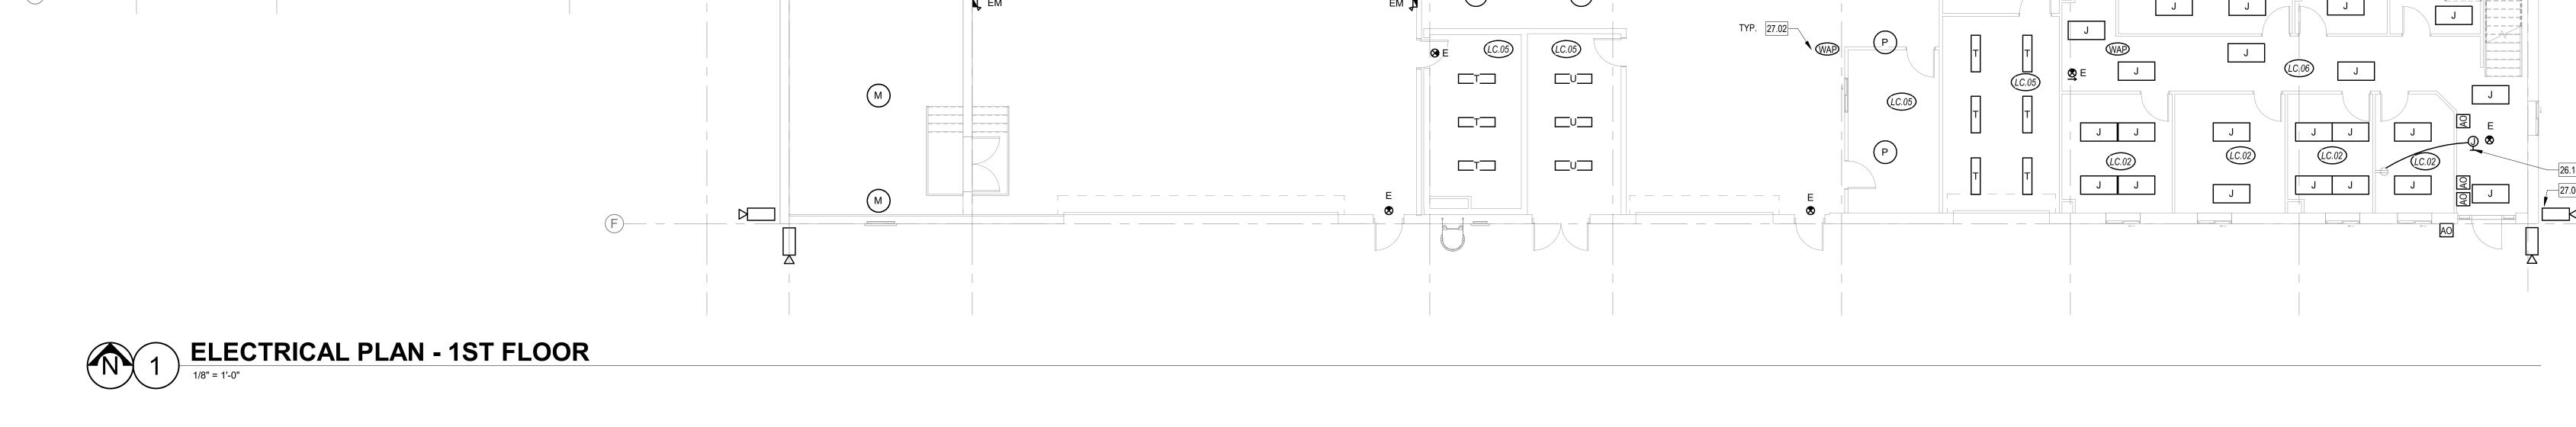


M

LIGHTING: PROVIDE ADDITIONAL CONDUCTORS AND PATHWAYS AS REQUIRED FOR LIGHTING AND CONTROLS WORK.

PATCH AND REPAIR: PATCH, PAINT, AND REPAIR ALL SURFACES AFFECTED BY LIGHTING REPLACEMENT PER ARCHITECT. PROVIDE NEW 2X4 CEILING TILES WHERE FIXTURES ARE **KEYED NOTES**

26.19 PROVIDE NEW CIRCUIT FOR ELECTRIC WATER COOLER. ROUTE CIRCUIT BACK TO PANEL DP-11 ON 2ND FLOOR. PROVIDE NEW 20A/1P BREAKER. PROVIDE TWO CAT6A CABLES FROM EACH WIRELESS ACCESS POINT BACK TO A NEW PATCH-PANEL IN THE MDF ROOM.


PROVIDE WIRELESS ACCESS COVERAGE THROUGHOUT BAYS. NEW FIBER DEMARC. PROVIDE 1-1/2" CONDUIT FROM BUILDING ENTRY TO THIS LOCATION PROVIDE EMT IN ALL EXPOSED AREAS. ENT TUBING ABOVE LAY-IN CEILINGS IS ACCEPTABLE.

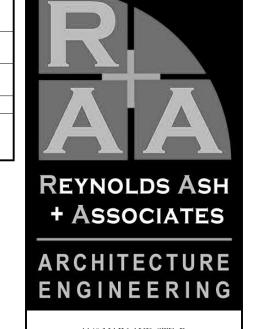

1140 MAIN AVE, STE. B DURANGO, CO 81301 (970) 259 - 7494 FAX (970) 259 - 7492 262 PAGOSA STREET, STE. 200 PAGOSA SPRINGS, CO 81147

RA-AE.COM

EXPRESSLY RESERVES THE COMMON LAW COPYRIGH AND OTHER PROPERTY RIGHTS IN THESE PLANS. THESE PLANS ARE NOT TO BE CHANGED OR COPIED IN ANY FORM OR MANNER WHATSOEVER NOR ARE THEY TO BE ASSIGNED TO ANY THIRD PARTY WITHOUT FIRST OBTAINING WRITTEN PERMISSION AND CONSENT OF THE ARCHITECT OF RECORD. THE USE OF THESE PLANS AND SPECIFICATIONS SHALL BE RESTRICTED TO THE ORIGINAL SITE FOR WHICH THEY WERE PREPARED AND PUBLICATION TEHREOF IS EXPRESSLY LIMITED TO SUCH USE. FEDERAL LAW PROHIBITS THE REPRODUCTION, DISPLAY, SALE OR OTHER DISPOSITION OF THIS DOCUMENT WITHOUT TO EXPRESS WRITTEN CONSENT OF RA+A ARCHITECTS, P.C.

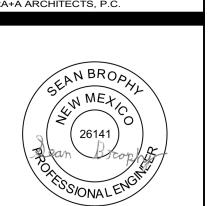


2023-05-11

ISSUE RECORD: 2023-02-17 100% SD 2023-03-31 DD

2023-05-15 CD

REVISIONS:

ELECTRICAL LIGHTING PLAN - 2ND FLOOR

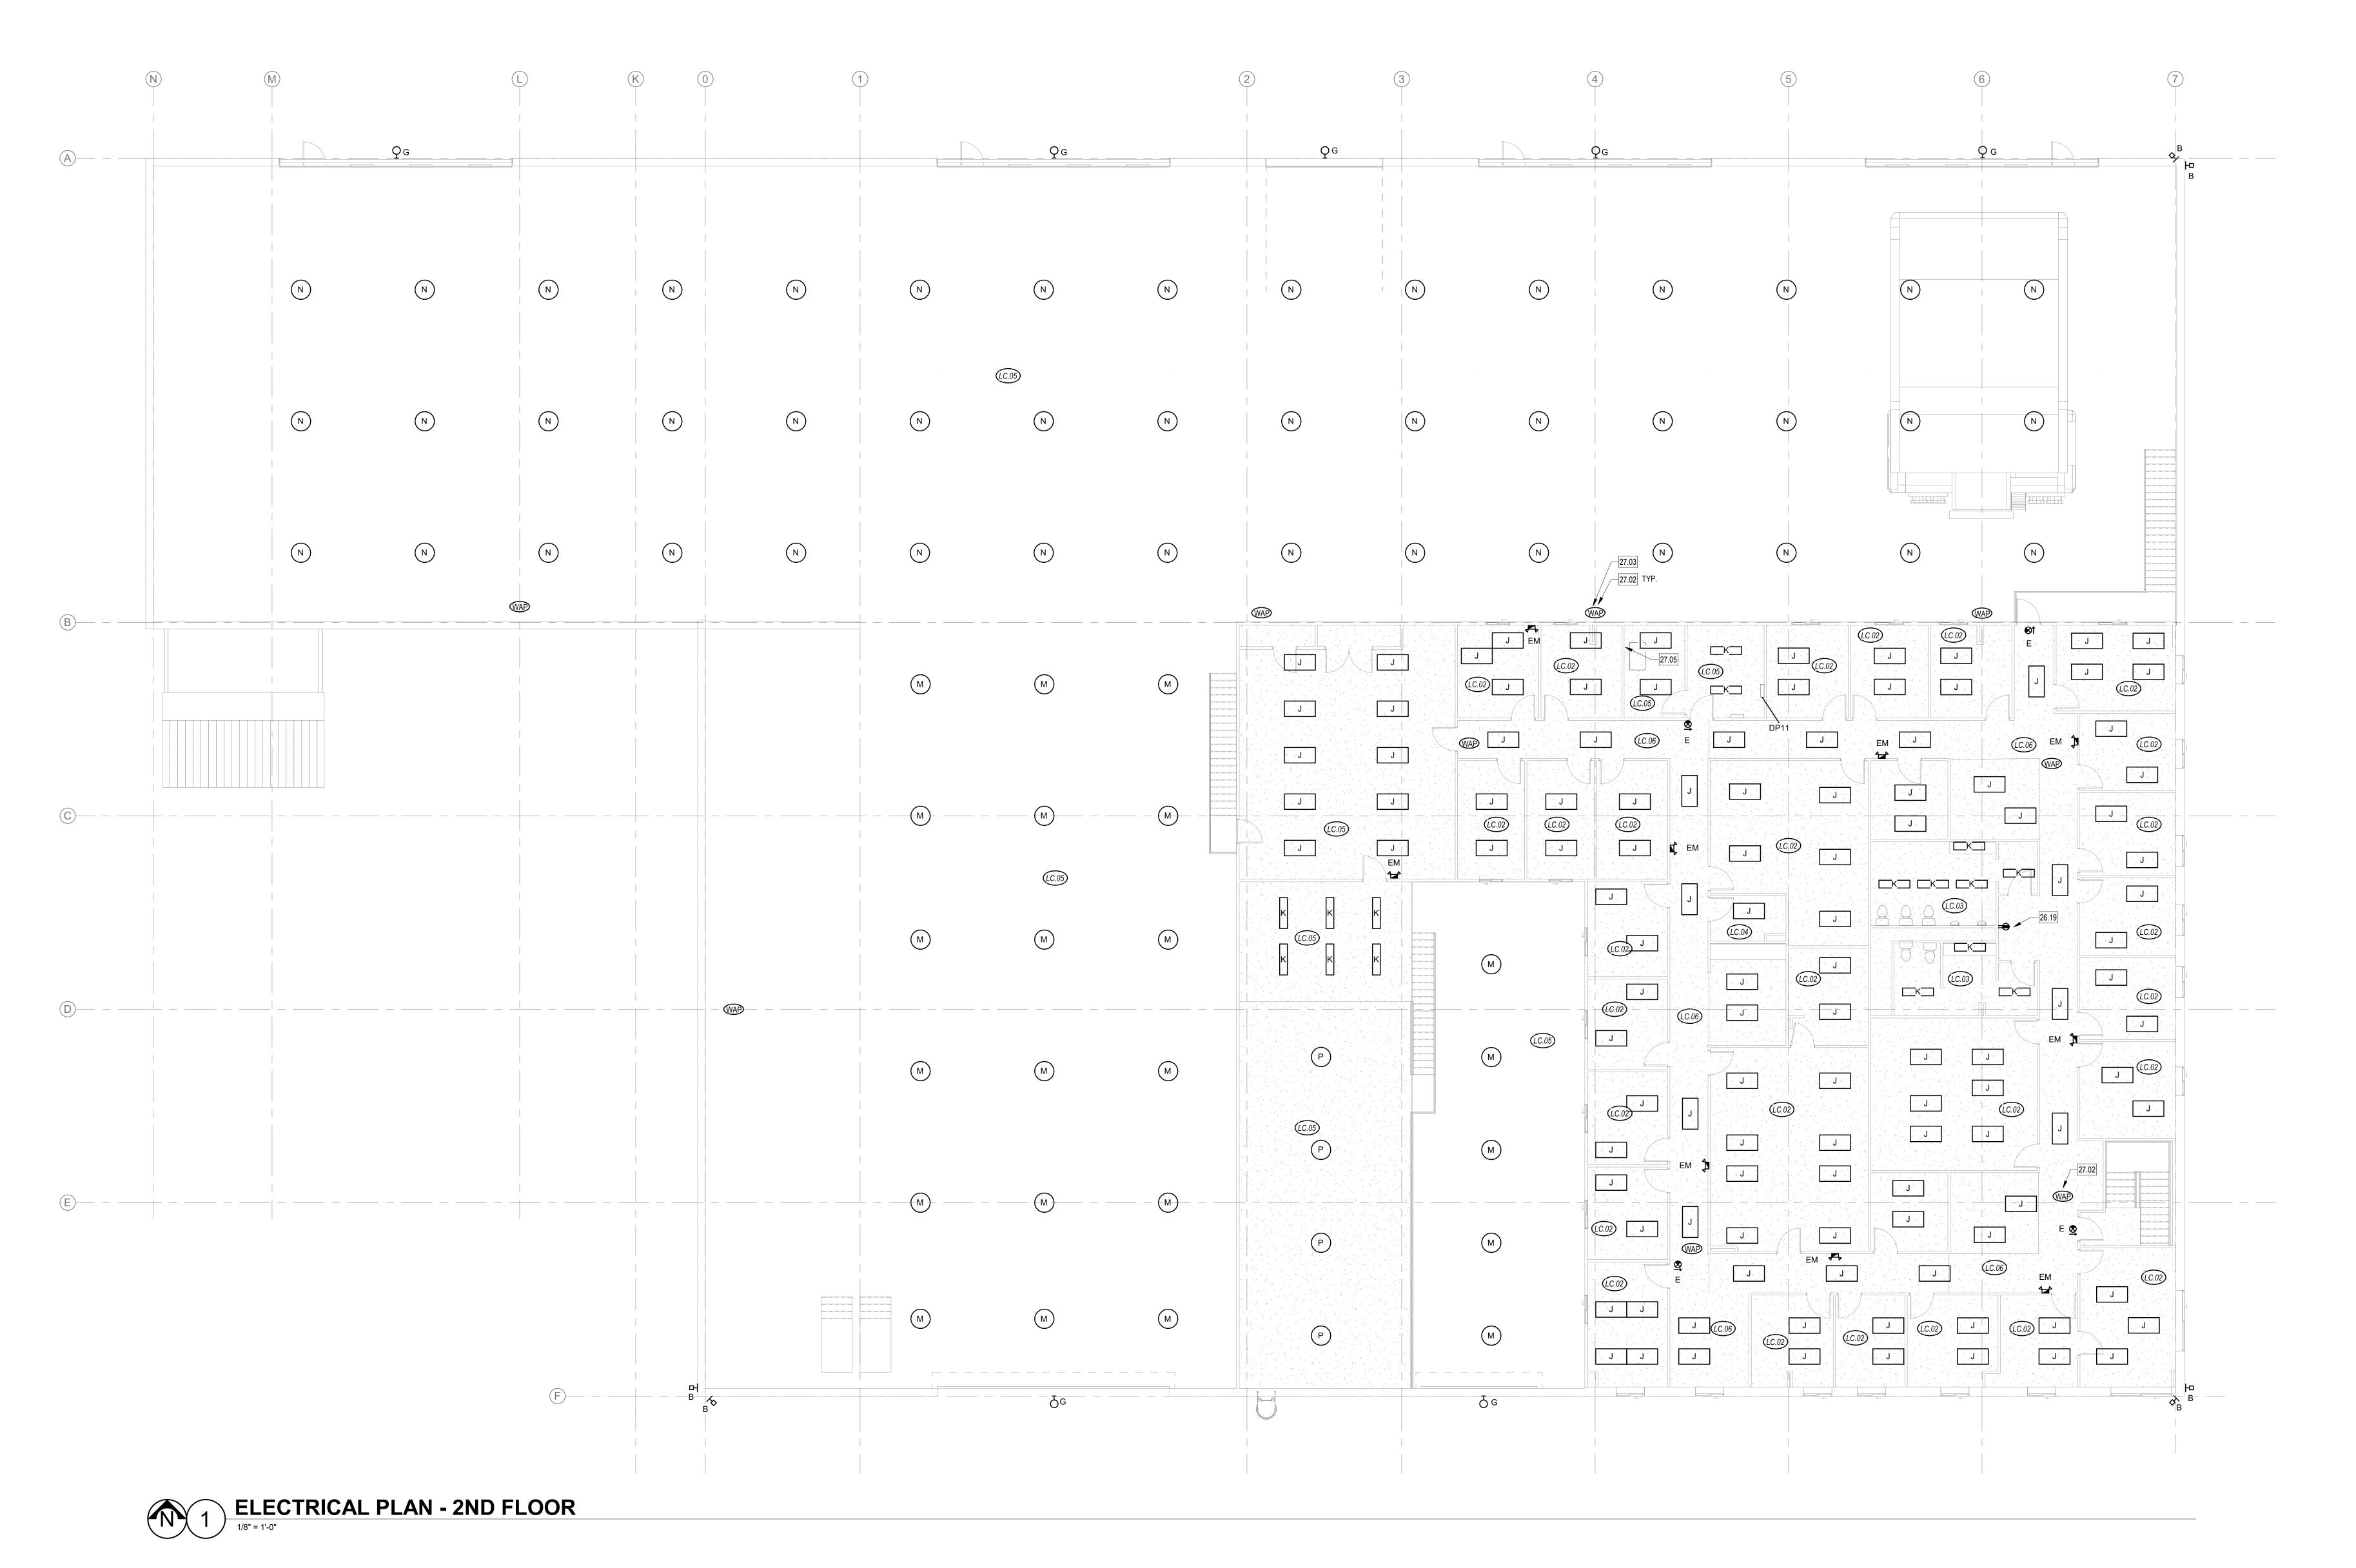

LIGHTING: PROVIDE ADDITIONAL CONDUCTORS AND PATHWAYS AS REQUIRED FOR LIGHTING AND CONTROLS WORK.


PATCH AND REPAIR: PATCH, PAINT, AND REPAIR ALL SURFACES AFFECTED BY LIGHTING REPLACEMENT PER ARCHITECT. PROVIDE NEW 2X4 CEILING TILES WHERE FIXTURES ARE **KEYED NOTES**

- 26.14 FAN TO BE REPLACED. RECONNECT NEW FAN. REUSE CONDUCTORS AND OVERCURRENT PROTECTION. GAS-FIRED UNIT HEATERS TO BE REPLACED, TYPICAL. RECONNECT CIRCUIT TO NEW UNIT
- EQUIPMENT TO BE DEMOLISHED. REMOVE CIRCUIT BACK TO PANEL. IF EQUIPMENT IS ON
- SHARED CIRCUIT, MAINTAIN CONTINUITY OF CIRCUIT TO REMAINING EQUIPMENT. CONNECT LINE VOLTAGE THERMOSTATS AND SWITCHES TO ALL MECHANICAL EQUIPMENT GAS-FIRED RADIANT HEATERS TO BE REPLACED, TYPICAL. RECONNECT CIRCUIT TO NEW RADIANT HEATER.

+ ASSOCIATES **ARCHITECTURE** ENGINEERING

> 1140 MAIN AVE, STE. B DURANGO, CO 81301 (970) 259 - 7494 FAX (970) 259 - 7492 262 PAGOSA STREET, STE. 200 PAGOSA SPRINGS, CO 81147 RA-AE.COM


EXPRESSLY RESERVES THE COMMON LAW COPYRIGHT AND OTHER PROPERTY RIGHTS IN THESE PLANS. THESE PLANS ARE NOT TO BE CHANGED OR COPIED IN ANY FORM OR MANNER WHATSOEVER NOR ARE THEY TO BE ASSIGNED TO ANY THIRD PARTY WITHOUT FIRST OBTAINING WRITTEN PERMISSION AND CONSENT OF THE ARCHITECT OF RECORD. THE USE OF THESE PLANS AND SPECIFICATIONS SHALL BE RESTRICTED TO THE ORIGINAL SITE FOR WHICH THEY WERE PREPARED AND PUBLICATION TEHREOF IS EXPRESSLY LIMITED TO SUCH USE. FEDERAL LAW PROHIBITS THE REPRODUCTION, DISPLAY, SALE OR OTHER DISPOSITION OF THIS DOCUMENT WITHOUT THE EXPRESS WRITTEN CONSENT OF RA+A ARCHITECTS, P.C.

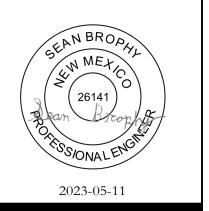

ISSUE RECORD: 2023-02-17 100% SD 2023-03-31 DD

2023-05-15 CD REVISIONS:

ELECTRICAL CONNECTIONS PLAN - 1ST FLOOR

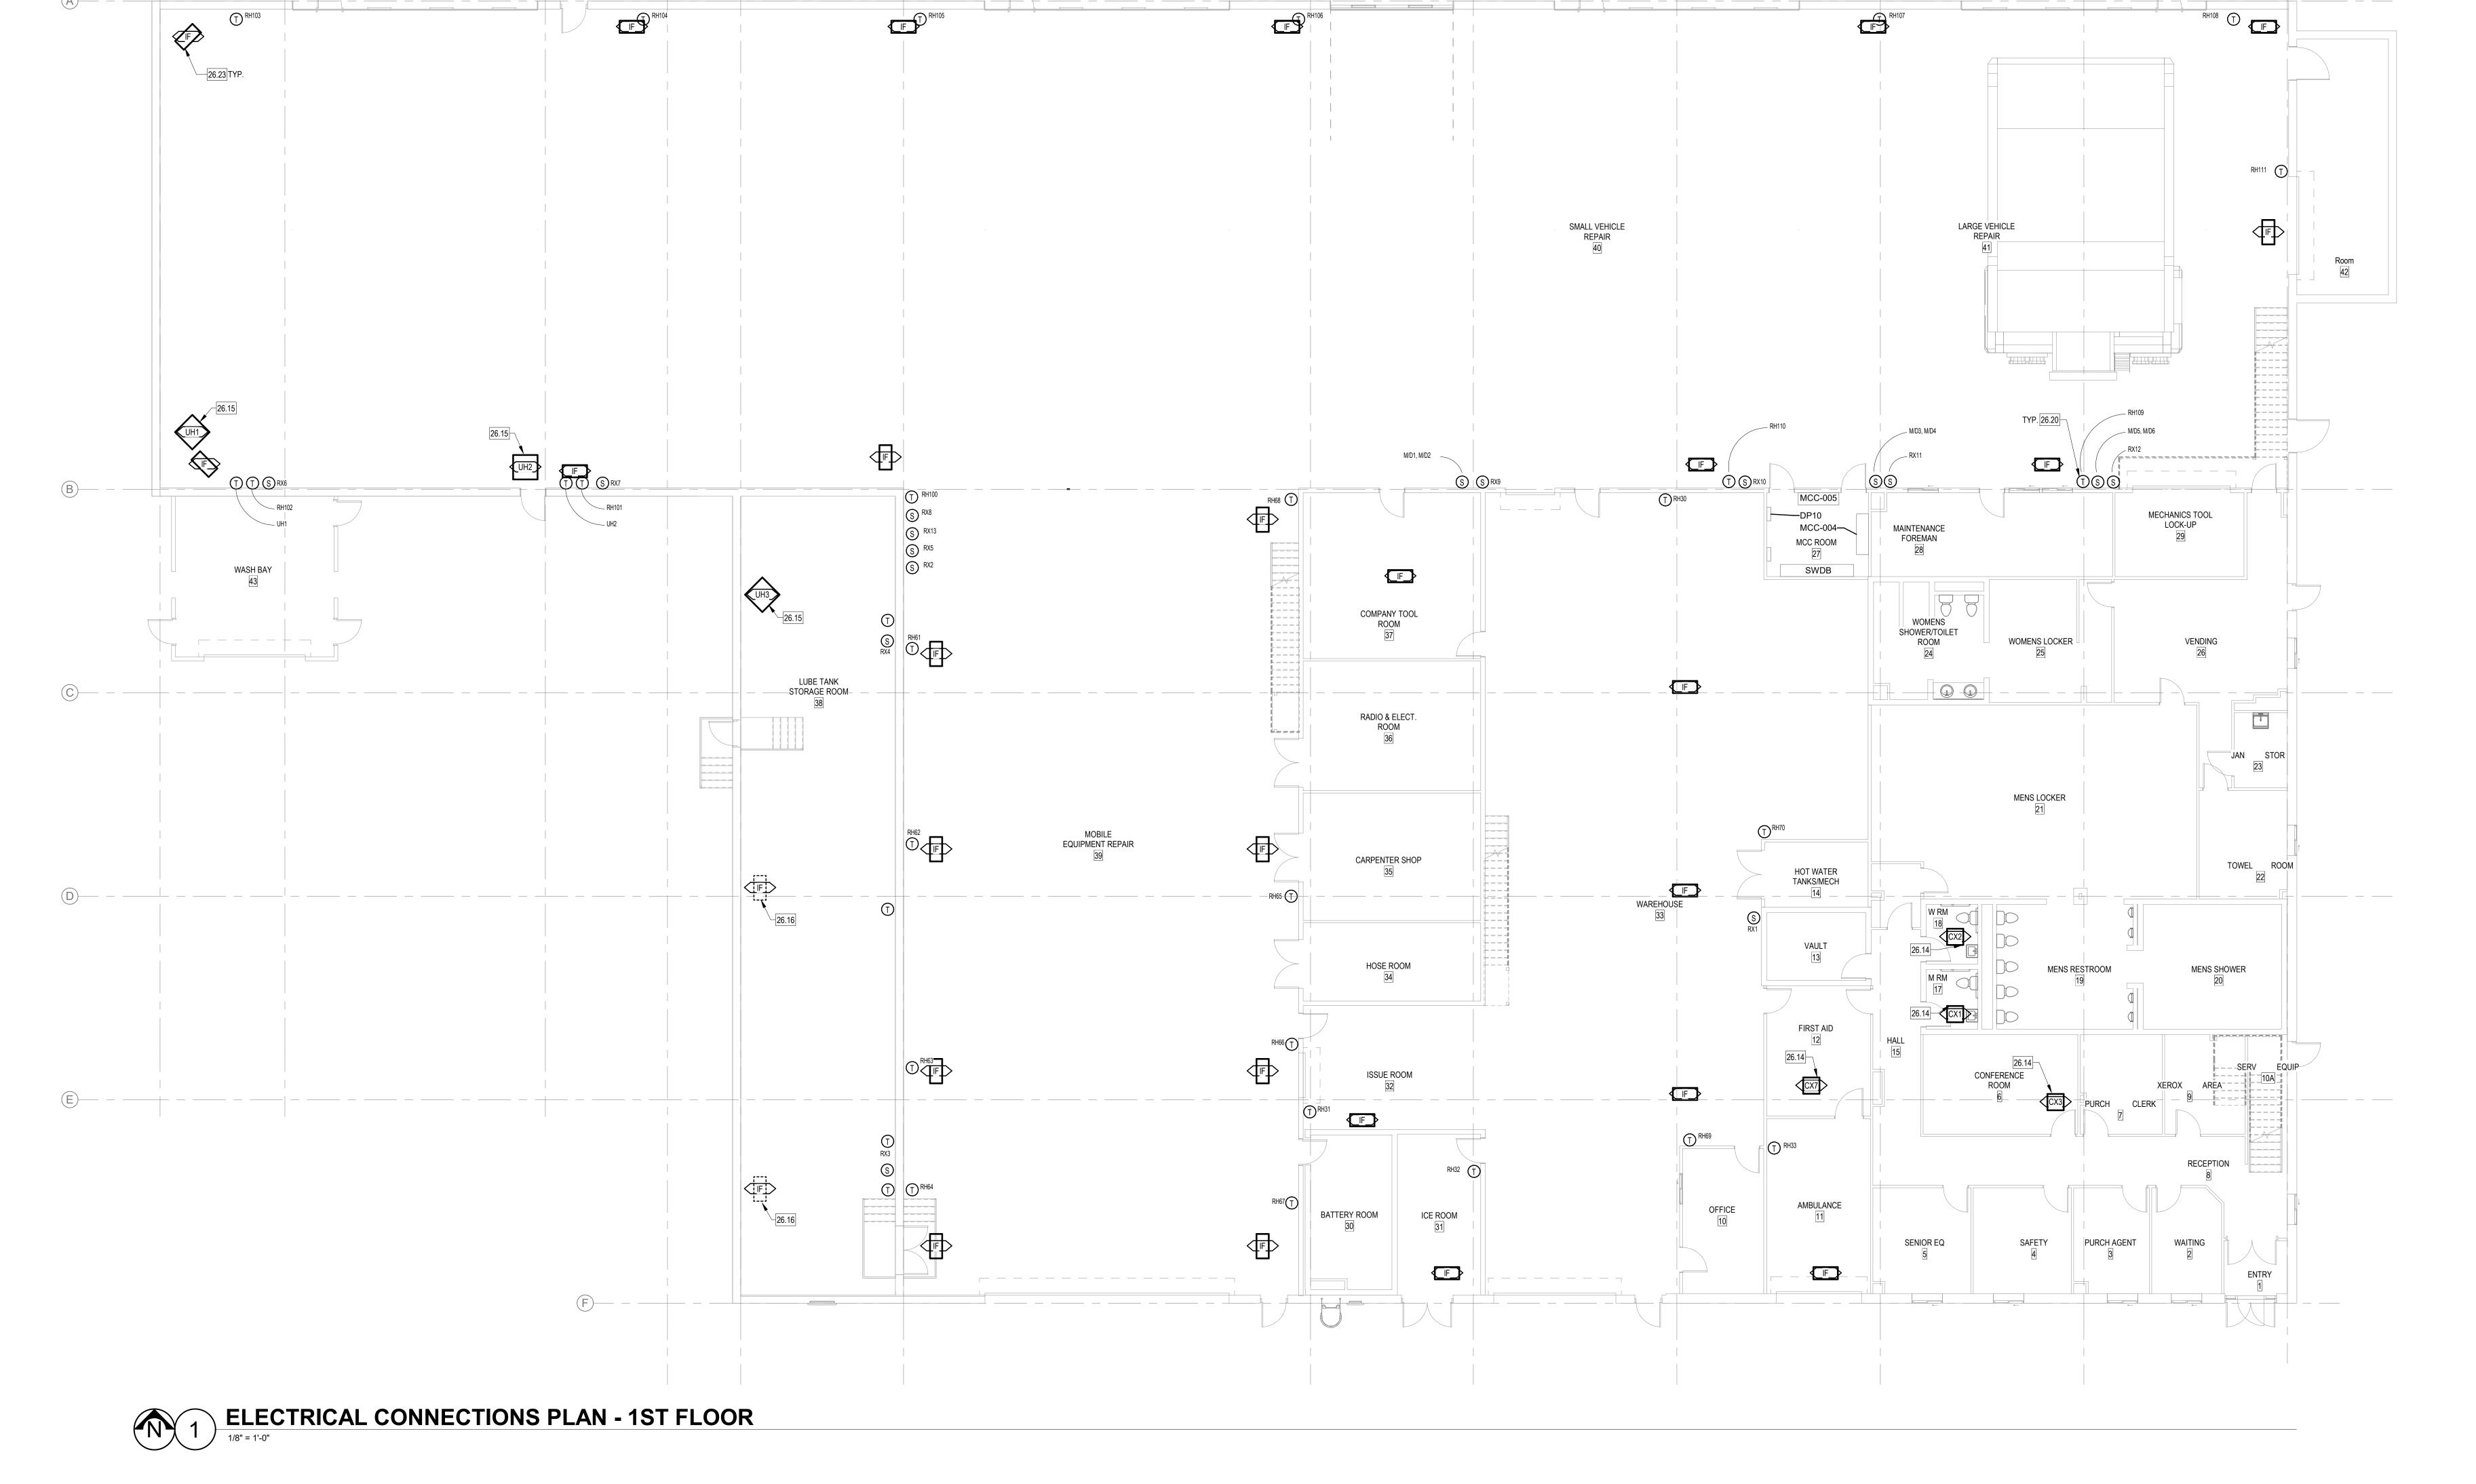

LIGHTING: PROVIDE ADDITIONAL CONDUCTORS AND PATHWAYS AS REQUIRED FOR LIGHTING AND CONTROLS WORK.

PATCH AND REPAIR: PATCH, PAINT, AND REPAIR ALL SURFACES AFFECTED BY LIGHTING REPLACEMENT PER ARCHITECT. PROVIDE NEW 2X4 CEILING TILES WHERE FIXTURES ARE NOT BEING REPLACED.

KEYED NOTES

- 26.12 ALTERNATE BID: ROOFTOP UNIT TO BE REPLACED WITH LARGER UNIT. REPLACE CONDUCTORS, OVERCURRENT PROTECTION, AND UNIT DISCONNECT. EVALUATE CONDUIT FOR RE-USE. SEE MECHANICAL CONNECTIONS SCHEDULE.
- FAN TO BE REPLACED. RECONNECT NEW FAN. REUSE CONDUCTORS AND OVERCURRENT
- GAS-FIRED UNIT HEATERS TO BE REPLACED, TYPICAL. RECONNECT CIRCUIT TO NEW UNIT
- CONNECT MOTORIZED DAMPERS TO RX CIRCUIT AS SHOWN. CONNECT TO LINE VOLTAGE SWITCH SHOWN ON 1ST FLOOR PLAN. ALTERNATE BID: ROOFTOP UNIT TO BE REPLACED WITH UNIT OF DIFFERENT VOLTAGE. DEMOLISH EXISTING CONDUCTORS BACK TO PANEL AND TURN BREAKER OFF. PROVIDE NEW CIRCUIT TO AS SHOWN ON MECHANICAL CONNECTIONS SCHEDULE.

+ ASSOCIATES ARCHITECTURE

> 1140 MAIN AVE, STE. B DURANGO, CO 81301 (970) 259 - 7494 FAX (970) 259 - 7492 262 PAGOSA STREET, STE. 200

PAGOSA SPRINGS, CO 81147

ENGINEERING

RA-AE.COM

EXPRESSLD'S ASH + ASSOCIATES, P.C.

EXPRESSLY RESERVES THE COMMON LAW COPYRIGHT
AND OTHER PROPERTY RIGHTS IN THESE PLANS. THESE
PLANS ARE NOT TO BE CHANGED OR COPIED IN ANY
FORM OR MANNER WHATSOEVER NOR ARE THEY TO BE
ASSIGNED TO ANY THIRD PARTY WITHOUT FIRST
OBTAINING WRITTEN PERMISSION AND CONSENT OF
THE ARCHITECT OF RECORD. THE USE OF THESE PLANS AND SPECIFICATIONS SHALL BE RESTRICTED TO THE ORIGINAL SITE FOR WHICH THEY WERE PREPARED AND PUBLICATION TEHREOF IS EXPRESSLY LIMITED TO SUCH USE. FEDERAL LAW PROHIBITS THE REPRODUCTION, DISPLAY, SALE OR OTHER DISPOSITION OF THIS DOCUMENT WITHOUT THE EXPRESS WRITTEN CONSENT OF RA+A ARCHITECTS, P.C.




2023-05-11

ISSUE RECORD:

2023-02-17 100% SD 2023-03-31 DD 2023-05-15 CD

REVISIONS:

ELECTRICAL CONNECTIONS PLAN - 2ND FLOOR

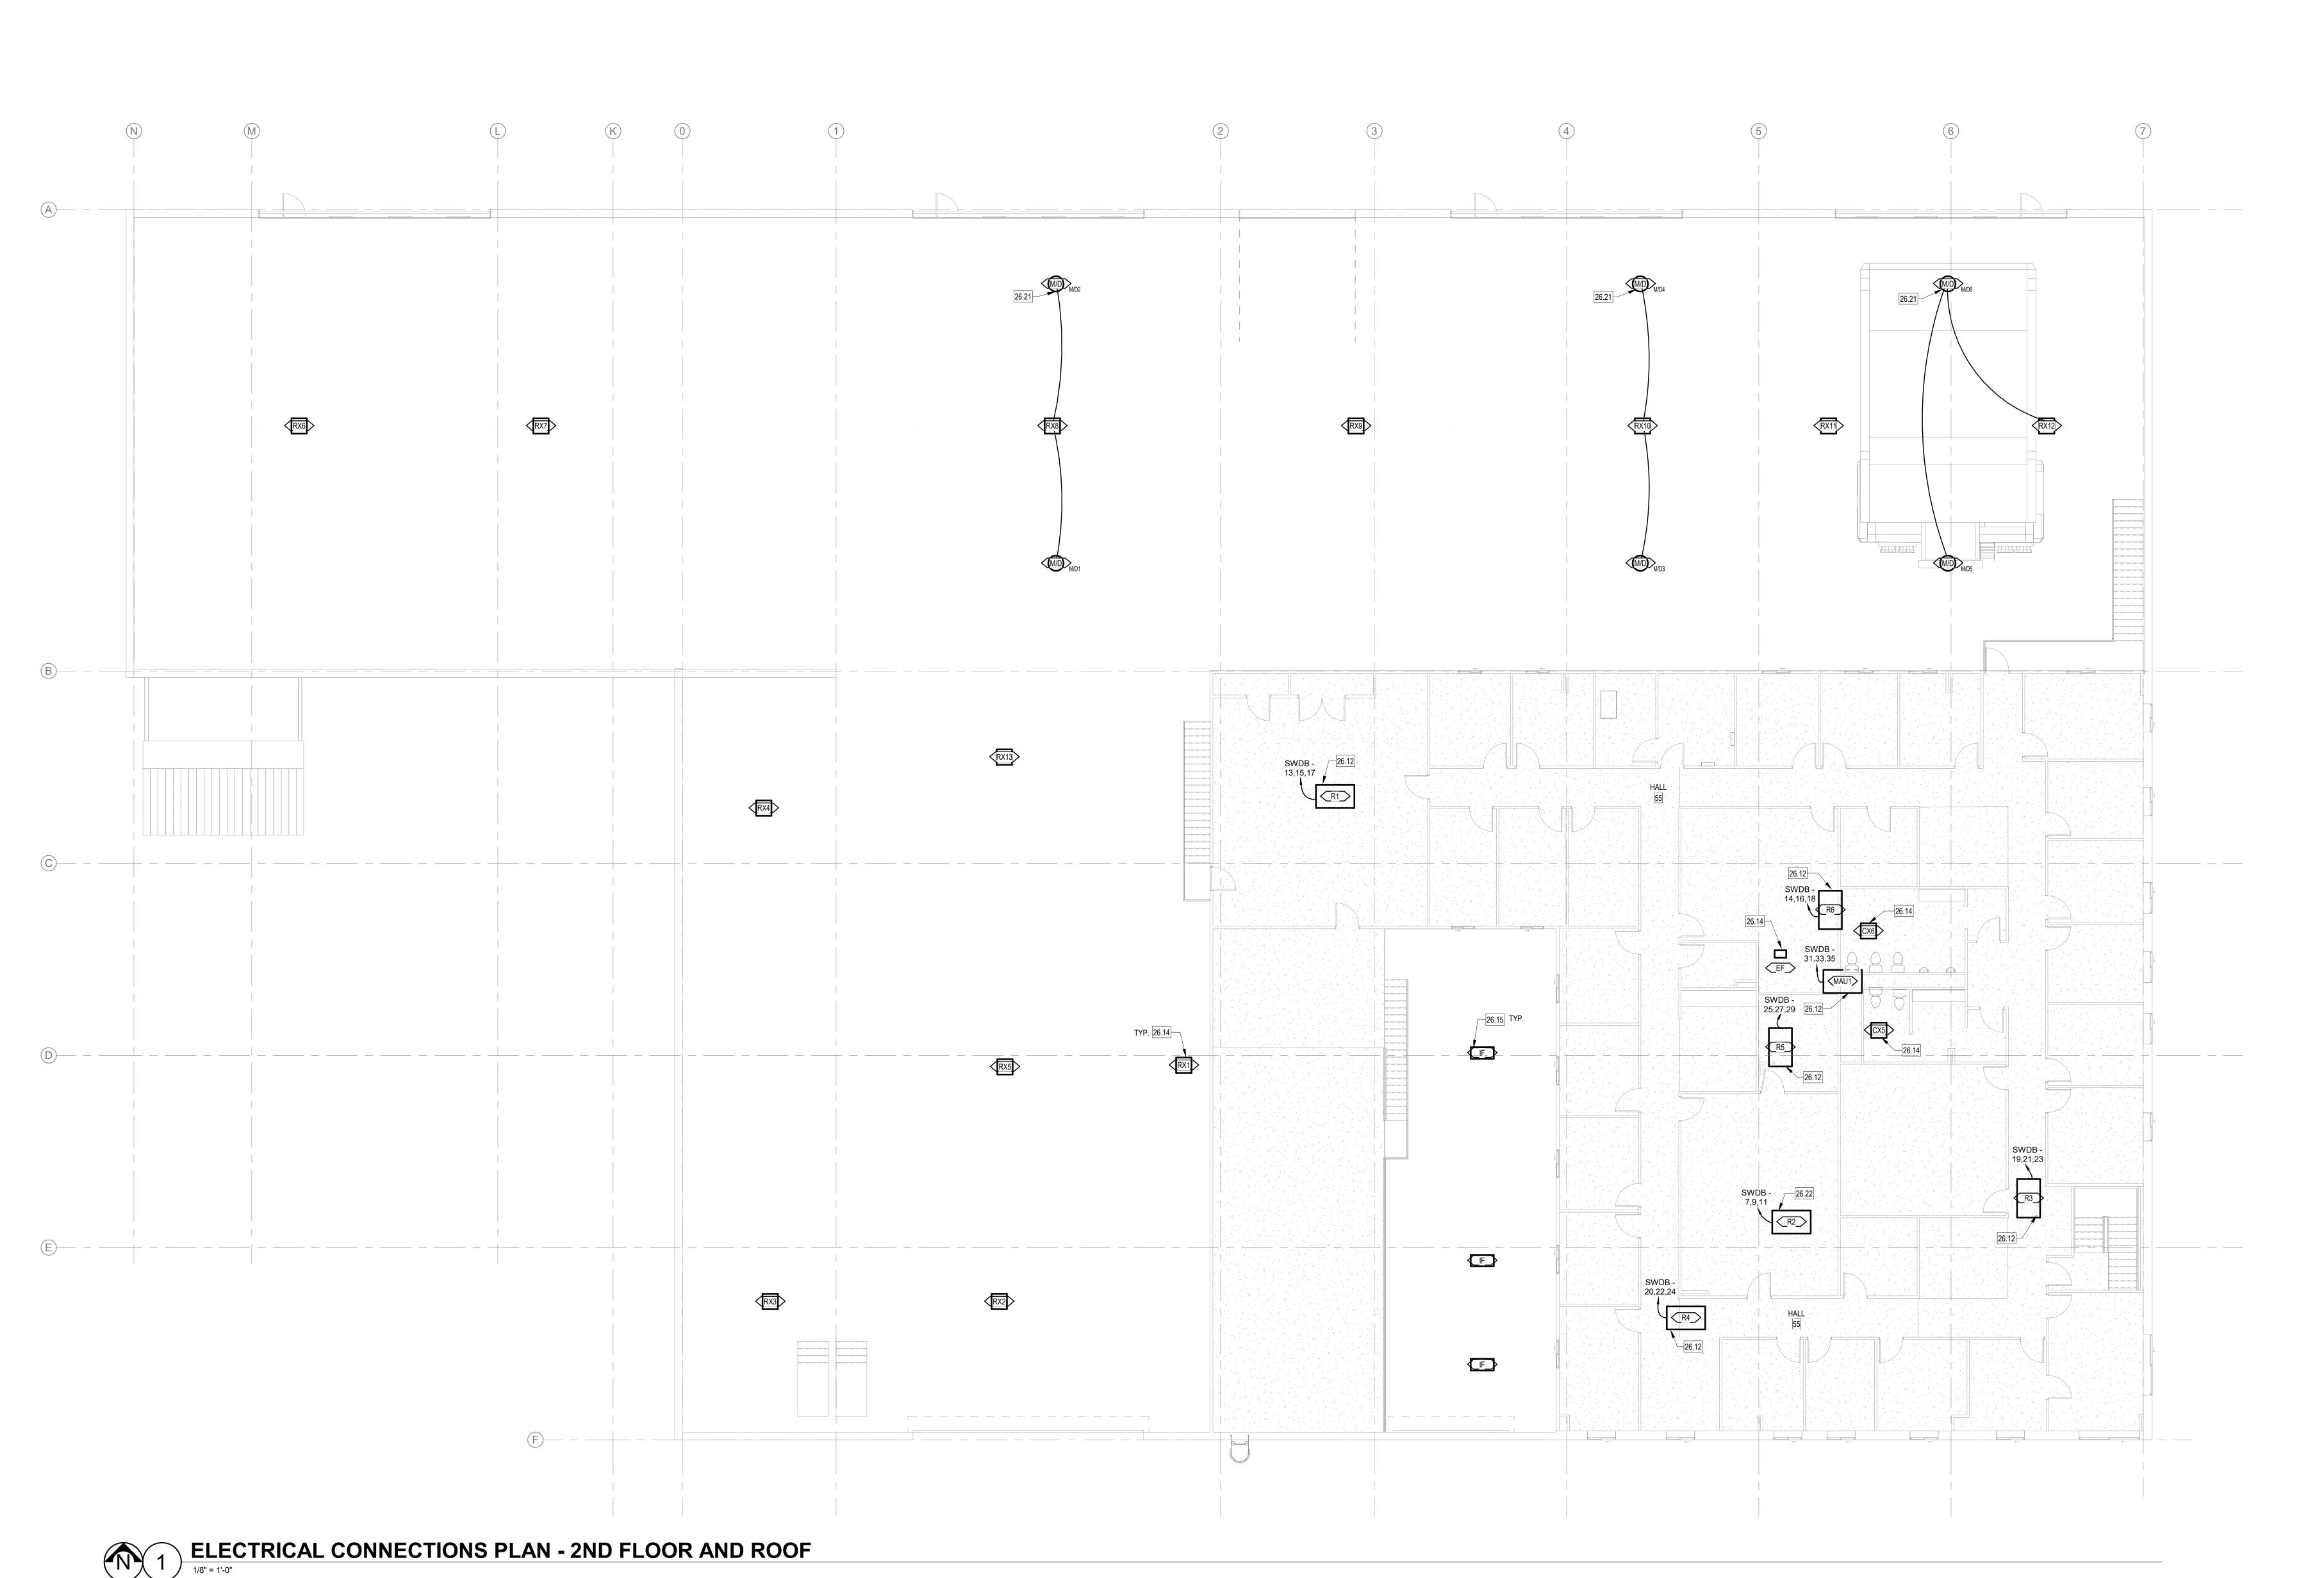

GENERAL CONTRACTOR AND DIVISION 28 CONTRACTOR PRIOR TO ROUGH-IN. 2. SPECIAL SYSTEMS CONTRACTOR RESPONSIBLE FOR ALL POWER SUPPLIES, 12/24V WIRING, POE WIRING. DEVICES, PROGRAMMING, AND SOFTWARE TO COMPLETE THE ACCESS CONTROL SYSTEM. ELECTRICAL CONTRACTOR RESPONSIBLE FOR CIRCUITING ALL DIVISION 08 POWER SUPPLIES. COORDINATE WITH DIVISION 08 SPECIFICATIONS PRIOR TO BIDDING. . CONTROLS J-BOX, POWER SUPPLIES, AND ADA OPERATOR POWER SUPPLIES TO BE ON SECURE SIDE PATHWAY DIAGRAMS BELOW ARE TO PROVIDE GENERAL PATHWAYS FOR ACCESS CONTROL. IF SPECIAL SYSTEMS CONTRACTOR'S REQUIREMENTS DIFFER FROM DIAGRAMS BELOW. SPECIAL SYSTEMS CONTRACTOR IS RESPONSIBLE TO COORDINATE PATHWAY AND CIRCUITING REQUIREMENTS WITH GENERAL CONTRACTOR PRIOR TO BIDDING. PATHWAY FOR --CIRCUIT POWER SUPPLY PER ELECTRIC STRIKE MANUFACTURER'S 120V POWER TO CONTROLLER OR-AND REQUEST TO RECOMMENDATIONS DIRECTLY TO OPERATOR MAGNETIC DOOR -- 12"X12"X4" J-BOX WITH COVER POSITION SWITCH 3/4" CONDUIT → PS I -1" CONDUIT TO SECURITY ROOM -ACCESSIBLE CEILING —3/4" CONDUIT 3/4" CONDUIT-CONNECTION TO **ELECTRIC STRIKE** -2 GANG BACKBOX, 2 GANG BACKBOX, OR ELECTRIC UNSECURE SIDE SECURE SIDE RETRACTION SINGLE GANG J-BOX -─MORTAR GUARD FOR ACCESS CONTROL MORTAR GUARD-DOUBLE LEAF DIAGRAM ADA PATHWAY DIAGRAM TYPICAL DOOR PATHWAY DETAIL

	LIGHTING C	ONTRO	DL SC	ENARI	O SCH	EDUL	E.			
	: 1. Shop drawings showing all device locations and types to be submitted with lighting subm ght sensing, sensor locations and quantities shown should be considered approximate. Cont									
LC	DESCRIPTION	APPLIES TO	OCCUPANCY SENSING	SENSOR COVERAGE	CONTROL ZONES	MANUAL DIMMING	MANUAL SWITCHING	SCENE SELECTOR	SCHEDULED ON/OFF	DAYLIGHT SENSING
LC.02	CONTROL BY LOCAL DEVICES AND SENSORS ONLY. PROVIDE OCCUPANCY SENSOR AND WITH SEPERATE DIMMER. SENSOR CONTROL SHALL BE MANUAL ON / AUTO OFF.	OFFICES, BREAKROOMS	Yes	MINOR MOTION	1	Yes	Yes	No	No	No
LC.03	CONTROL BY LOCAL DEVICES AND SENSORS ONLY. PROVIDE MANUAL OVERRIDE SWITCH AT ENTRANCE. SENSOR CONTROL SHALL BE AUTO ON / AUTO OFF.	MULTI-OCCUPAN T RESTROOMS	Yes	MAJOR MOTION	1	No	Yes	No	No	No
LC.04	CONTROL BY LOCAL DEVICES ONLY. PROVIDE WALLBOX OCCUPANCY SENSOR WITH INTEGRAL SWITCH (OR HIGH CORNER MOUNT SENSOR WITH SEPERATE SWITCH). SENSOR CONTROL SHALL BE AUTO ON / AUTO OFF.	STORAGE, UTILITY, SINGLE OCCUPANT RESTROOMS	Yes	MAJOR MOTION	1	No	Yes	No	No	No
LC.05	CONTROL BY LOCAL DEVICES AND SENSORS ONLY. PROVIDE MANUAL SWITCH AT EACH ENTRANCE. AUTOMATIC SHUTOFF NOT PROVIDED DUE TO SAFETY RISK.	ELEC, MECH ROOMS, KITCHENS	No	N/A	1	No	Yes	No	No	No
LC.06	CONTROL BY LOCAL DEVICES AND SENSORS ONLY. PROVIDE CEILING OR HIGH CORNER MOUNT SENSORS. PROVIDE MANUAL OVERRIDE SWITCH AT EACH ENTRANCE. SENSOR CONTROL SHALL BE AUTO ON / AUTO OFF.	SMALL CORRIDORS	Yes	MAJOR MOTION	1	No	Yes	No	No	No

ELECTRICAL SYMBOLS LEGEND LIGHTING **ABBREVIATIONS** COMMUNICATIONS DATA OUTLET RECTANGULAR FIXTURE. CEILING MOUNTED — ABOVE FINISHED FLOOR (DIMENSIONS AS SHOWN) — ANALOG PHONE OUTLET AFG — ABOVE FINISHED GRADE ROUND FIXTURE, CEILING MOUNTED — COMBINATION DATA & ANALOG PHONE OUTLET — ARCHITECTURAL (DIMENSIONS AS SHOWN) SUBSCRIPT INDICATES ABOVE COUNTER MOUNTING — BELOW COUNTER TRACK LIGHTING (LENGTH AS SHOWN, HEADS NOT TO — CONDUIT $\Delta \Delta \Delta$ SUBSCRIPT INDICATES QUANTITY OF PORTS (IF MORE THAN 1 — ELECTRICAL CONTRACTOR — ELECTRICAL SUBSCRIPT INDICATES SPECIFIC CABLE (H=HDMI, V=VGA) POLE MOUNTED FIXTURE (HEADS NOT TO SCALE) — ELECTRICAL METALLIC TUBING GC — GENERAL CONTRACTOR CIRCLE INDICATES FLUSH MOUNTING IN CEILING ARM SYMBOL ADDITION INDICATES WALL MOUNTING — GROUND ELECTRODE CONDUCTOR BOX INDICATES FLUSH MOUNTING IN FLOOR — GALVANIZED RIGID CONDUIT DIRECTION BEFORE PROCEEDING. DOT SYMBOL ADDITION INDICATES PENDANT MOUNTING — GROUND — GROUND FAULT INTERRUPTER MICROPHONE: CEILING, WALL AND FLOOR MOUNTED RESPECTIVELY HALF FILLED SYMBOL INDICATES EMERGENCY VERSION CONSTRUCTION AND FINISHES DAMAGED OR EXPOSED DURING DEMOLITION WORK. REPAIRS SHALL — INTERMEDIATE METALLIC CONDUIT SPEAKER: CEILING, WALL AND FLOOR MOUNTED RESPECTIVELY MATCH EXISTING FINISHES, AND INCLUDE PAINT ON ENTIRE WALL WHERE REQUIRED TO MATCH COLOR. LIGHTNING ARRESTOR EXIT SIGNS (FILL INDICATES NUMBER OF FACES) INTERCOM CONTROL SWITCH — MECHANICAL CONTRACTOR COMPLIANCE WITH ALL APPLICABLE, ADOPTED CODES; INCLUDING, BUT NOT LIMITED TO: THE NATIONAL WITH WITH DOUBLE MECH — MECHANICAL LIGHTS ARROW FACE SECURITY SYSTEM INFRARED MOTION SENSOR ELECTRICAL CODE (NEC), UBC, IBC, NFPA, AND ADA, IF ANY IF DISCREPANCIES ARE FOUND BETWEEN CONTRACT DOCUMENTS AND ANY ASSOCIATED LEGAL OR SAFETY REQUIREMENTS, CONTRACTOR SHALL NTS — NOT TO SCALE SUBMIT RFI TO ENGINEER FOR DIRECTION BEFORE PROCEEDING. 1. LOWER CASE LETTERS AFTER A COMMA IN THE FIXTURE DESIGNATION INDICATE SWITCHING. FOR EXAMPLE, "A3, b" INDICATES A A3 FIXTURE CONTROLLED BY SWITCH b. OVERHEAD ELECTRICAL FEEDER 2. A FIXTURE DESIGNATION ENDING IN "-E" INDICATES AN EMERGENCY FIXTURE, EVEN WHERE FIRE ALARM OVERHEAD PRIMARY FEEDER THE FIXTURE SYMBOL MAY BE TOO SMALL TO SHOW A HALF-FILL CLEARLY. COORDINATE WITH UTILITY COMPANY TO ENSURE THAT THEIR STANDARDS ARE BEING MET. IF ANY OVERHEAD SECONDARY FEEDER 3. DIMENSIONS AND MOUNTING HEIGHTS IN THE LIGHTING FIXTURE SCHEDULE SUPERCEDE DISCREPANCY IS FOUND BETWEEN UTILITY STANDARDS AND CONTRACT DOCUMENTS, SUBMIT RFI TO INFORMATION IMPLIED BY THESE SYMBOLS. SYMBOLS ARE FOR GENERAL REFERENCE ONLY. FACU FIRE ALARM (FA) CONTROL UNIT — POLYVINYL CHLORIDE FA ANNUNCIATOR FA ADA HORN/STROB — SAFE TORQUE OFF LOW VOLTAGE SWITCH, SEE SPECS AND LIGHTING CONTROL SCHEDULE SURGE PROTECTIVE DEVICE — 20A, 1 POLE TOGGLE SWITCH FA SPEAKER/STROBE FEEDERS AND BRANCH CIRCUITS. CONDUIT OR CABLE SHEATH IS NOT ALLOWED TO BE USED AS AN 20A, 3-WAY TOGGLE SWITCH EQUIPMENT GROUNDING CONDUCTOR, UNLESS EXPLICITLY CALLED FOR OR ALLOWED IN A PARTICULAR UNDERGROUND ELECTRICAL FEEDER — FA ADA STROBE — 20A, 4-WAY TOGGLE SWITCH LOCATION ON CONSTRUCTION DRAWINGS. UNDERGROUND PRIMARY FEEDER FA CEILING MOUNTED FA STROB — 20A, 1 POLE KEY OPERATED SWITCH UNINTERRUPTABLE POWER SUPPLY — 20A, NETWORKED SWITCH FA FIRE ALARM PULL STATION WEATHERPROOF THE APPLICATION AND ENVIRONMENT IN WHICH THEY ARE USED, AND FOR SPECIFIC TYPES, SIZES, AND DIMMER SWITCH FA FIRE/SMOKE DAMPER COMBINATIONS OF CONDUCTORS AND OTHER ITEMS CONNECTED. TRANSFORMER PUSHBUTTON SWITCH FA REMOTE INDICATOR — TIME CLOCK SWITCH FA FLOW DETECTOR/SWITCH PHOTOSENSOR REPLACED PANELS IS NOT ACCEPTABLE. FA SMOKE DETECTOR ROOM CONTROLLER (ABOVE CEILING) DUCT DETECTOR (S=SMOKE, CO=CARBON MONOXIDE) GRAY INDICATES EXISTING CEILING OCCUPANCY SENSOR (ARROWS INDICATE VIEW) DETECTOR (S=SMOKE, H=HEAT) SIZE AS PHASE CONDUCTOR(S). SHARED NEUTRALS ARE NOT ACCEPTABLE WITHOUT SPECIFIC WRITTEN DEVICE TO REMAIN WALL OCCUPANCY SENSOR (ARROWS INDICATE VIEW) CARBON MONOXIDE DETECTOR/ALARM DASHED INDICATES EXISTING DEVICE TO BE **POWER OUTLETS** DOOR CONTROLS SPECIFIC WRITTEN PERMISSION FROM ENGINEER. DASHED WITH "R" INDICATES EXISTING DEVICE TO BE SIMPLEX TYPE RECEPTACLE SITE PLAN AUTOMATIC DOOR OPENER BUTTON (A.D.A. OPENER) - 20A, 120V, DUPLEX RECEPTACLE 20A, 120V, FOURPLEX RECEPTACLE 2P-4W RECEPTACLE (SEE PANEL SCHEDULE FOR DETAILS) — UGP — UNDERGROUND ELECTRICAL PRIMARY FEEDER CENTER FILL INDICATES GROUND FAULT PROTECTION (AT RECEPT. OR EL -BREAKER, AS REQUIRED FOR ACCESSIBILITY) — UGE — UNDERGROUND ELECTRICAL FEEDER ELECTRIC STRIKE WEATHERPROOF IN USE COVER GROUND FAULT PROTECTED (AT MAGNETIC LOCK — UGC — UNDERGROUND COMMUNICATIONS RECEPT OR BREAKER, AS REQUIRED FOR ACCESSIBILITY) SUBSCRIPT INDICATES "ABOVE COUNTER" —— OHE —— OVERHEAD ELECTRICAL FEEDER KEY CARD/FOB READER SPECIAL RECEPTACLE INTERCOM SYSTEM WITH "BUZZ-IN" RELEASE —— OHP —— OVERHEAD ELECTRICAL PRIMARY FEEDER "BUZZ-IN" MOMENTARY BUTTON SIDE FILL INDICATES SPLIT WIRING — TV — UNDERGROUND TELEVISION CABLE PANIC BUTTON DURESS SYSTEM ARC INDICATES OCCUPANCY CONTROL ON PART OR ALL OF RECEPTACLE POWER SUPPLY T UNDERGROUND TELEPHONE CABLE ACCESS CONTROL SCENARIO IDENTIFICATION **NURSE CALL GENERAL NOTES** LARGE BOX INDICATES FLOOR MOUNT MULTI-GANG FLOOR BOX (P=1 GANG DUPLEX POWER, D1-4 = 1 GANG 1-4 DATA PORTS, H1=1 GANG MINI HDMI PULL CORD, WALL MOUNTED NO. OF GANGS 1ST GANG 2ND GANG ETC. M## -PULL CORD, CEILING MOUNTED MECHANICAL EQUIPMENT IDENTIFICATION CALL BUTTON KITCHEN EQUIPMENT IDENTIFICATION (SUBSCRIPT IS CIRCUIT INDICATOR LIGHT (LC.#) LIGHTING CONTROL SCENARIO IDENTIFICATION CONTROL STATION AC# DISCONNECT SWITCH ACCESS CONTROL SCENARIO IDENTIFICATION MOUNTING THERMOSTAT OUTLET BOX: SINGLE GANG BACK BOX, PLASTER RING (UNLESS OTHERWISE NOTED) 1/2" CONDUIT AND PULL ─WALL MOUNTED 90" TO TOP AND NOT LESS THAN 6" BELOW FINISHED CEILING WHERE REQUIRED CORD TO MECH UNIT. 80" TO BOTTOM AND NOT GREATER THAN 96" JUNCTION BOX, CEILING, WALL AND FLOOR MOUNTED, RESPECTIVELY BRANCH CIRCUIT PANEL BOARD, SEE SCHEDULE FOR MOUNTING 48" TO TOP AFF

NOT TO SCALE

WITH ARCHITECT PRIOR TO ROUGH-IN.

2. DIMENSIONS ARE TO TOP OF DEVICE WITH TRIM.

ADJUST BACK BOX LOCATION AS REQUIRED.

— PAD MOUNT TRANSFORMER

— WALL MOUNT TRANSFORMER

— CONDUIT STUB-OUT

SURGE PROTECTION DEVICE

GENERAL ELECTRICAL NOTES PRODUCT SUBSTITUTIONS: ALL PROPOSED PRODUCT SUBSTITUTIONS MUST BE SUBMITTED FOR APPROVAL PRIOR TO BIDDING. REFER TO DIVISION 1 SPECIFICATIONS FOR SUBSTITUTION REQUEST DEADLINE. REFER TO THE APPROPRIATE DIVISION 26 SPECIFICATION SECTION FOR DETAILED REQUIREMENTS FOR EACH TYPE OF PRODUCT. SUBSTITUTION REVIEWS WILL BE ISSUED IN ADDENDA TO ALL BIDDERS, NO LATER THAN FINAL ADDENDUM BEFORE BID DUE DATE. DIVISION 26 SCOPE: ALL LINE VOLTAGE WIRING AND CONDUIT SYSTEMS REQUIRED BY ANY DIVISION SHALL BE THE RESPONSIBILITY OF THE DIVISION 26 CONTRACTOR. EVERY ATTEMPT WILL BE MADE TO REFLECT THESE REQUIREMENTS ON THE ELECTRICAL SHEETS. BUT IT IS THE DIVISION 26 CONTRACTOR'S RESPONSIBILITY TO OBTAIN A COMPLETE DRAWING SET, FAMILIARIZE HIMSELF WITH THE COMPLETE REYNOLDS ASH PROJECT SCOPE, AND COORDINATE WITH OTHER DIVISIONS. + ASSOCIATES EXISTING CONDITIONS: THE CONTRACTOR SHALL CAREFULLY EXAMINE THE DRAWINGS AND SPECIFICATIONS, VISIT THE SITE OF THE WORK, FULLY INFORM HIMSELF AS TO ALL EXISTING CONDITIONS DIMENSIONS AND LIMITATIONS BEFORE STARTING WORK. IF DISCREPANCIES ARE FOUND BETWEEN EXISTING CONDITIONS AND CONTRACT DOCUMENTS. CONTRACTOR SHALL NOTIFY ENGINEER FOR

ARCHITECTURI ENGINEERIN 1140 MAIN AVE, STE. B DURANGO, CO 81301

FAX (970) 259 - 7492 262 PAGOSA STREET, STE, 200 PAGOSA SPRINGS, CO 81147 RA-AE.COM

EXPRESSLY RESERVES THE COMMON LAW COPYRIG PLANS ARE NOT TO BE CHANGED OR COPIED IN ANY ASSIGNED TO ANY THIRD PARTY WITHOUT FIRS THE ARCHITECT OF RECORD.

THE USE OF THESE PLANS AND SPECIFICATIONS SHA E RESTRICTED TO THE ORIGINAL SITE FOR WHICH THEY WERE PREPARED AND PUBLICATION TEHREOF PROHIBITS THE REPRODUCTION DISPLAY SALE OR GROUNDING CONNECTIONS: ALL GROUNDING AND BONDING CONNECTORS SHALL BE UL LISTED FOR RA+A ARCHITECTS P.C.

0. PANEL SCHEDULES: PROVIDE TYPED SCHEDULES FOR ALL PANELS, CONTAINING ALL NEW CIRCUITING

2023-05-11

3. MC CABLE: FLEXIBLE METALLIC CABLE (MC) IS ACCEPTABLE ONLY IN CONCEALED LOCATIONS, AND ONLY FOR CIRCUITS 20 AMPS OR LESS. SEE SPECIFICATIONS FOR DETAILED INSTALLATION

AS INSTALLED, AND ALL EXISTING CIRCUIT INFORMATION AVAILABLE TO CONTRACTOR. PRINTING

SCHEDULES FROM THE DRAWING SET IS NOT ACCEPTABLE; RE-ATTACHING OLD SCHEDULES FROM

I. NEUTRAL CONDUCTORS: PROVIDE DEDICATED NEUTRAL CONDUCTORS FOR ALL CIRCUITS, OF SAME

ROMEX: FLEXIBLE NONMETALLIC CABLE (ROMEX) IS NOT ACCEPTABLE IN ANY LOCATION WITHOUT

SURFACE REPAIR: COORDINATE WITH GENERAL CONTRACTOR FOR REPAIR OF ADJACENT

CODES: PERFORM ALL ELECTRICAL WORK IN A NEAT AND WORKMANLIKE MANNER IN FULL

UTILITY COORDINATION: WHEN INSTALLING OR MODIFYING SERVICE OR METERING EQUIPMENT,

STRUCTURAL PENETRATIONS: OBTAIN PERMISSION FROM STRUCTURAL ENGINEER BEFORE DRILLING

. GROUNDING CONDUCTORS: INSTALL WIRE-TYPE EQUIPMENT GROUNDING CONDUCTORS WITH ALL

14. ALL PENETRATIONS THROUGH FIRE RATED WALLS OR ASSEMBLIES SHALL BE COMPLETED IN A MANNER THAT MAINTAINS THE FIRE RATING OF THE WALL OR ASSEMBLY.

PERMISSION FROM ENGINEER.

GENERAL DEMOLITION NOTES

UNEXPECTED CONDITIONS: IF CONCEALED CONDITIONS ARE UNCOVERED THAT ARE AT VARIANCE WITH CONDITIONS SHOWN IN THE CONTRACT DOCUMENTS, OR OF AN UNUSUAL NATURE NOT ORDINARILY ENCOUNTERED IN WORK OF THIS KIND. CONTRACTOR SHALL INFORM THE ENGINEER FOR DIRECTION BEFORE PROCEEDING. NO CLAIM FOR ADDITIONAL COST OR TIME EXTENSION WILL BE ALLOWED WITHOUT PROPER NOTICE, PRIOR DETERMINATION OF COST OR TIME, AND EXPENSE TO THE

DEMOLITION SCOPE: THE DEMOLITION PLAN SHALL BE USED AS A SCHEMATIC GUIDE. IF ADDITIONAL DEMOLITION WORK OR INCREASED COST IS REQUIRED TO COMPLETE THE NEW CONSTRUCTION / REMODELING AS INDICATED ON THE DRAWINGS. CONTRACTOR SHALL INFORM THE ENGINEER FOR DIRECTION BEFORE PROCEEDING

SURFACE REPAIR: WHERE DIRECTED TO REMOVE EXISTING EQUIPMENT / DEVICES FROM AN ARCHITECTURAL SURFACE THAT IS TO REMAIN, CONTRACTOR IS RESPONSIBLE FOR ASSOCIATED REPAIR, PATCHING, AND PAINTING OF SURFACE TO MATCH EXISTING.

CONTRACTOR CAUSED DAMAGE: DAMAGE ON THE CONSTRUCTION SITE CAUSED BY THE CONTRACTOR OR A PARTY TO THE CONTRACTOR DURING THE DEMOLITION OR CONSTRUCTION PHASE SHALL BE REPAIRED PRIOR TO CONTRACT DATE OF SUBSTANTIAL COMPLETION AT NO ADDITIONAL EXPENSE TO THE OWNER.

REMOVED MATERIALS: UNLESS OTHERWISE NOTED IN DRAWINGS, ALL EXISTING REMOVED EQUIPMENT SHALL BE STOCKPILED AT THE SITE AT AN OWNER APPROVED LOCATION UNTIL AN INSPECTION BY THE OWNER'S REPRESENTATIVE DETERMINES WHAT WILL BE SALVAGED. ALL EQUIPMENT NOT SALVAGED SHALL BE HAULED OFF THE SITE BY THE CONTRACTOR.

MATERIALS TO BE REUSED: VERIFY THAT ALL ELECTRICAL EQUIPMENT, DEVICES, CONDUCTORS OR CONDUIT TO BE RELOCATED OR RECONNECTED ARE IN WORKING ORDER PRIOR TO ANY DEMOLITION WORK. IF THE EXISTING MATERIAL IS FOUND TO BE DEFICIENT, OR APPEARS TO BE AN INAPPROPRIATE SIZE OR TYPE, CONTRACTOR SHALL INFORM THE ENGINEER FOR DIRECTION BEFORE PROCEEDING.

MECHANICAL EQUIPMENT CONNECTION SCHEDULE

3. ALL MOUNTING HEIGHTS SHALL CONFORM TO THE LATEST

EDITION OF THE AMERICANS WITH DISABILITIES ACT. (ADA)

20" TO TOP AFF

5'-0" TO HANDLE

UNIT	DESCRIPTION	ELECTRICAL	HP	FLA	MCA	CB AT PANEL	DISC. AT UNIT	STARTER	PANEL	CIRCUIT#	CONDUCTORS/CONDUIT	NOTES
MAU1	MAKEUP AIR UNIT	480 V/3-3991 VA	3	4.8		15 A	30A-3P-NF	MC PROVIDED	SWDB	31,33,35	(3#12 & 1#12G)3/4"C	
R1	ROOFTOP UNIT	480 V/3-13510 VA		16.25	17	20 A	INTEGRAL	MC PROVIDED	SWDB	13,15,17	(3#12 & 1#12G)3/4"C	
R2	ROOFTOP UNIT	480 V/3-22862 VA		27.5	29	35 A	INTEGRAL	MC PROVIDED	SWDB	7,9,11	(3#10 & 1#10G)3/4"C	
R3	ROOFTOP UNIT	480 V/3-10392 VA		12.5	14	20 A	INTEGRAL	MC PROVIDED	SWDB	19,21,23	(3#12 & 1#12G)3/4"C	
R4	ROOFTOP UNIT	480 V/3-10392 VA		12.5	14	20 A	INTEGRAL	MC PROVIDED	SWDB	20,22,24	(3#12 & 1#12G)3/4"C	
R5	ROOFTOP UNIT	480 V/3-11431 VA		13.75	15	20 A	INTEGRAL	MC PROVIDED	SWDB	25,27,29	(3#12 & 1#12G)3/4"C	
R6	ROOFTOP UNIT	480 V/3-10392 VA		12.5	14	20 A	INTEGRAL	MC PROVIDED	SWDB	14,16,18	(3#12 & 1#12G)3/4"C	
UH1	UNIT HEATER	120 V/1-1320 VA		11		20 A	STO	INTEGRAL			(2#12 & 1#12G)3/4"C	
UH2	UNIT HEATER	120 V/1-1320 VA		11		20 A	STO	INTEGRAL			(2#12 & 1#12G)3/4"C	
UH3	UNIT HEATER	120 V/1-288 VA		2.4		20 A	STO	INTEGRAL			(2#12 & 1#12G)3/4"C	

LIGHTING FIXTURE SCHEDULE

TYPE	DESCRIPTION	MOUNTING	HEIGHT	MAKE	MODEL	LAMP	WATTS	BATTERY	LUMENS	OPTIC	CRI	NOTES
8'	1x8 SURFACE LENSED	WALL		COLUMBIA	LSRK	LED	55	NONE	6200			
В	WALL-MOUNT AREA LIGHT	WALL	~30'	BEACON	VP3	LED	250	NONE	30000	TYPE CORNER		
D	WALL-BACK	WALL		BEACON	RWL1	LED	25	INTERGRAL	3000	TYPE 4 WIDE		
Е	EXIT SIGN	UNIVERSAL		COMPASS	CE	LED	3	INTERGRAL	N/A	N/A	N/A	
EM	EMERGENCY LIGHT			COMPASS	CC SQ	LED	4	INTERGRAL		N/A	N/A	
G	EXTERIOR WALLPACK	WALL	VARIES	BEACON	RWL2	LED	80	INTERGRAL	10000	TYPE 4 WIDE		
J	2x4 LENSED	RECESSED - GRID	CEILING	COLUMBIA	LCAT24	LED	32	NONE	4000			
К	1x4 SURFACE LENSED	SURFACE	CEILING	COLUMBIA	CWP4	LED	37	NONE	4500			
М	ALT BID: HIGH-BAY PENDANT	PENDANT	CEILING	COLUMBIA	CRB	LED	150	NONE	21000	DIFFUSE		
N	ALT BID: HIGH-BAY PENDANT	PENDANT	CEILING	COLUMBIA	CRB	LED	200	NONE	28000	DIFFUSE		
Р	LOW-BAY PENDANT	PENDANT		COLUMBIA	ECH	LED	55	NONE	9000	DIFFUSE 120		
Т	1x4 SURFACE LENSED	SURFACE	CEILING	COLUMBIA	LCS	LED	20	NONE	2500			
U	1x4 SURFACE LENSED - WET LISTED	SURFACE	CEILING	COLUMBIA	W3B	LED	25	NONE	3000			
V	1x4 SURFACE WALL MOUNT	WALL	7'6"	COLUMBIA	CWM	LED	25	NONE	3000			

JOB. NO.: 2023-05-15 DRAWN BY: ME&E ISSUE RECORD: 2023-02-17 100% SD 2023-03-31 DD

2023-05-15 CD REVISIONS:

ELECTRICAL LEGEND, NOTES, AND DETAILS